

SIT	E PREPARATION NOTES:
(1)	REMOVE AND SALVAGE CHAIN LINK FENCE.
$\overline{2}$	REMOVE AND DISPOSE SIGN AND POST. SEE NEW SIGN LOCATIONS ON PS SHEETS.
(3)	REMOVE AND DISPOSE WOOD BOARD FENCE.
$\check{4}$	REMOVE EXISTING WALL, STRUCTURE OR OBSTRUCTION AS INDICATED.
(5)	REMOVE AND DISPOSE SPLIT RAIL FENCE.
6	REMOVE TREE. TREE SHALL BE FLAGGED AND ASSESSED BY ARBORIST OR PROJECT REPRESENTATIVE PRIOR TO REMOVAL.
\bigcirc	RETAIN TREE WITHIN CLEARING AND GRUBBING LIMITS PER ARBORISTS' ASSESSMENT.
(ā)	REMOVE TREE WITHIN CLEARING AND GRUBBING LIMITS.
0	PRUNE TREE FOR 10' MIN VERTICAL CLEARANCE. ARBORIST SHALL BE ON SITE TO MONITOR THE PRUNING ACTIVITY.
(10)	NOT USED.
Ŭ	PRESERVE AND MONITOR TREE. IF TREE REMOVAL IS DEEMED NECESSARY BY THE PROJECT REPRESENTATIVE AND ARBORIST, TREE SHALL BE FLAGGED PRIOR TO REMOVAL.
(12)	REMOVE DEAD STEM.
	REMOVE AND SALVAGE WOOD GUARDRAIL.
$\overline{14}$	REMOVE AND DISPOSE STAIRS, TYPE AS INDICATED. SEE NEW LOCATIONS ON AL SHEETS.
(15)	REMOVE AND SALVAGE GATE.
(16)	NOT USED.
(17)	RESET STREAM GAUAGE, SEE UT SHEETS.
(18) (19)	RETAIN STAIRS WITHIN CLEARING AND GRUBBING LIMITS. ACCESS MUST BE MAINTAINED OR PROVIDE TEMPORRY ACCESS DURING CONSTRUCTION. REMOVE EXISTING STRUCTURE OR OBSTRUCTION AS
(1)	INDICATED, BY OTHERS. REMOVE AND SALVAGE TRASH BAG DISPENSER/TRASH
\asymp	CAN.
	NOT USED.
(22)	PRESERVE STRUCTURE.
(23)	NOT USED.
24	NOT USED.
(25)	REMOVE AND DISPOSED WOOD BRIDGE.
(26)	NOT USED.
27)	REMOVE AND DISPOSE HOG WIRE FENCE.
GE	NERAL NOTES:
F	SEE UT SHEETS FOR EXISTING UTILITIES, UTILITY RELOCATION AND ADJUSTMENTS, AND DRAINAGE MPROVEMENTS.
2. S	SEE TE SHEETS FOR EROSION CONTROL AND OTHER TEMPORARY CONSTRUCTION MEASURES.
	GEND:
17	



REMOVE EXISTING GRAVEL SURFACE REMOVE ASPHALT CONCRETE PAVEMENT REMOVE CEMENT CONCRETE PAVEMENT

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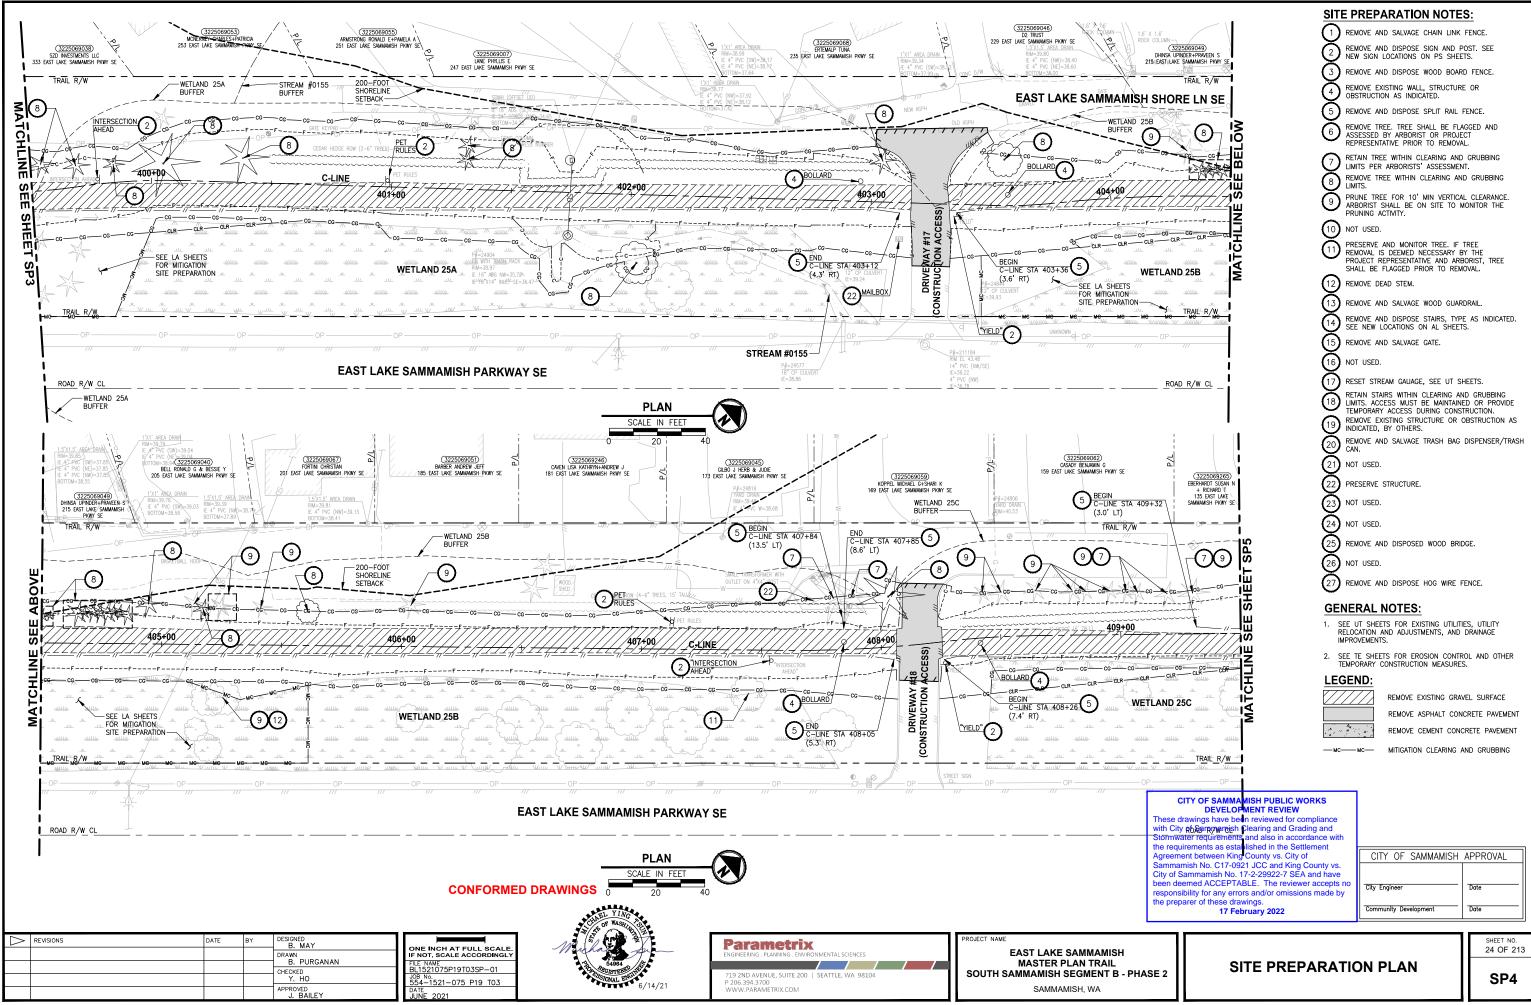
MITIGATION CLEARING AND GRUBBING


CITY OF SAMMAMISH	APPROVAL
City Engineer Community Development	Date


SITE PREPARATION PLAN


SHEET NO. 23 OF 213


SP3




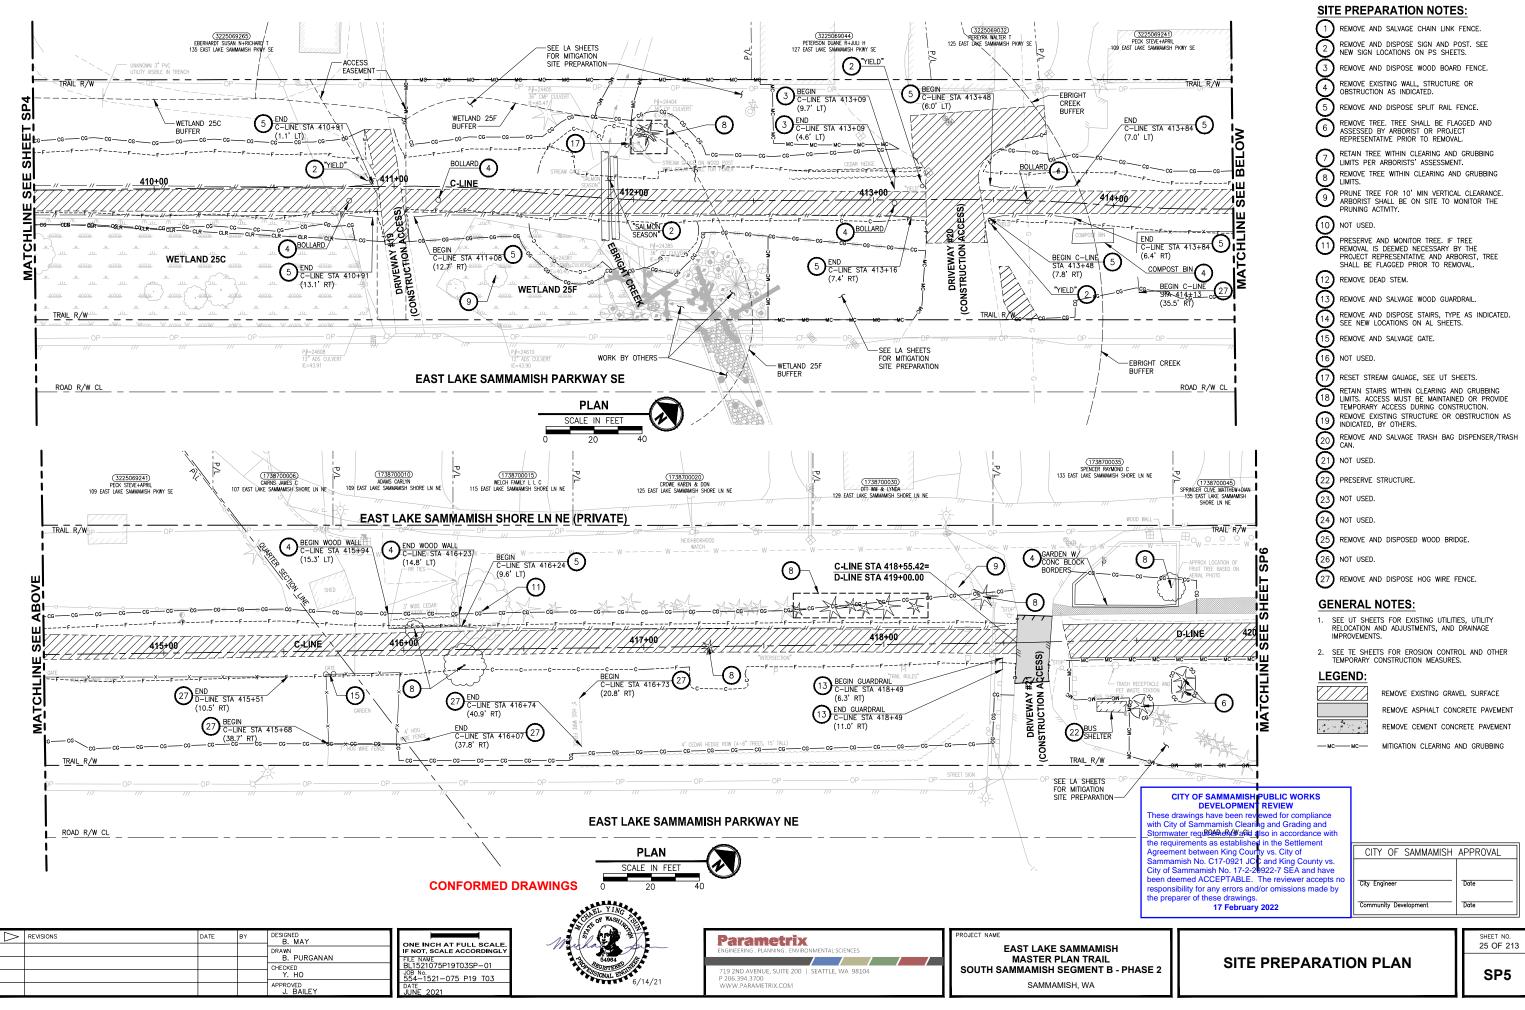

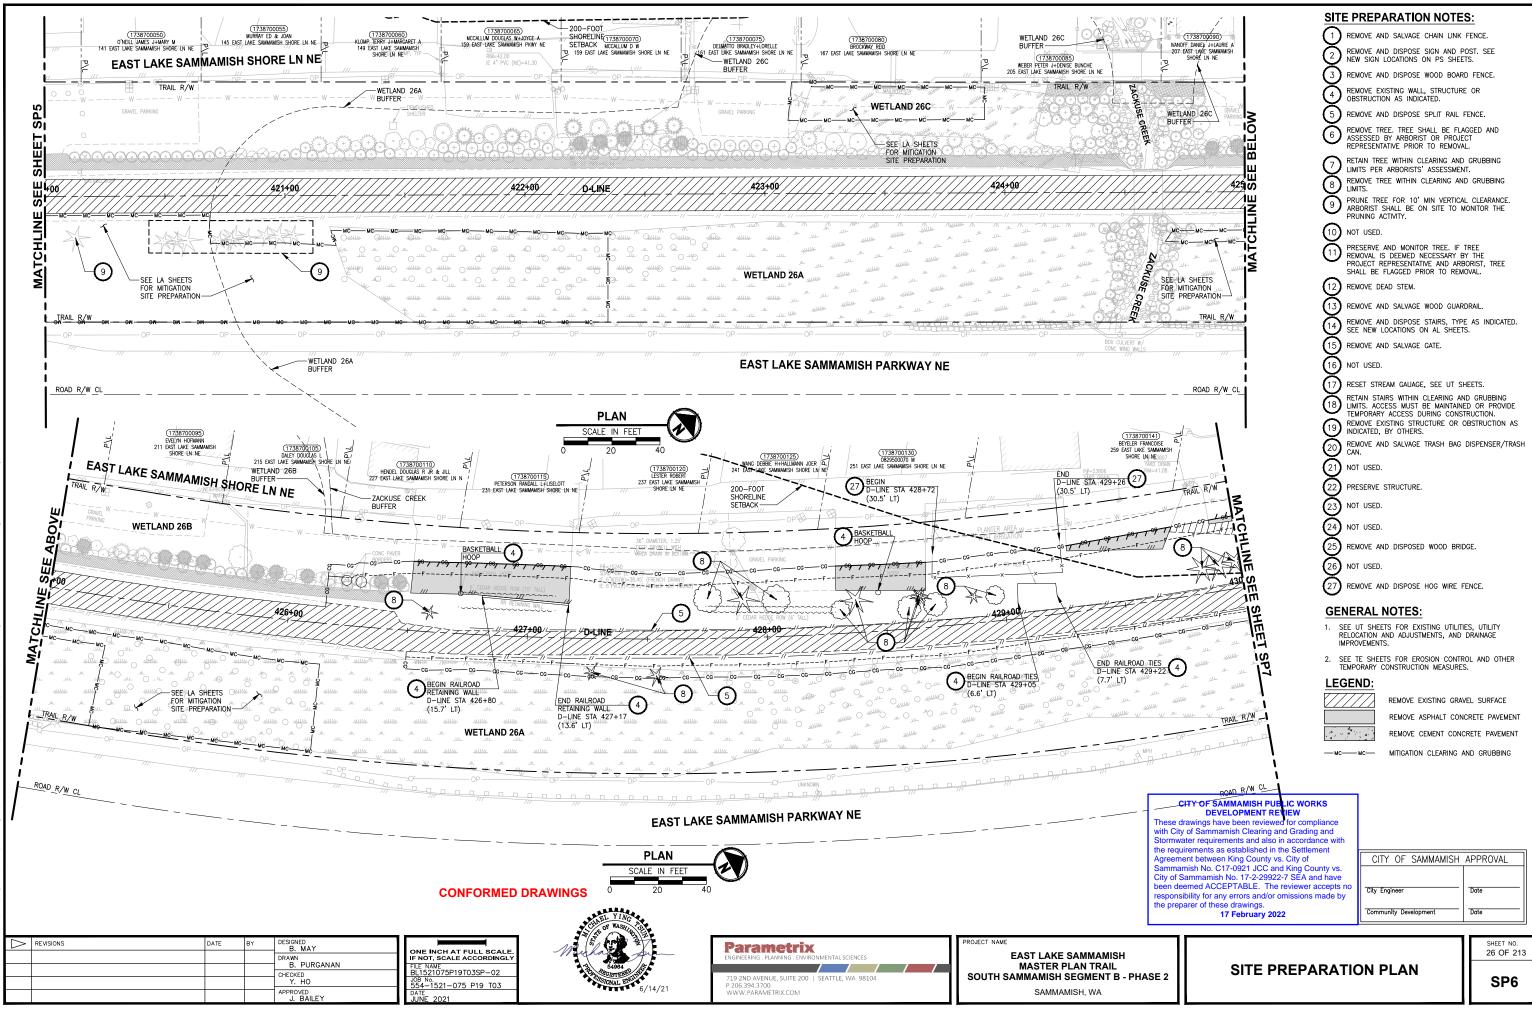

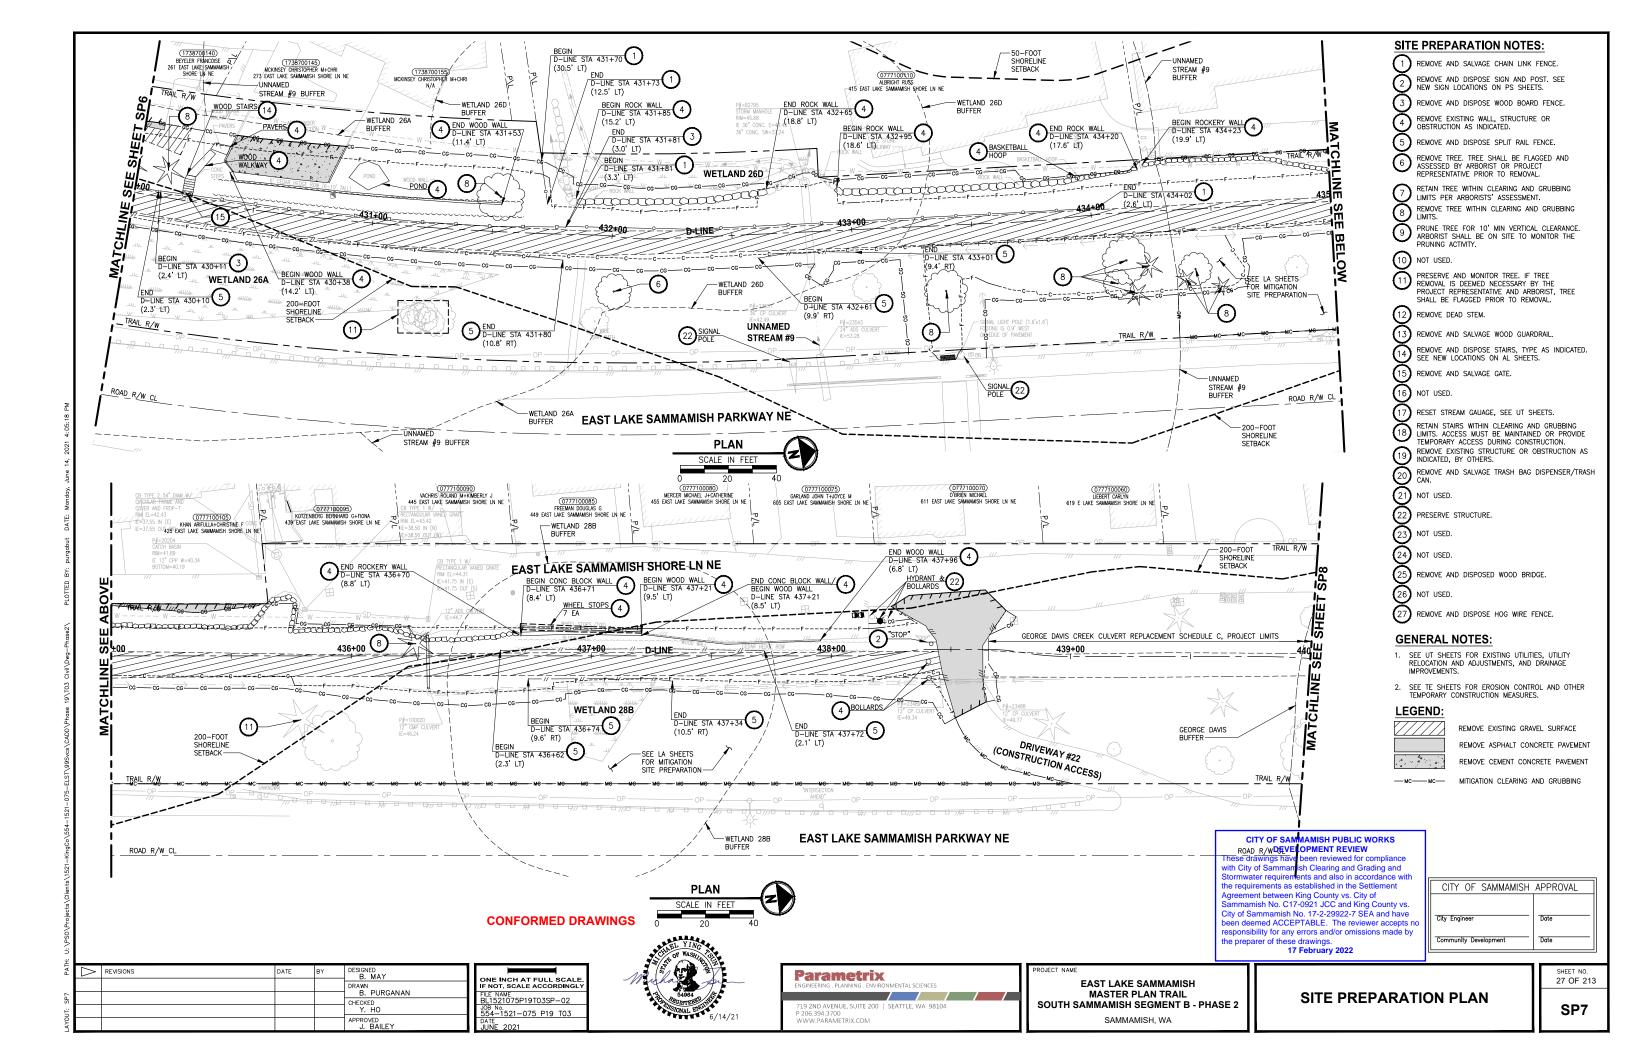

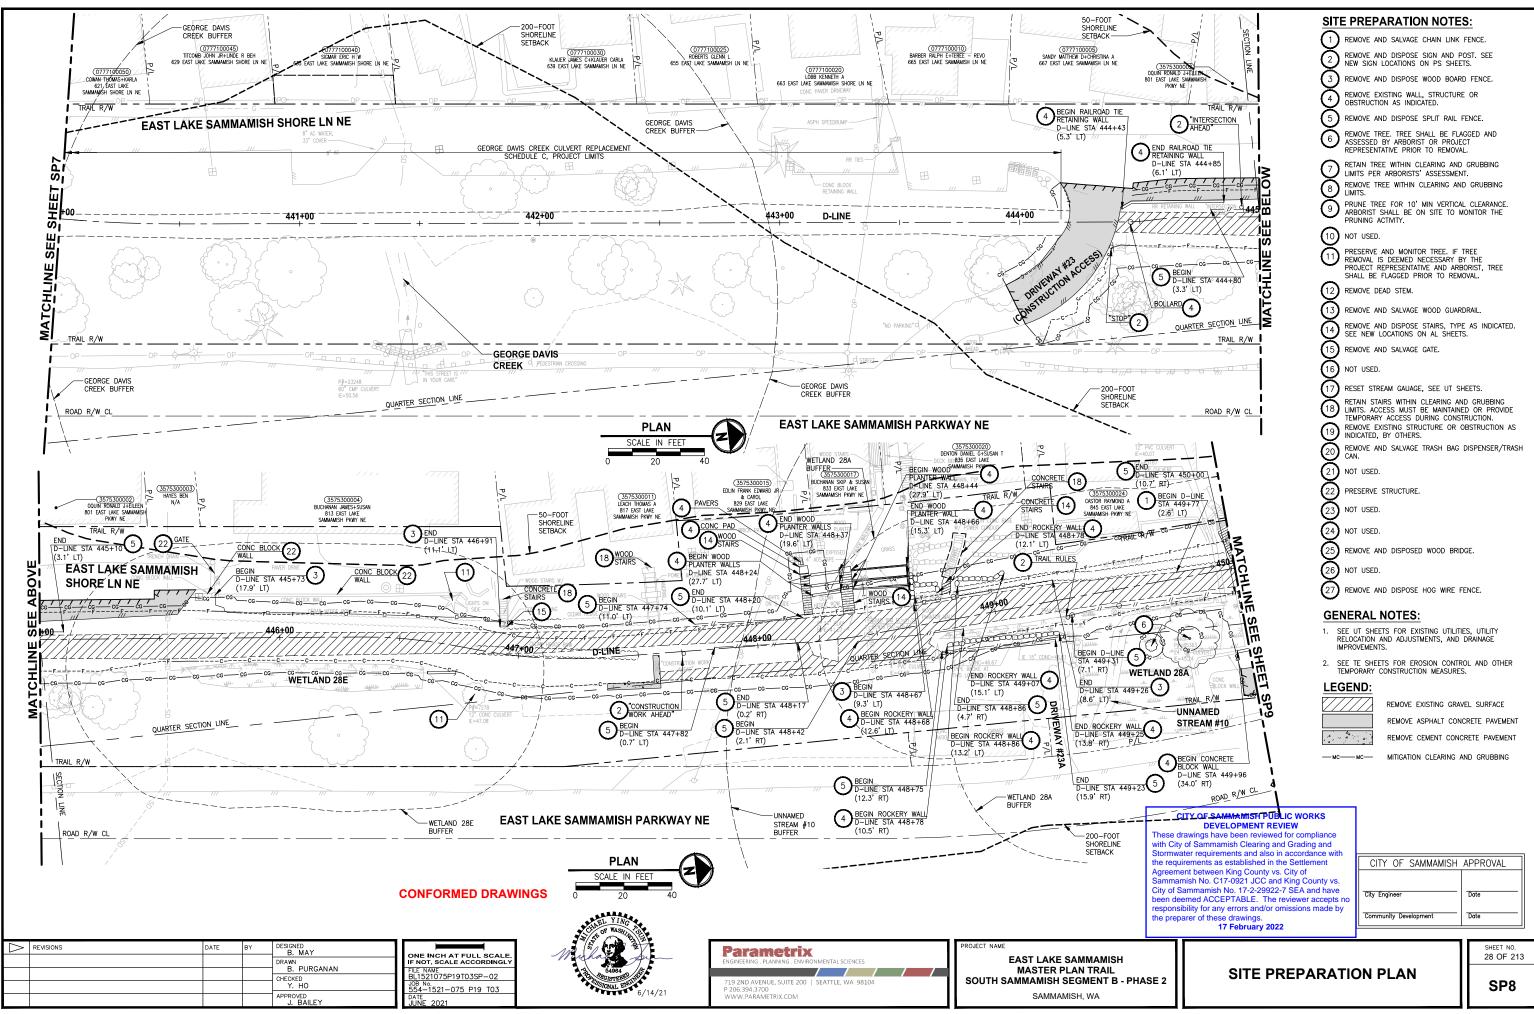

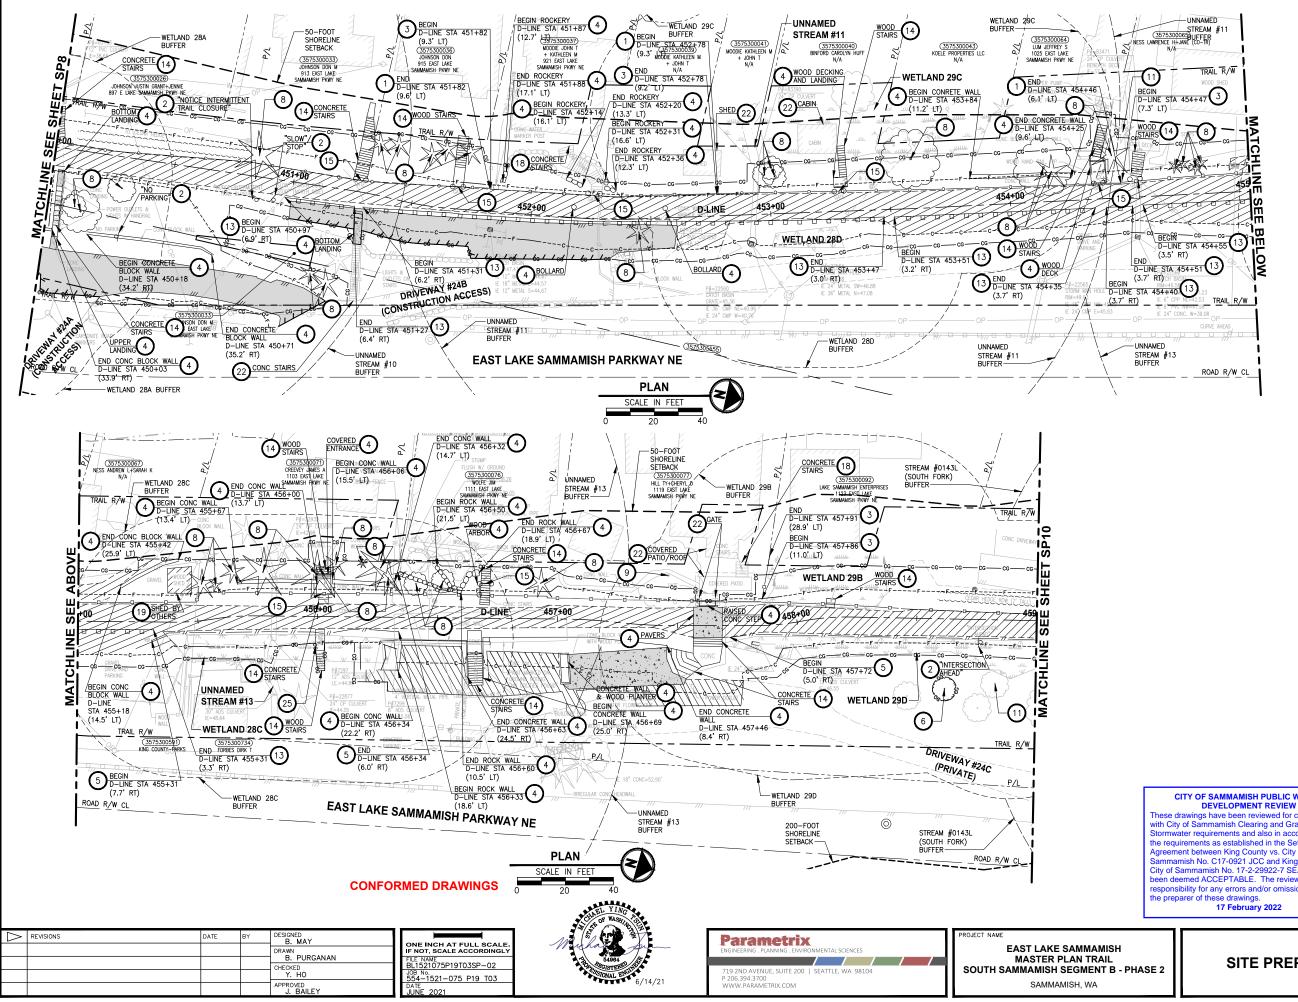

SITE PREPARATION NOTES: (1)REMOVE AND SALVAGE CHAIN LINK FENCE. REMOVE AND DISPOSE SIGN AND POST. SEE (2 NEW SIGN LOCATIONS ON PS SHEETS. (3) REMOVE AND DISPOSE WOOD BOARD FENCE. REMOVE EXISTING WALL, STRUCTURE OR DBSTRUCTION AS INDICATED. REMOVE AND DISPOSE SPLIT RAIL FENCE. REMOVE TREE. TREE SHALL BE FLAGGED AND ASSESSED BY ARBORIST OR PROJECT 6 REPRESENTATIVE PRIOR TO REMOVAL. RFTAIN TREE WITHIN CLEARING AND GRUBBING LIMITS PER ARBORISTS' ASSESSMENT. (8)REMOVE TREE WITHIN CLEARING AND GRUBBING LIMITS. PRUNE TREE FOR 10' MIN VERTICAL CLEARANCE. ARBORIST SHALL BE ON SITE TO MONITOR THE PRUNING ACTIVITY. 9 (10) NOT USED. PRESERVE AND MONITOR TREE. IF TREE REMOVAL IS DEEMED NECESSARY BY THE PROJECT REPRESENTATIVE AND ARBORIST, TREE SHALL BE FLAGGED PRIOR TO REMOVAL. (1)(12) REMOVE DEAD STEM. (13) REMOVE AND SALVAGE WOOD GUARDRAIL. REMOVE AND DISPOSE STAIRS. TYPE AS INDICATED. SEE NEW LOCATIONS ON AL SHEETS. (15 REMOVE AND SALVAGE GATE. (16) NOT USED. **(**17 RESET STREAM GAUAGE, SEE UT SHEETS. RETAIN STAIRS WITHIN CLEARING AND GRUBBING LIMITS. ACCESS MUST BE MAINTAINED OR PROVIDE TEMPORARY ACCESS DURING CONSTRUCTION. REMOVE EXISTING STRUCTURE OR OBSTRUCTION AS (19) INDICATED. BY OTHERS. REMOVE AND SALVAGE TRASH BAG DISPENSER/TRASH (20) CAN. 21 NOT USED. (22) PRESERVE STRUCTURE 23 NOT USED (24) NOT USED. (25) REMOVE AND DISPOSED WOOD BRIDGE. (26) NOT USED. (27) REMOVE AND DISPOSE HOG WIRE FENCE. **GENERAL NOTES:** SEE UT SHEETS FOR EXISTING UTILITIES, UTILITY RELOCATION AND ADJUSTMENTS, AND DRAINAGE IMPROVEMENTS.

SEE TE SHEETS FOR EROSION CONTROL AND OTHER TEMPORARY CONSTRUCTION MEASURES.

LEGEND



REMOVE EXISTING GRAVEL SURFACE REMOVE ASPHALT CONCRETE PAVEMENT REMOVE CEMENT CONCRETE PAVEMENT

MITIGATION CLEARING AND GRUBBING

CITY OF SAMMAMISH PUBLIC WORKS


These drawings have been reviewed for compliance with City of Sammamish Clearing and Grading and ater requirements and also in accord he requirements as established in the Settlement ment between King County vs. City of Sammamish No. C17-0921 JCC and King County vs. City of Sammamish No. 17-2-29922-7 SEA and have en deemed ACCEPTABLE. The reviewer accepts esponsibility for any errors and/or omissions made by


CITY OF SAMMAMISH	APPROVAL
City Engineer	Date
Community Development	Date

SITE PREPARATION PLAN

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SP9



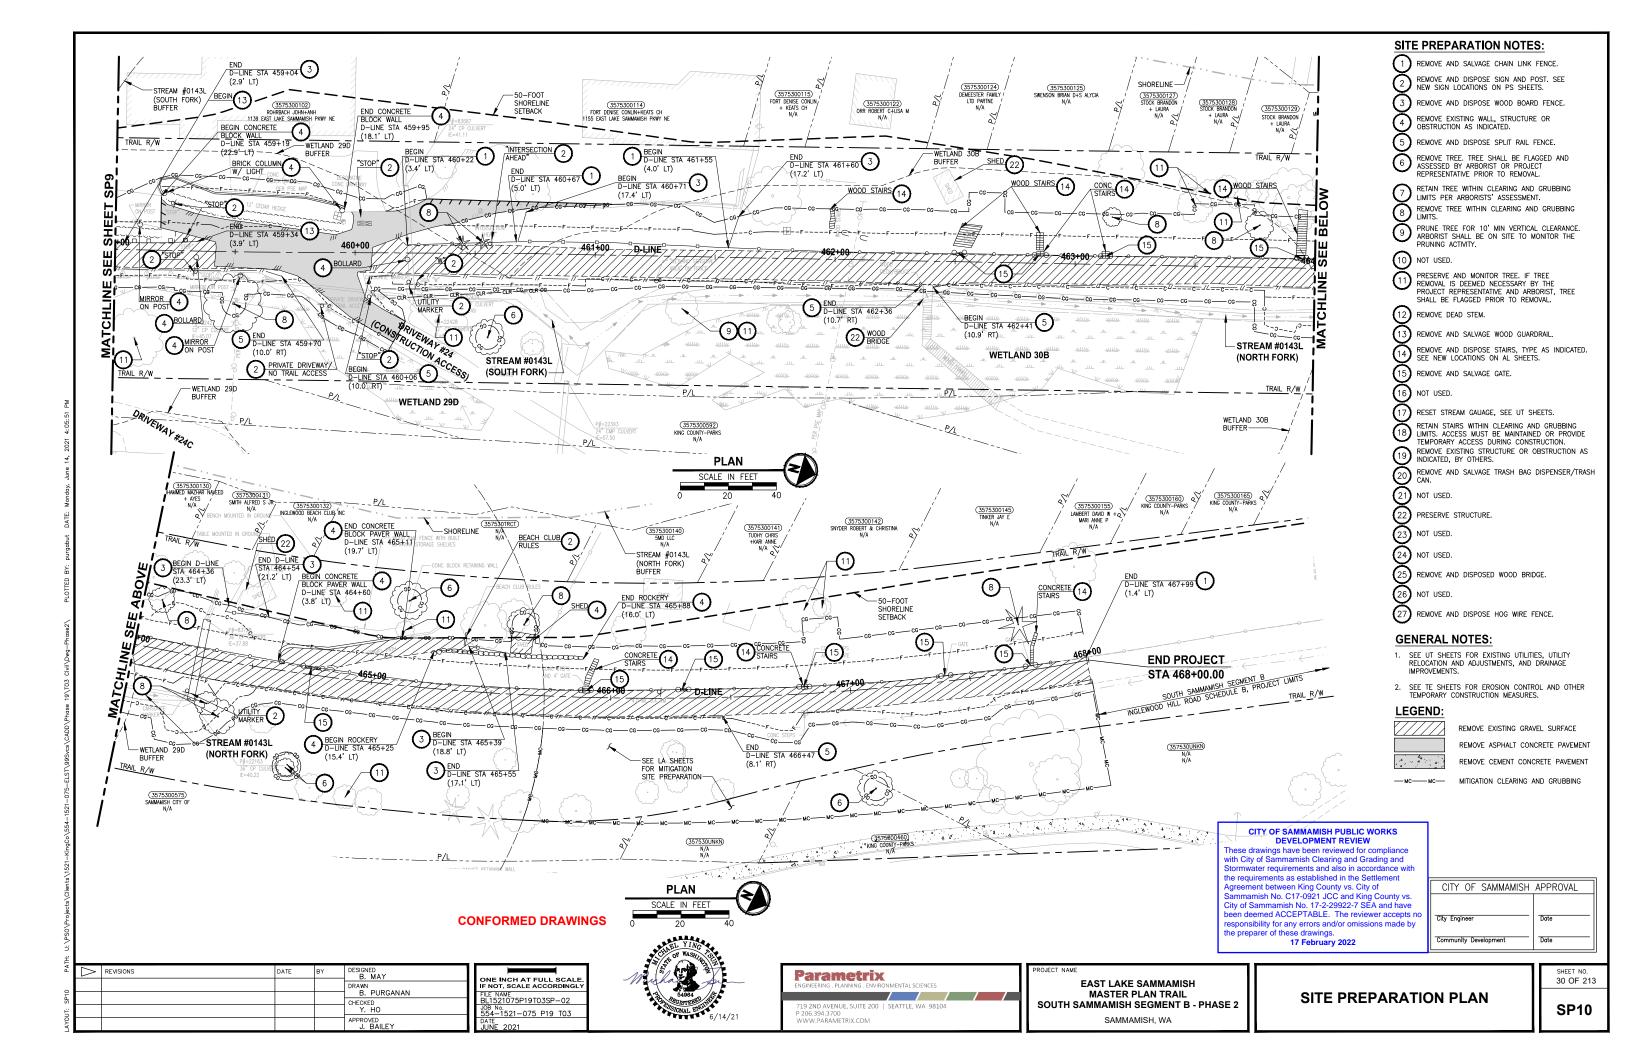

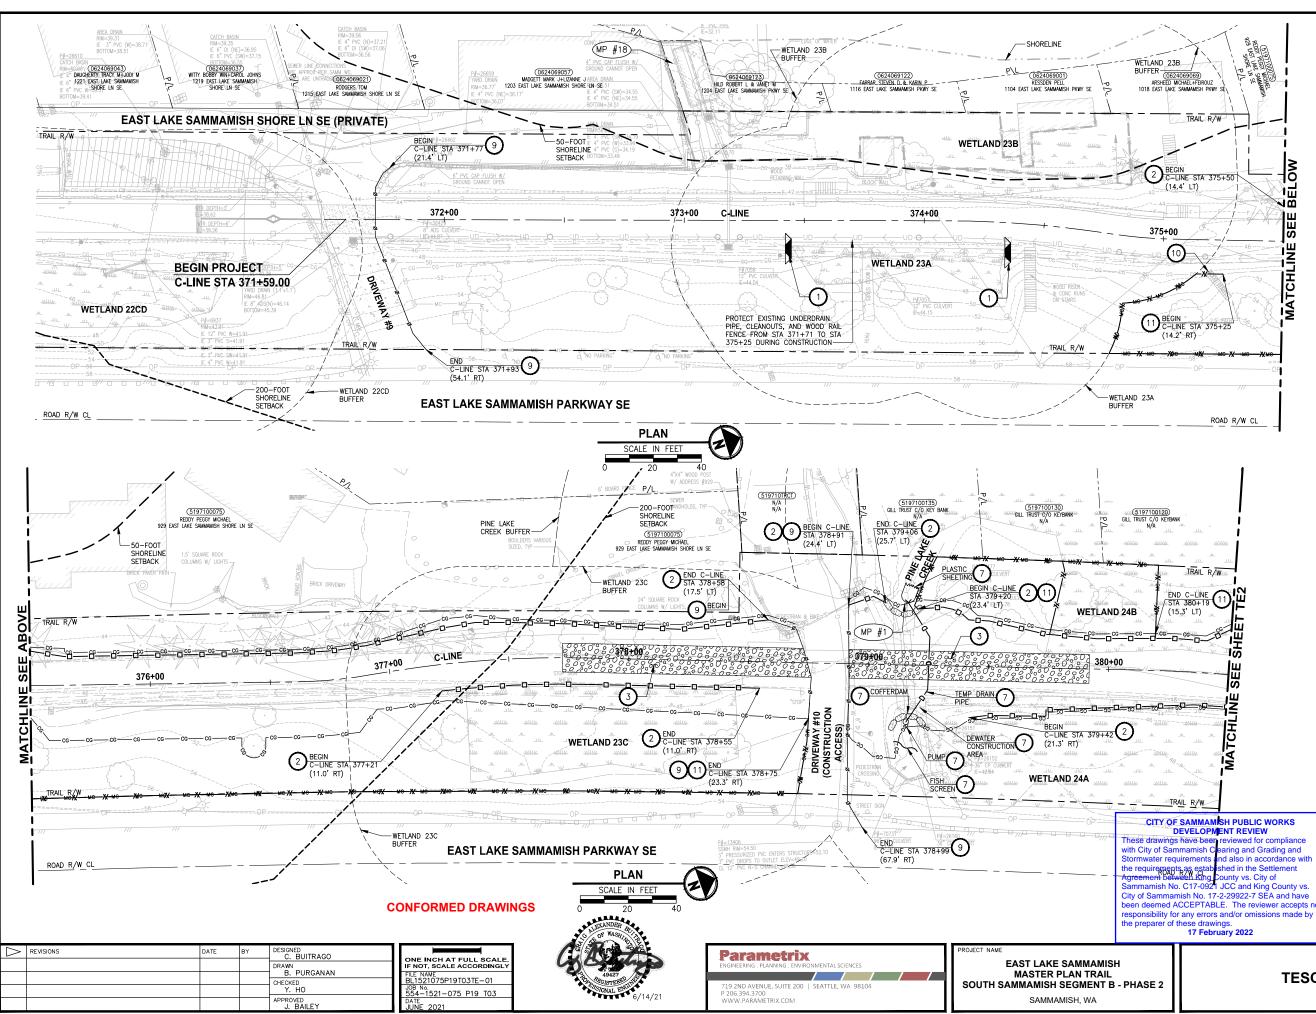CONSTRUCTION NOTES:

- CHECK DAMS ON CHANNELS, PER WSDOT STD DETAIL 1-50.20-01 AND SEE APPENDIX B OF SPECS. USE BIODEGRADABLE CHECK DAMS.
- HIGH VISIBILITY SILT FENCE WITH BACKUP SUPPORT, PER WSDOT STD DETAIL I-30.16-01 AND SEE APPENDIX B OF SPECS. INSTALL FENCE AT C&G OR MC LIMITS. THE LINES SHOWN ARE OFFSET FOR PLAN CLARITY PURPOSES.

3 STABILIZED CONSTRUCTION ENTRANCE PER WSDOT STD DETAIL I-80.10-02 AND SEE APPENDIX B OF SPECS.


- 4 STORM DRAIN INLET PROTECTION, PER WSDOT STD DETAIL I-40.20-00 AND SEE APPENDIX B OF SPECS
- 5 EROSION CONTROL AT CULVERT ENDS, PER WSDOT ST DETAIL I-30.20-00 AND SEE APPENDIX B OF SPECS.

TEMPORARY DRAINAGE BYPASS. SEE SHEET TD1 AND SPECIAL PROVISIONS SECTION 7-06 FOR DETAILS. 6 TD1 AND SPECIAL PROVISIONS SECTION 7-06 FOR DFTAILS.

8 NOT USED.

- TEMPORARY CHAIN LINK SECURITY FENCE, PER SPECIAL PROVISIONS SECTION 8-12.
- FENCING SHOWN AS CONTINUOUS LINE FOR PLAN CLARITY PURPOSES. STAIRWAY, GATE, OR PATH SHALL REMAIN OPEN FOR PRIVATE PROPERTY ACCESS.
- HIGH VISIBILITY FENCE, PER WSDOT STD DETAIL I-10.10-01 AND SEE APPENDIX B OF SPECS. INSTALL FENCE AT C&G OR MC LIMITS. THE LINES SHOWN ARE OFFSET FOR PLAN CLARITY PURPOSES.
- $\textcircled{12} \underset{B \text{ of specs.}}{\text{Biodegradable erosion control blanket, per wisdot std detail 1-60.10-01 and see appendix b of specs.}$

LEGEND:

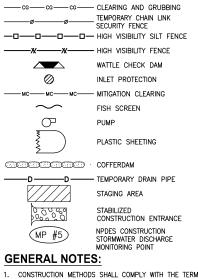



- AND CONDITIONS OF THE HPA PERMIT AND CSWGP. SEE CONTRACT DOCUMENTS FOR PROJECT PERMITS.
- 2. CONTRACTOR SHALL PERFORM CONSTRUCTION STORMWAT MONITORING AND SAMPLING FOR PARAMETERS AS SPECIFIED IN CSWGP.
- 3. THE CONTRACTOR SHALL ENSURE THAT ALL EXISTING DRAINAGE PATTERNS ARE MAINTAINED DURING AND AFTER CONSTRUCTION.
- 4. PRIVATE DRIVEWAYS ARE NOT AVAILABLE FOR CONSTRUCTION ACCESS
- 5. SEE SPECIAL PROVISIONS FOR MAINTENANCE AND REMOV OF TESC BMPS
- 6. SEE SP SHEETS FOR TREES TO BE REMOVED.
- 7. STAGING AREAS SHALL BE RESTORED TO EXISTING CONDITIONS.
- PROTECT INFILTRATION AREAS. SEE SPECIAL PROVISIONS FOR DETAILS.

CITY OF SAMMAMISH	APPROVAL
City Engineer	Date
Community Development	Date



TESC PLAN

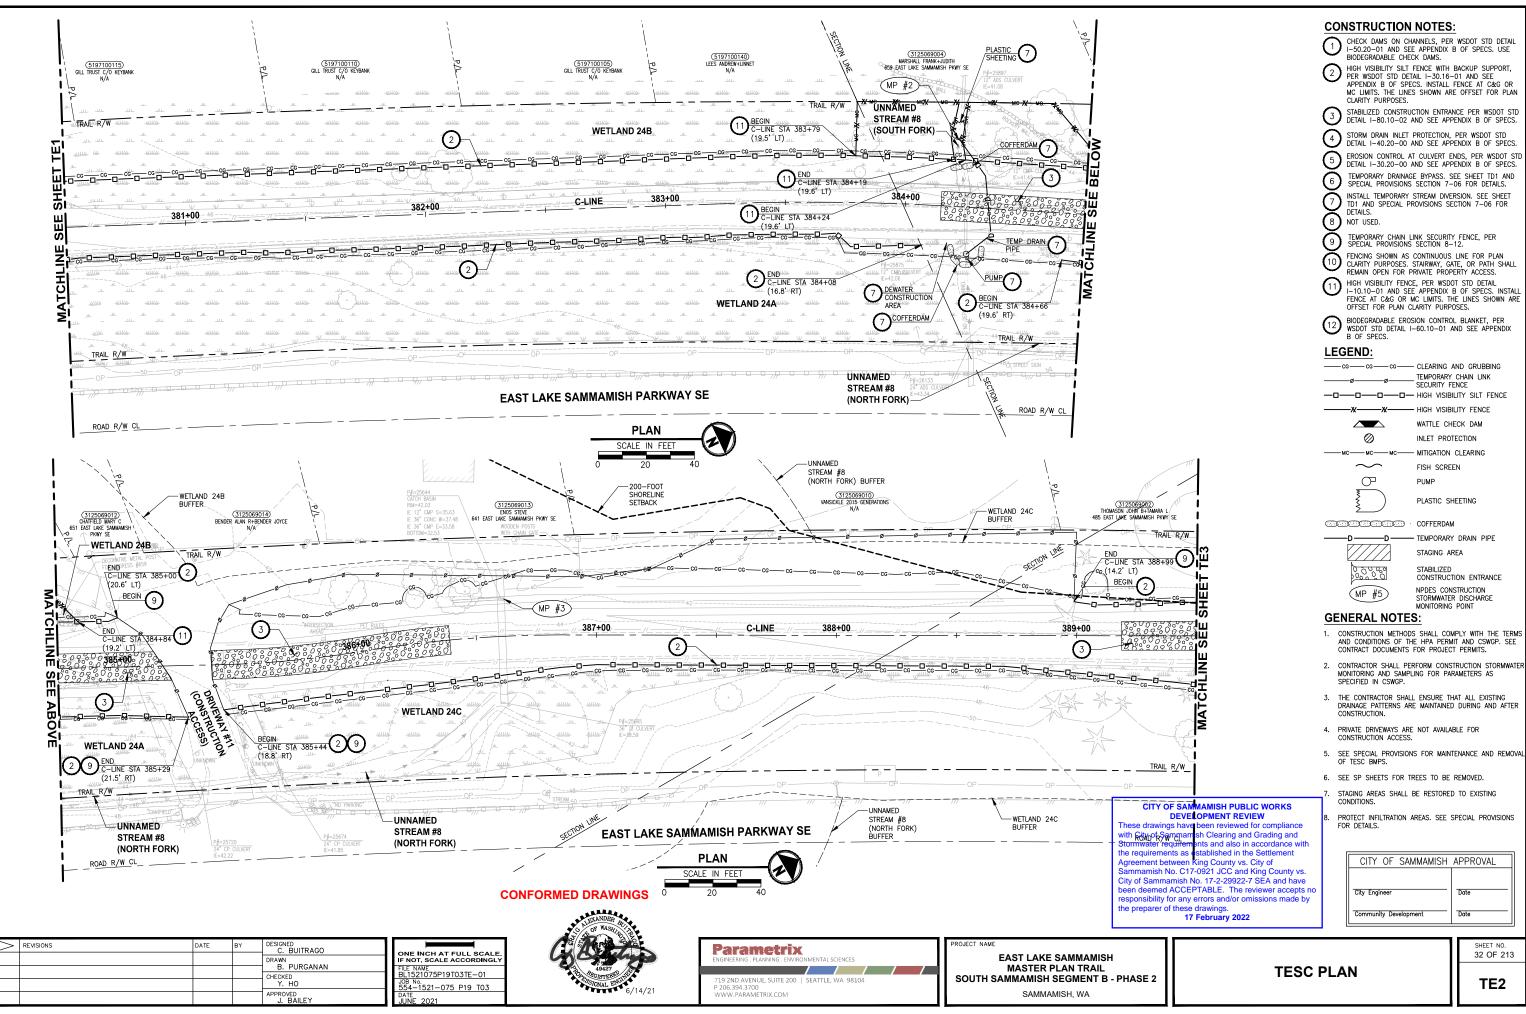

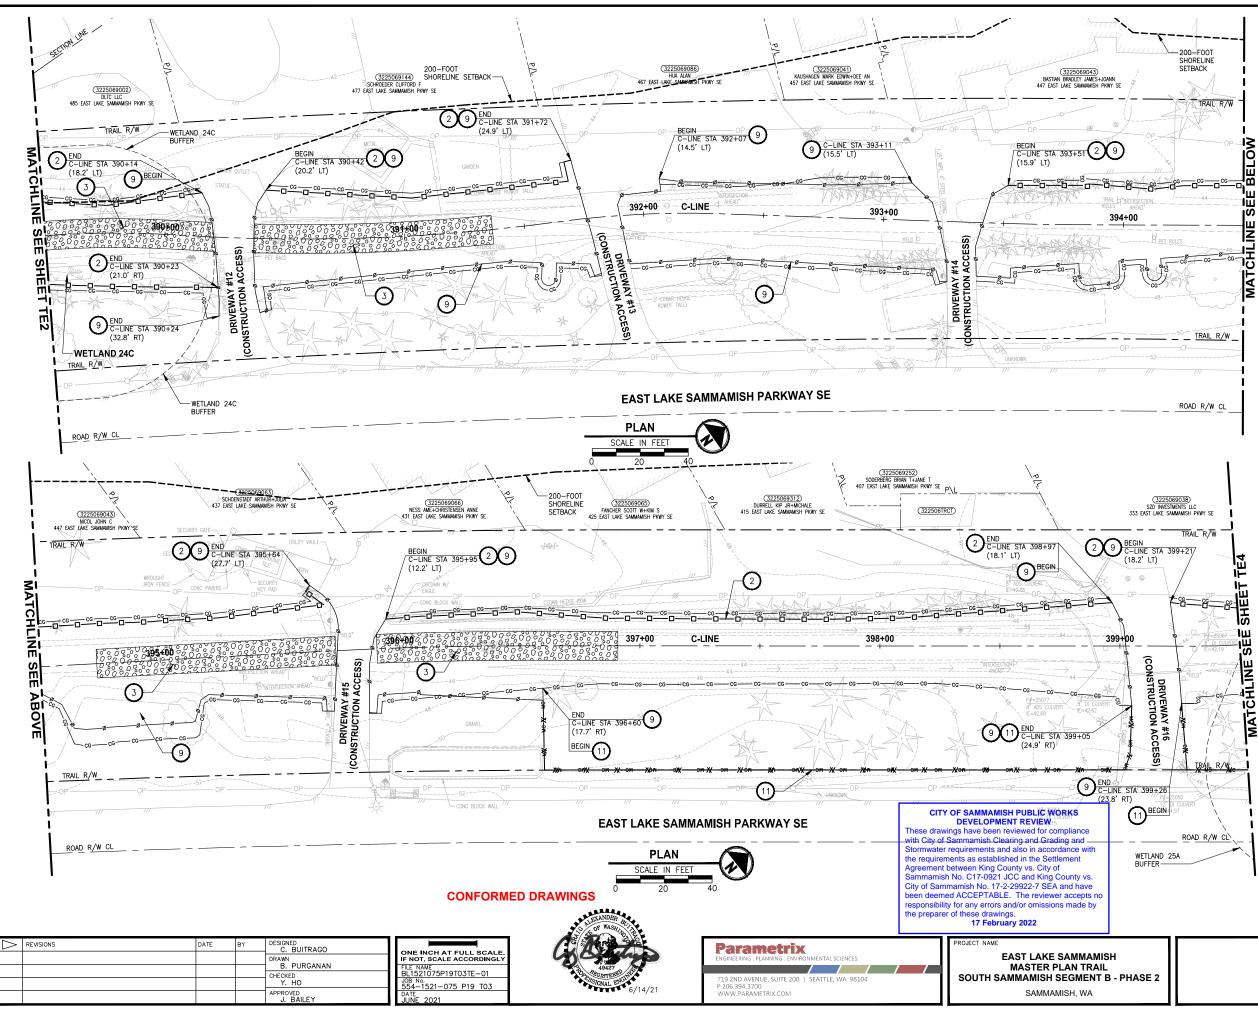

CONSTRUCTION NOTES:

CHECK DAMS ON CHANNELS, PER WSDOT STD DETAIL 1-50.20-01 AND SEE APPENDIX B OF SPECS. USE BIODEGRADABLE CHECK DAMS. HIGH VISIBILITY SILT FENCE WITH BACKUP SUPPORT, PER WSDOT STD DETAIL I-30.16-01 AND SEE APPENDIX B OF SPECS. INSTALL FENCE AT C&G OR MC LIMITS. THE LINES SHOWN ARE OFFSET FOR PLAN CLARITY PURPOSES. 3 STABILIZED CONSTRUCTION ENTRANCE PER WSDOT STD DETAIL I-80.10-02 AND SEE APPENDIX B OF SPECS. A STORM DRAIN INLET PROTECTION, PER WSDOT STD DETAIL I-40.20-00 AND SEE APPENDIX B OF SPECS. 5 EROSION CONTROL AT CULVERT ENDS, PER WSDOT ST DETAIL I-30.20-00 AND SEE APPENDIX B OF SPECS. TEMPORARY DRAINAGE BYPASS. SEE SHEET TD1 AND SPECIAL PROVISIONS SECTION 7-06 FOR DETAILS. TD1 AND SPECIAL PROVISIONS SECTION 7-06 FOR DFTAILS. 8 NOT USED. TEMPORARY CHAIN LINK SECURITY FENCE, PER SPECIAL PROVISIONS SECTION 8-12. FENCING SHOWN AS CONTINUOUS LINE FOR PLAN CLARITY PURPOSES. STAIRWAY, GATE, OR PATH SHALL REMAIN OPEN FOR PRIVATE PROPERTY ACCESS. HIGH VISIBILITY FENCE, PER WSDOT STD DETAIL I-10.10-01 AND SEE APPENDIX B OF SPECS. INSTALL FENCE AT C&C OR MC LIMITS. THE LINES SHOWN ARE OFFSET FOR PLAN CLARITY PURPOSES. $\textcircled{12} \underset{B \text{ of specs.}}{\text{Biodegradable erosion control blanket, per wisdot std detail 1-60.10-01 and see appendix b of specs.}$ LEGEND: - CLEARING AND GRUBBING TEMPORARY CHAIN LINK SECURITY FENCE -0-- HIGH VISIBILITY FENCE WATTLE CHECK DAM \oslash INLET PROTECTION MITIGATION CLEARING FISH SCREEN \sim P PUMP PLASTIC SHEETING COFFERDAM TEMPORARY DRAIN PIPE STAGING AREA //// STABILIZED CONSTRUCTION ENTRANCE NPDES CONSTRUCTION STORMWATER DISCHARGE (MP #5) MONITORING POINT **GENERAL NOTES:** CONSTRUCTION METHODS SHALL COMPLY WITH THE TERMS AND CONDITIONS OF THE HPA PERMIT AND CSWGP. SEE CONTRACT DOCUMENTS FOR PROJECT PERMITS. 2. CONTRACTOR SHALL PERFORM CONSTRUCTION STORMWAT MONITORING AND SAMPLING FOR PARAMETERS AS SPECIFIED IN CSWGP. 3. THE CONTRACTOR SHALL ENSURE THAT ALL EXISTING DRAINAGE PATTERNS ARE MAINTAINED DURING AND AFTER CONSTRUCTION. 4. PRIVATE DRIVEWAYS ARE NOT AVAILABLE FOR CONSTRUCTION ACCESS 5. SEE SPECIAL PROVISIONS FOR MAINTENANCE AND REMOV OF TESC BMPS 6. SEE SP SHEETS FOR TREES TO BE REMOVED. 7. STAGING AREAS SHALL BE RESTORED TO EXISTING CONDITIONS. 8. PROTECT INFILTRATION AREAS. SEE SPECIAL PROVISIONS FOR DETAILS. CITY OF SAMMAMISH APPROVAL

Community	Development


City Engineer


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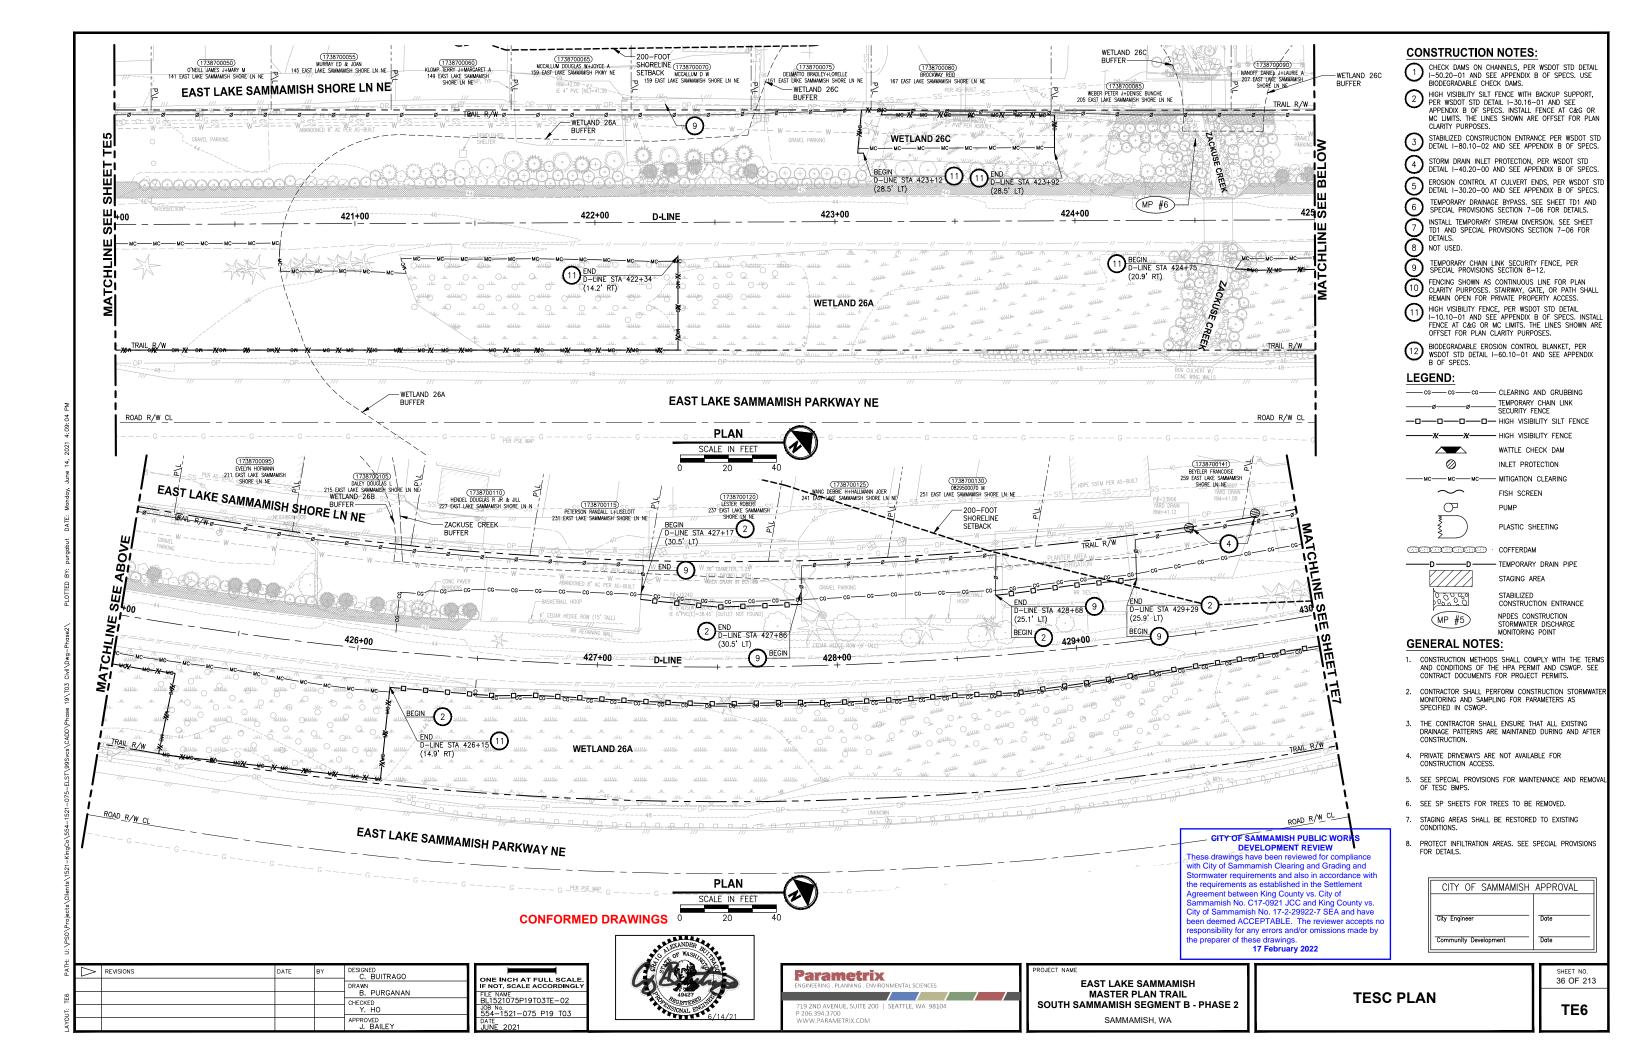
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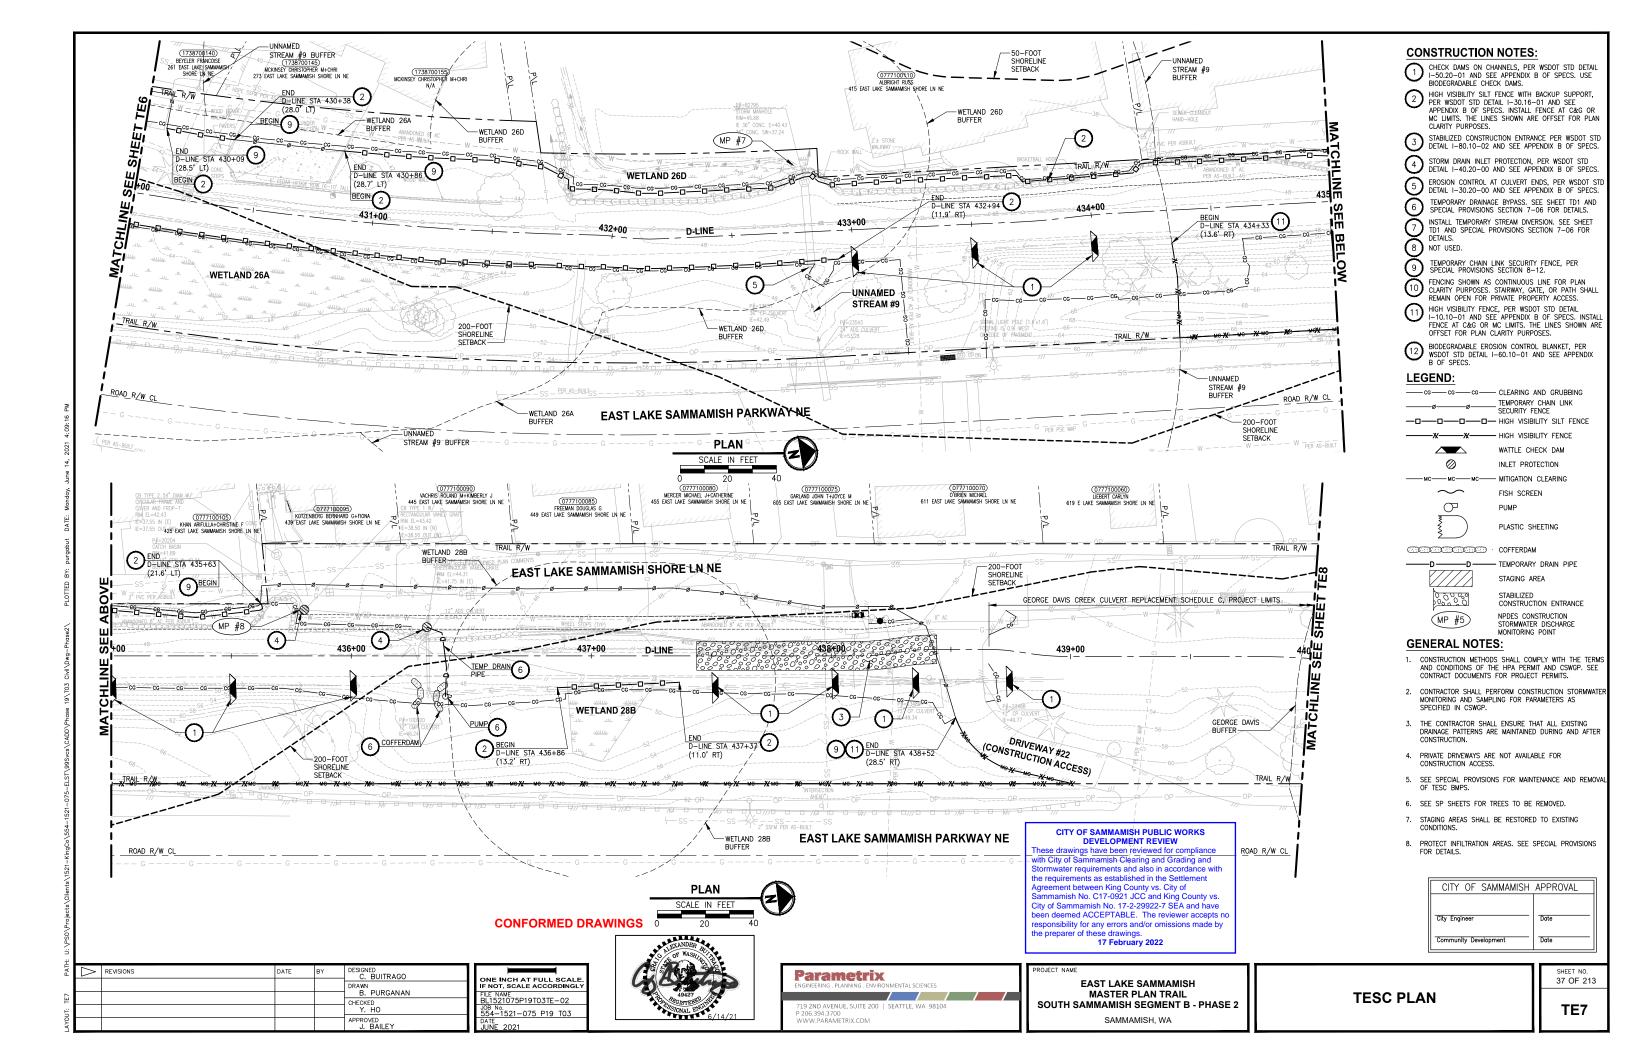
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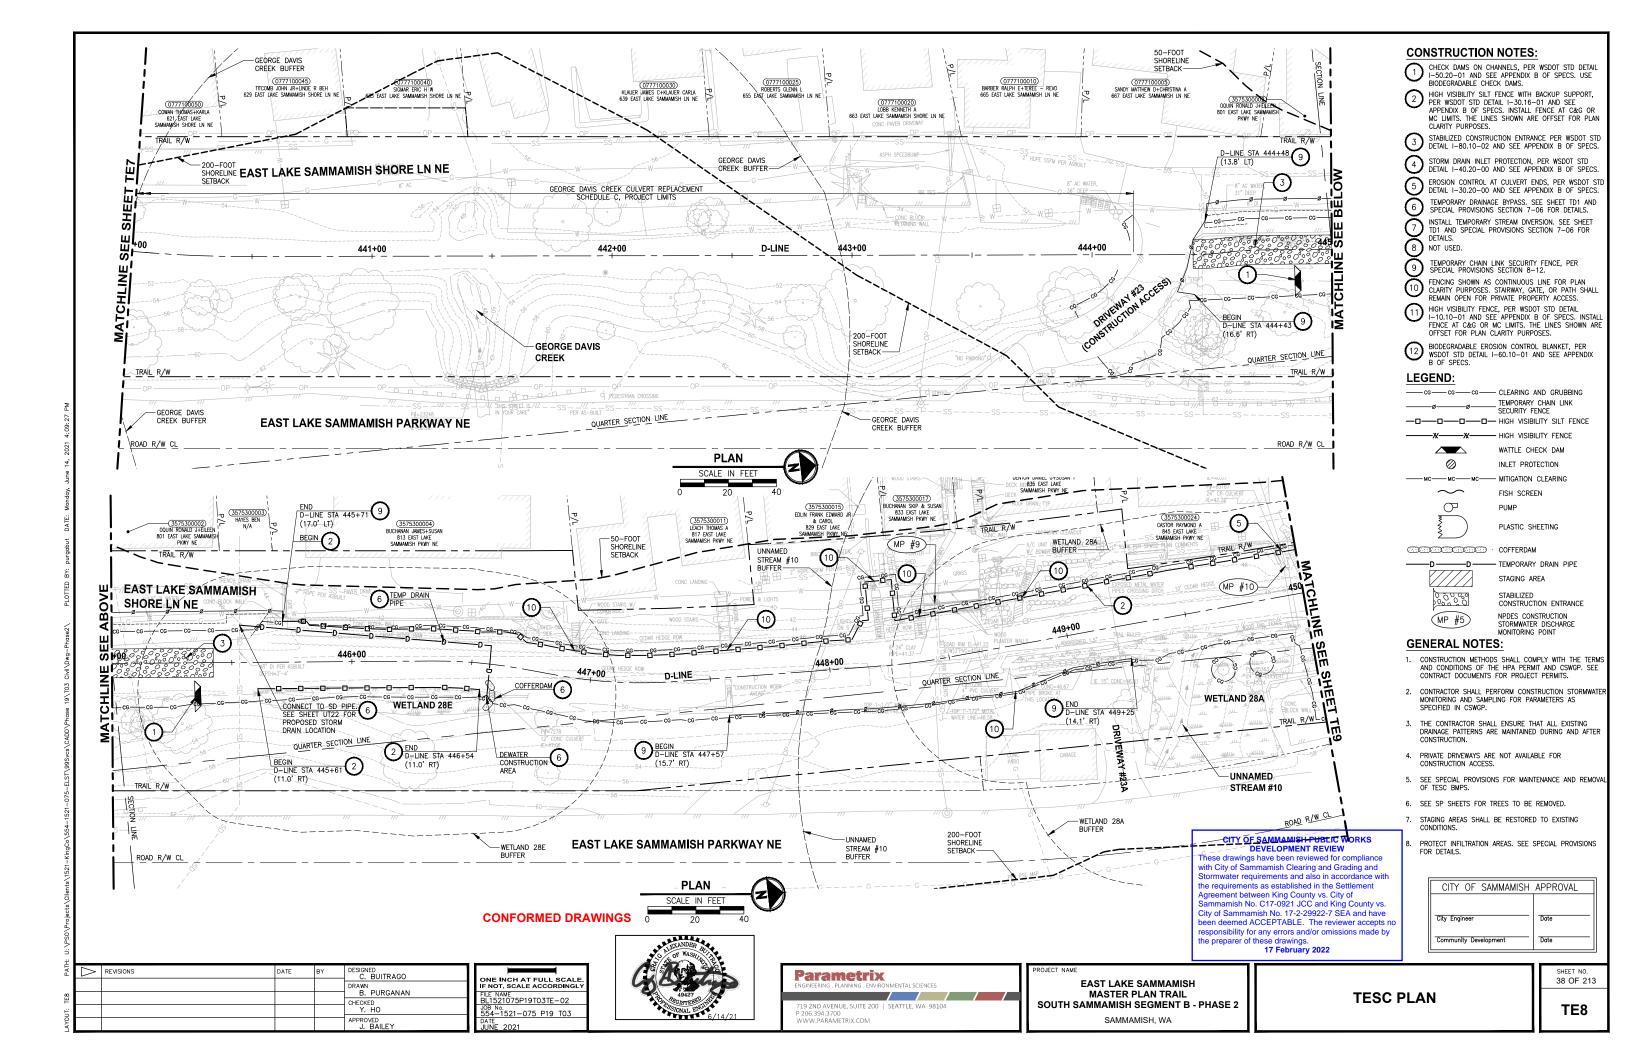
TESC PLAN








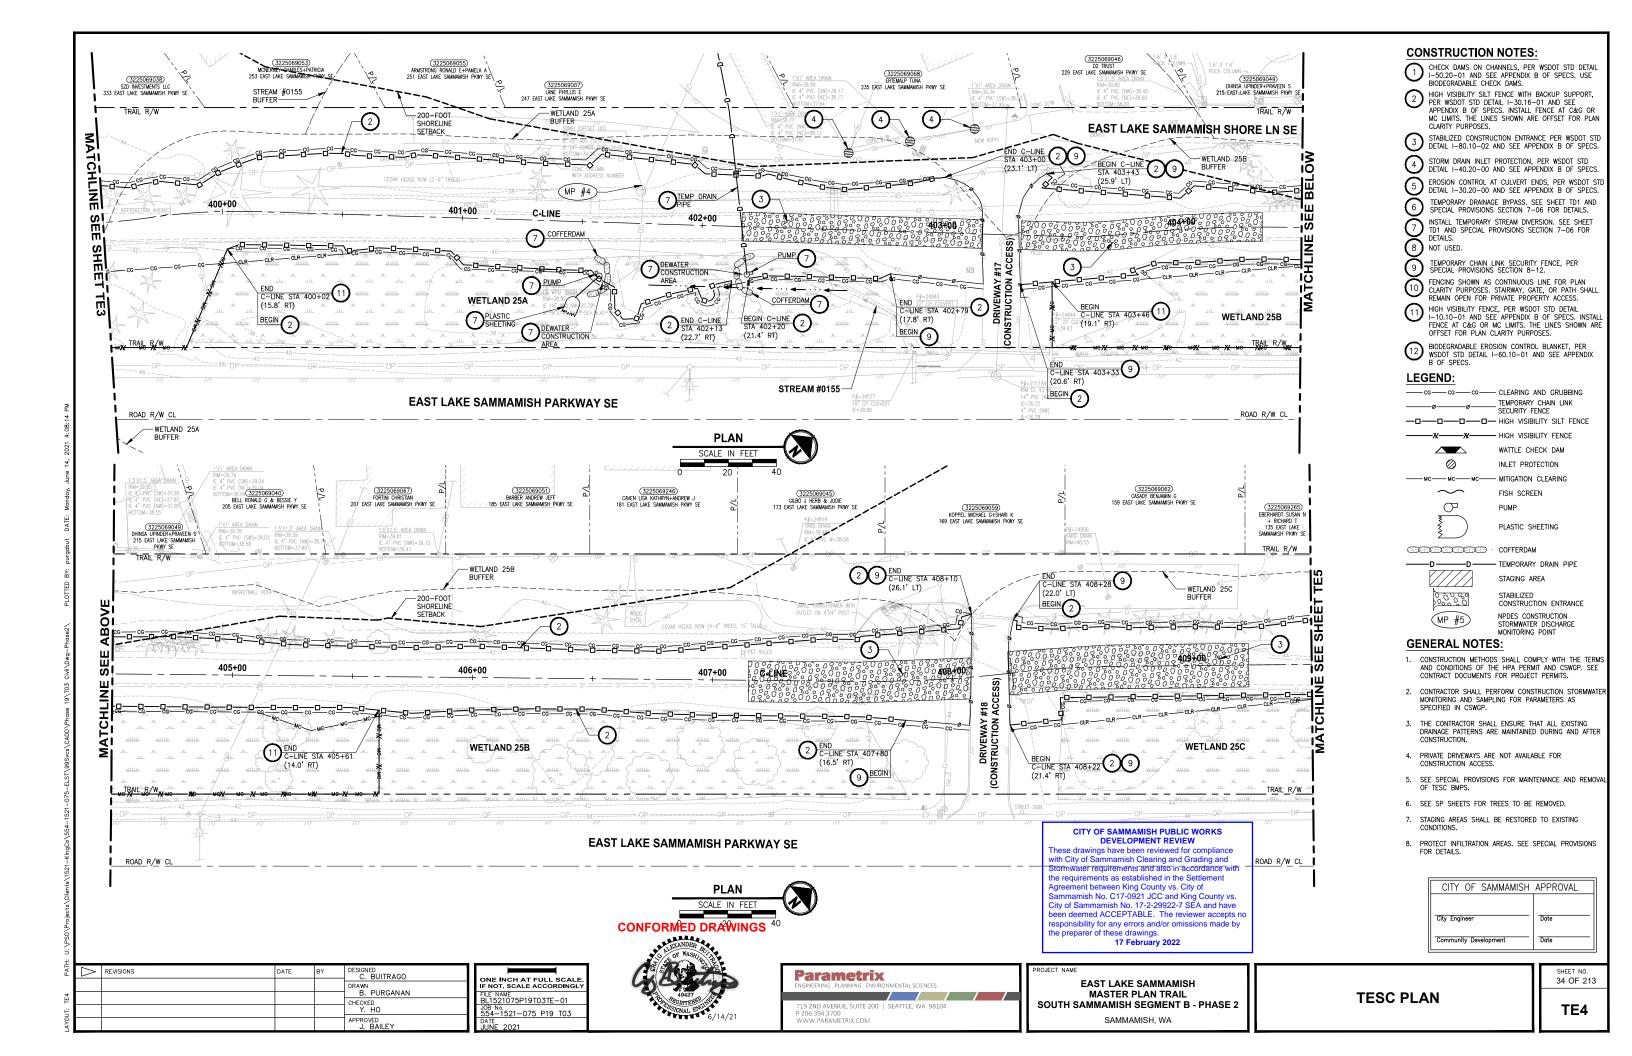

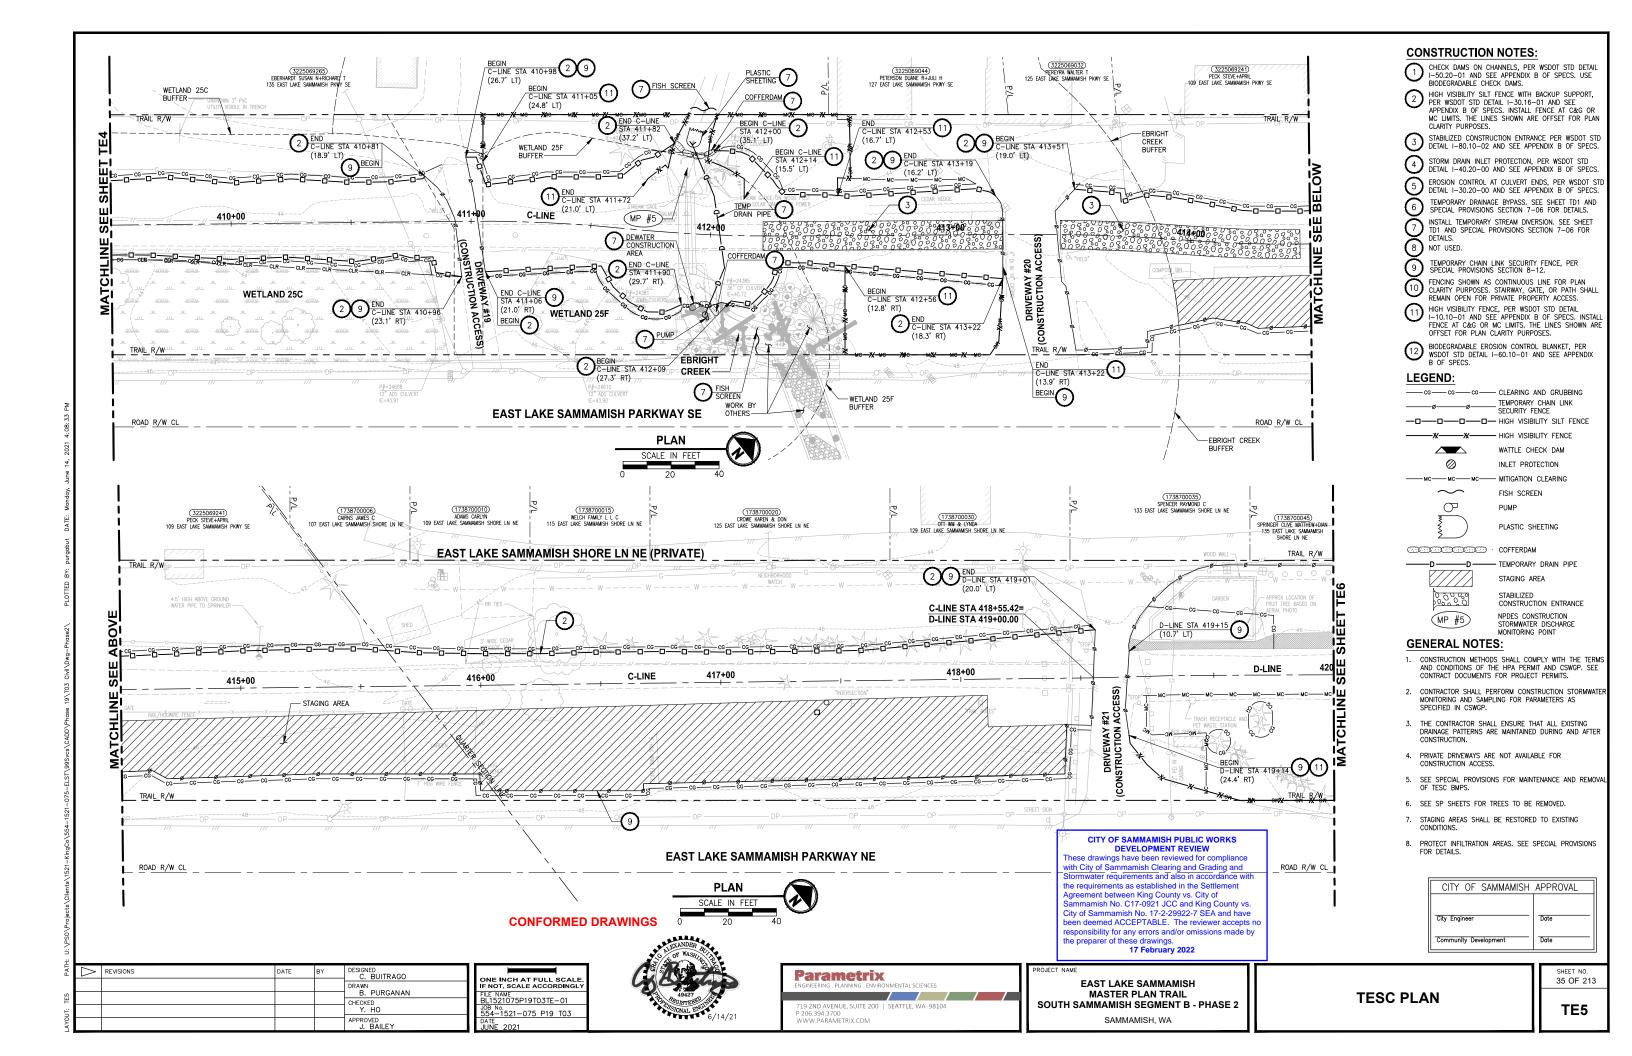


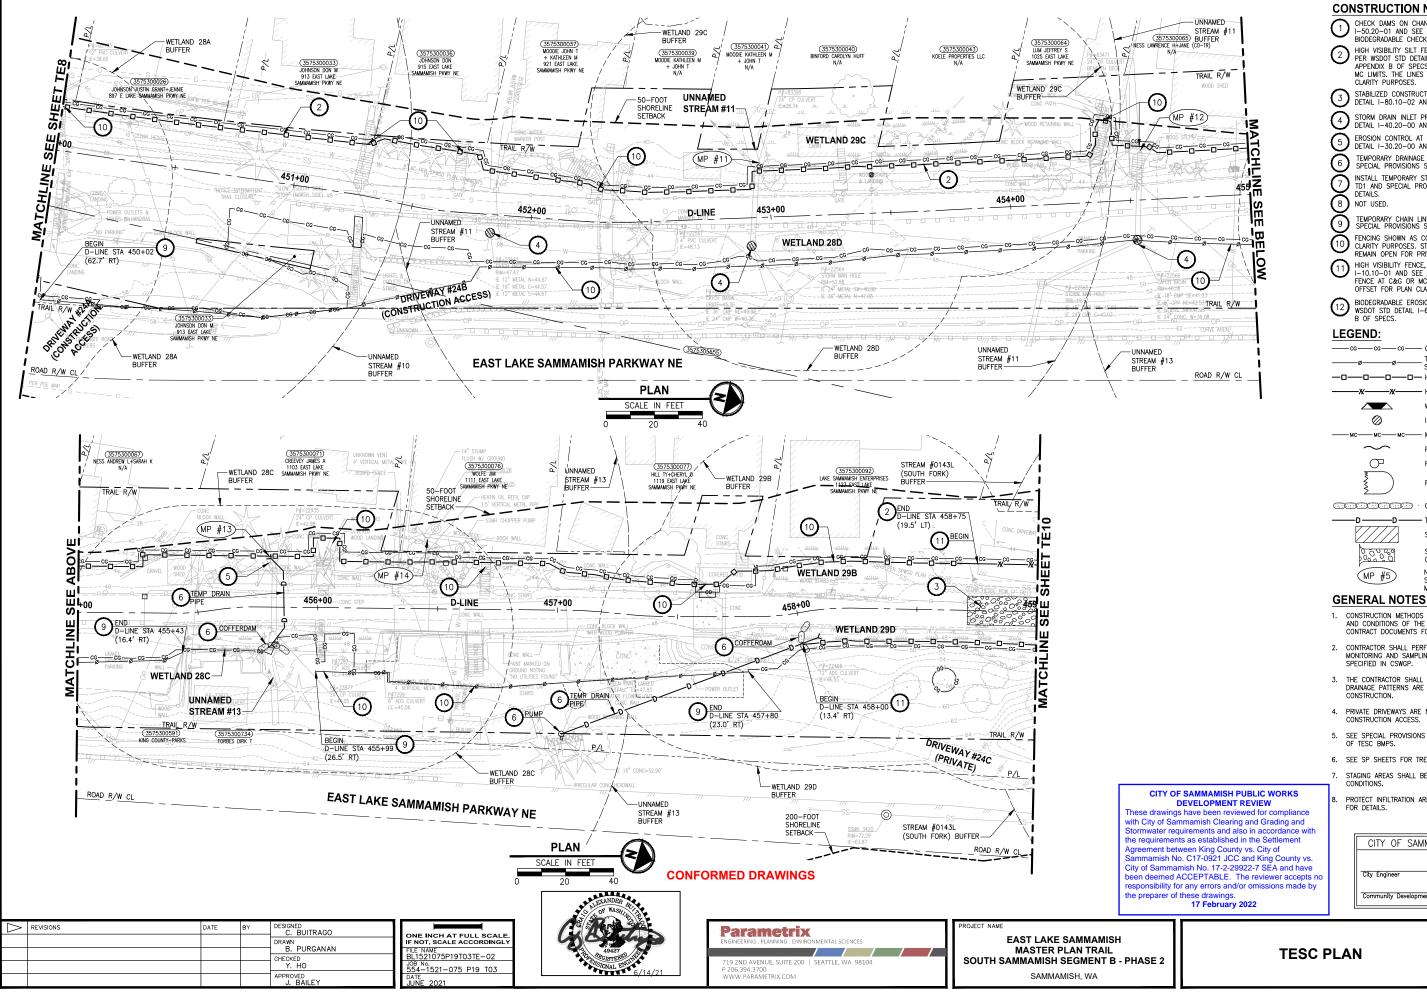


<u>C</u> (ONSTRUCTION	NOTES:	
CHECK DAMS ON CHANNELS, PER WSDOT STD DETAIL 1-50.20-01 AND SEE APPENDIX B OF SPECS. USE			
BIODEGRADABLE CHECK DAMS.			
PER WSDOT STD DETAIL I-30.16-01 AND SEE APPENDIX B OF SPECS. INSTALL FENCE AT C&G OR MC LIMITS. THE LINES SHOWN ARE OFFSET FOR PLAN			
~	CLARITY PURPOSES.		
(3		CTION ENTRANCE PER WSDOT STD AND SEE APPENDIX B OF SPECS.	
4		PROTECTION, PER WSDOT STD AND SEE APPENDIX B OF SPECS.	
(5	EROSION CONTROL A	T CULVERT ENDS, PER WSDOT STD AND SEE APPENDIX B OF SPECS.	
$\widetilde{6}$		E BYPASS. SEE SHEET TD1 AND SECTION 7-06 FOR DETAILS.	
\widetilde{G}	INSTALL TEMPORARY	STREAM DIVERSION. SEE SHEET ROVISIONS SECTION 7-06 FOR	
$\tilde{6}$	DETAILS. NOT USED.		
G	TEMPORARY CHAIN L	INK SECURITY FENCE, PER	
	SPECIAL PROVISIONS	SECTION 8-12. CONTINUOUS LINE FOR PLAN STARWAY, GATE, OR PATH SHALL	
C	REMAIN OPEN FOR P	RIVATE PROPERTY ACCESS.	
(1)	HIGH VISIBILITY FENC I-10.10-01 AND SEI FENCE AT C&G OR M OFFSET FOR PLAN C	E, PER WSDOT STD DETAIL E APPENDIX B OF SPECS. INSTALL IC LIMITS. THE LINES SHOWN ARE LARITY PURPOSES.	
	BIODEGRADABLE EROS	SION CONTROL BLANKET, PER -60.10-01 AND SEE APPENDIX	
LE	EGEND:		
_		- CLEARING AND GRUBBING TEMPORARY CHAIN LINK	
_	øø]00	SECURITY FENCE HIGH VISIBILITY SILT FENCE	
_		- HIGH VISIBILITY FENCE	
		WATTLE CHECK DAM	
	\oslash	INLET PROTECTION	
	мс-мс-мс-	MITIGATION CLEARING	
	~ P	FISH SCREEN PUMP	
	$\overline{\mathbf{x}}$	PLASTIC SHEETING	
œ		COFFERDAM	
_	DD	- TEMPORARY DRAIN PIPE	
		STAGING AREA	
		STABILIZED CONSTRUCTION ENTRANCE	
	MP #5	NPDES CONSTRUCTION STORMWATER DISCHARGE	
G	ENERAL NOTE	MONITORING POINT S:	
1.	CONSTRUCTION METHOD AND CONDITIONS OF TH CONTRACT DOCUMENTS	— S Shall Comply with the terms E HPA Permit and CSWGP. See For project permits.	
2.		RFORM CONSTRUCTION STORMWATER ING FOR PARAMETERS AS	
 THE CONTRACTOR SHALL ENSURE THAT ALL EXISTING DRAINAGE PATTERNS ARE MAINTAINED DURING AND AFTER CONSTRUCTION. 			
4. PRIVATE DRIVEWAYS ARE NOT AVAILABLE FOR CONSTRUCTION ACCESS.			
 SEE SPECIAL PROVISIONS FOR MAINTENANCE AND REMOVAL OF TESC BMPS. 			
6. SEE SP SHEETS FOR TREES TO BE REMOVED.			
7.	STAGING AREAS SHALL CONDITIONS.	BE RESTORED TO EXISTING	
8.	PROTECT INFILTRATION A FOR DETAILS.	REAS. SEE SPECIAL PROVISIONS	
	CITY OF SAM	IMAMISH APPROVAL	

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Date




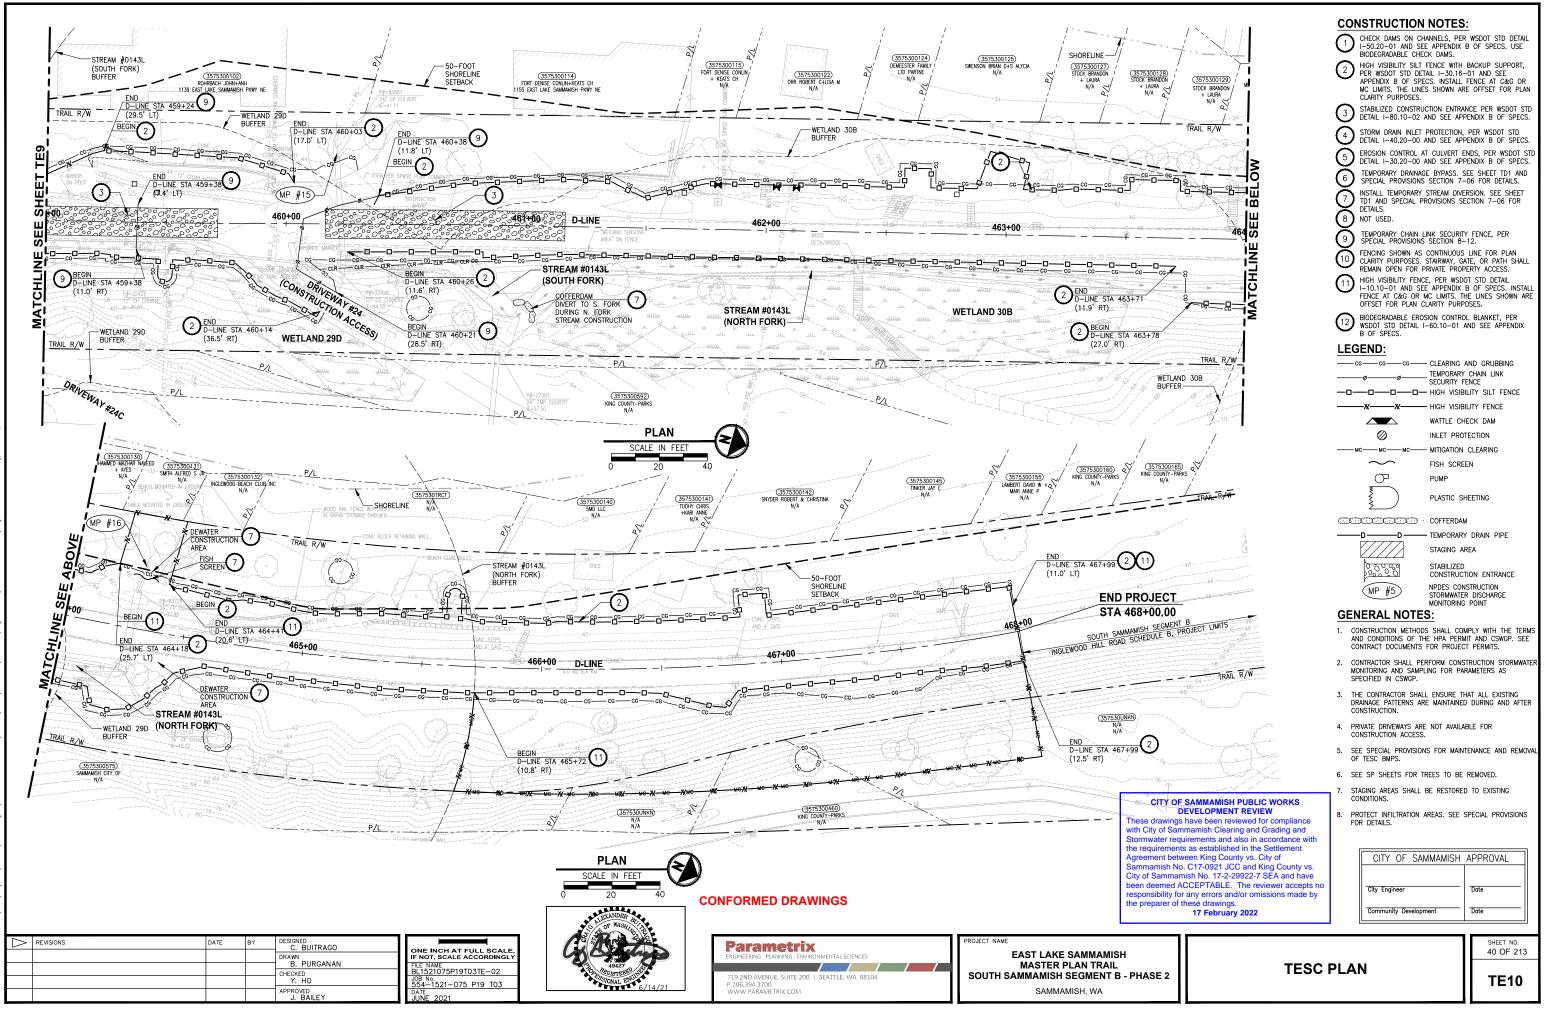

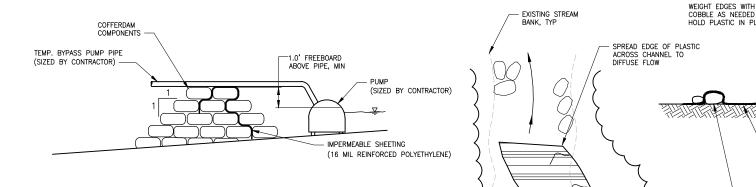COFFERDAM NOTES:

- COFFERDAMS SHALL BE CONSTRUCTED BY THE CONTRACTOR WITH WASHED DRAIN ROCK GRAVEL BAGS PER WSDOT STD. SPEC 9-03.12(4), WATER BAG DAM, PORT-A-DAM, OR OTHER MEANS PRE-APPROVED BY THE ENGINEER. GRAVEL BAGS SHALL BE CONSTRUCTED OF WOVEN SYNTHETIC FIBER.
- 2. THE HEIGHT AND WIDTH OF THE COFFERDAMS SHALL BE DETERMINED BY THE CONTRACTOR BASED ON THE WATER SURFACE ELEVATION AND CHANNEL SHAPE AT THE TIME OF CONSTRUCTION.
- 3. REMOVE LOOSE COBBLE AND BOULDERS FROM THE STREAMBED BEFORE PLACING COFFERDAM COMPONENTS.
- 4. EXTEND THE COFFERDAM ENDS UP THE BANKS OF THE CHANNEL AS NEEDED TO PREVENT EROSION FROM OCCURRING AROUND THE ENDS OF THE COFFERDAM.
- 5. COFFERDAM MATERIALS SHALL BE REMOVED AND DISPOSED FROM THE SITE AND BECOME THE PROPERTY OF THE CONTRACTOR.



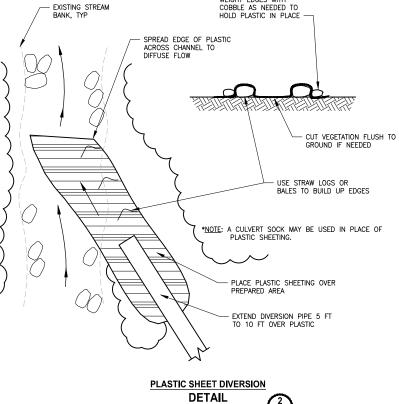

NOT	ΤO	SCALE

TEMPORARY STREAM DIVERSION BYPASS FLOW RATES

STA	STA STREAM			
SIA	STREAM	(CFS)	FLOW (GPM)	
379+15	PINE LAKE CREEK	11.6	5,206	
384+26	UNNAMED STREAM 8	3.8*	1,705	
401+75	STREAM 0155	2.2	987	
411+90	EBRIGHT CREEK	13.1	5,880	
441+40	GEORGE DAVIS CREEK	11.0	4,937	
464+28	STREAM 0143L (N. FORK)**	6.2	2,783	
* 2-YEAR FLOW (CFS)				
** CONTRACTOR SHALL LISE COFFERDAM TO DIRECT ALL FLOW TO S				


COFFERDAM TO DIRECT ALL FLOW TO S. FORK AT STA 460+25

TEMPORARY DRAINAGE BYPASS FLOW RATES STORM DRAIN IMPROVEMENTS				
STA	2-YEAR FLOW (CFS)	FLOW (GPM)		
436+36	1.8	808		
448+40	1.1	485		
455+80	1.2	530		
456+46	0.7	323		

CONFORMED DRAWINGS
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C A OF WASHING TR



Parametrix 719 2ND AVENUE, SUITE 200 | SEATTLE, WA 98104 206.394.3700 WWW.PARAMETRIX.COM

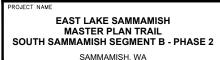

\triangleright	REVISIONS	DATE	BY	DESIGNED C. BUITRAGO	
				DRAWN	ONE INCH AT FULL SCALE IF NOT, SCALE ACCORDINGLY
				B. PURGANAN CHECKED	FILE NAME BL1521075P19T03TD-01
				Y. HO	JOB No. 554-1521-075 P19 T03
				APPROVED J. BAILEY	DATE JUNE 2021
					CONC LOLI

DEWATER CONSTRUCTION AREA NOTES:

- 1. CONTRACTOR SHALL SUBMIT A DEWATERING PLAN FOR THE ENTIRE PROJECT TO THE ENGINEER FOR REVIEW AND APPROVAL WITHIN 14 DAYS OF NOTICE TO PROCEED.
- 2. THE DEWATERING PLAN SHALL INCLUDE LOCATION FOR PUMPED WATER DISPOSAL. PUMPED WATER MAY BE SPRAYED OVER EXISTING VEGETATION OR CONNECTED TO TEMPORARY BYAAS (STREAM OR STORM DRAIN). IF PUMPED TO STREAM OR STORM DRAIN, SITE DISCHARGE WATER SHALL MEET TURBIBITY REQUIRMENTS OF THE CONSTRUCTION STORMWATER GENERAL PERMIT.
- 3. THE DEWATERING SYSTEM SHALL BE INSPECTED DAILY BY THE CONTRACTOR AND MAINTAINED TO ENSURE CONTINUED PROPER FUNCTIONING.

TEMPORARY STREAM DIVERSION NOTES:

- CONTRACTOR SHALL SUBMIT THE PLAN FOR EACH STREAM CONSTRUCTION AREA TO THE ENGINEER FOR REVIEW AND APPROVAL WITHIN 14 DAYS OF NOTICE TO PROCEED. SEE SPECIAL PROVISIONS 7-06. THE TEMPORARY STREAM SHOWN IN THE PLAN IS CONCEPTUAL ONLY.
- 2. CONTRACTOR SHALL NOTIFY OWNER 7-DAYS PRIOR TO IN-WATER WORK AND ISOLATE IN-WATER WORK AREAS USING DAMS. APPROPRIATE FISH EXCLUSION METHODS SHALL BE USED PRIOR TO IN-WATER WORK.
- FISH EXCLUSION AND FISH REMOVAL SHALL BE PERFORMED BY OWNER BEFORE IN-WATER WORK IN ACCORDANCE WITH THE WASHINGTON DEPARTMENT OF FISH AND WILDLIFE HPA.
- 4. CONTRACTOR SHALL MONITOR AND MAINTAIN THE FISH NETS AND COMMUNICATE WITH OWNER IF FISH ARE OBSERVED IN THE PROJECT AREA AND IF FISH NETS NEED REPLACING.
- 5. INSTALLED SYSTEMS SHALL BE INSPECTED DAILY BY THE CONTRACTOR AND MAINTAINED TO ENSURE CONTINUED PROPER FUNCTIONING.
- PUMP SHALL BE SIZED FOR MINIMUM STREAM FLOWS AS PROVIDED IN THE BYPASS FLOW TABLE PROVIDED IN THIS SHEET. CONTRACTOR SHALL BE PREPARED TO PROTECT WORK STE AND ADJACENT PROPERTIES DURING HIGHER FLOWS THAN THOSE PROVIDED IN THE TABLE.
- 7. PUMP WILL REQUIRE GENERATOR AND POWER. CONTRACTOR SHALL CONSIDER CONTACTING PUGET SOUND ENERGY AND ESTABLISHING A TEMPORARY POWER TAP FROM THE NEAREST POWER POLE.

TEMPORARY DRAINAGE BYPASS NOTES:


- 1. CONTRACTOR SHALL INSTALL DRAINAGE BYPASSES PER PLANS AND AS DETAILED IN SECTION 8-01 OF THE SPECIAL PROVISIONS.
- 2. THE CONTRACTOR SHALL NOTIFY THE ENGINEER 10 DAYS PRIOR TO STARTING THE WORK FOR TEMPORARY DRAINAGE BYPASSES.
- 3. TEMPORARY BYPASS PUMP, IF NEEDED, SHALL BE SIZED FOR MINIMUM FLOWS AS PROVIDED IN THE TEMPORARY DRAINAGE BYPASS FLOW RATES TABLE IN THIS SHEET. CONTRACTOR SHALL BE PREPARED TO PROTECT THE WORK SITE AND ADJACENT PROPERTIES DURING HIGHER FLOWS THAN THOSE PROVIDED IN THE TABLE, IF LARGER PRECIPITATION EVENTS ADDE COPECASTED DURING WORK ARE FORECASTED DURING WORK.
- 4. TEMPORARY BYPASS PUMP WILL REQUIRE POWER TO OPERATE AND WILL LIKELY USE A GENERATOR. CONTRACTOR SHALL PROVIDE SECONDARY CONTAINMENT FOR GENERATORS.

CITY OF SAMMAMISH PUBLIC WORKS DEVELOPMENT REVIEW These drawings have been reviewed for compliance with City of Sammamish Clearing and Grading and Stormwater requirements and also in accordance with the requirements as established in the Settlement		
Agreement between King County vs. City of	CITY OF SAMMAMISH	APPROVAL
Sammamish No. C17-0921 JCC and King County vs. City of Sammamish No. 17-2-29922-7 SEA and have been deemed ACCEPTABLE. The reviewer accepts no responsibility for any errors and/or omissions made by the preparer of these drawings.	City Engineer	Date
17 February 2022	Community Development	Date
		SHEET 1 41 OF

TESC DETAILS

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TD1

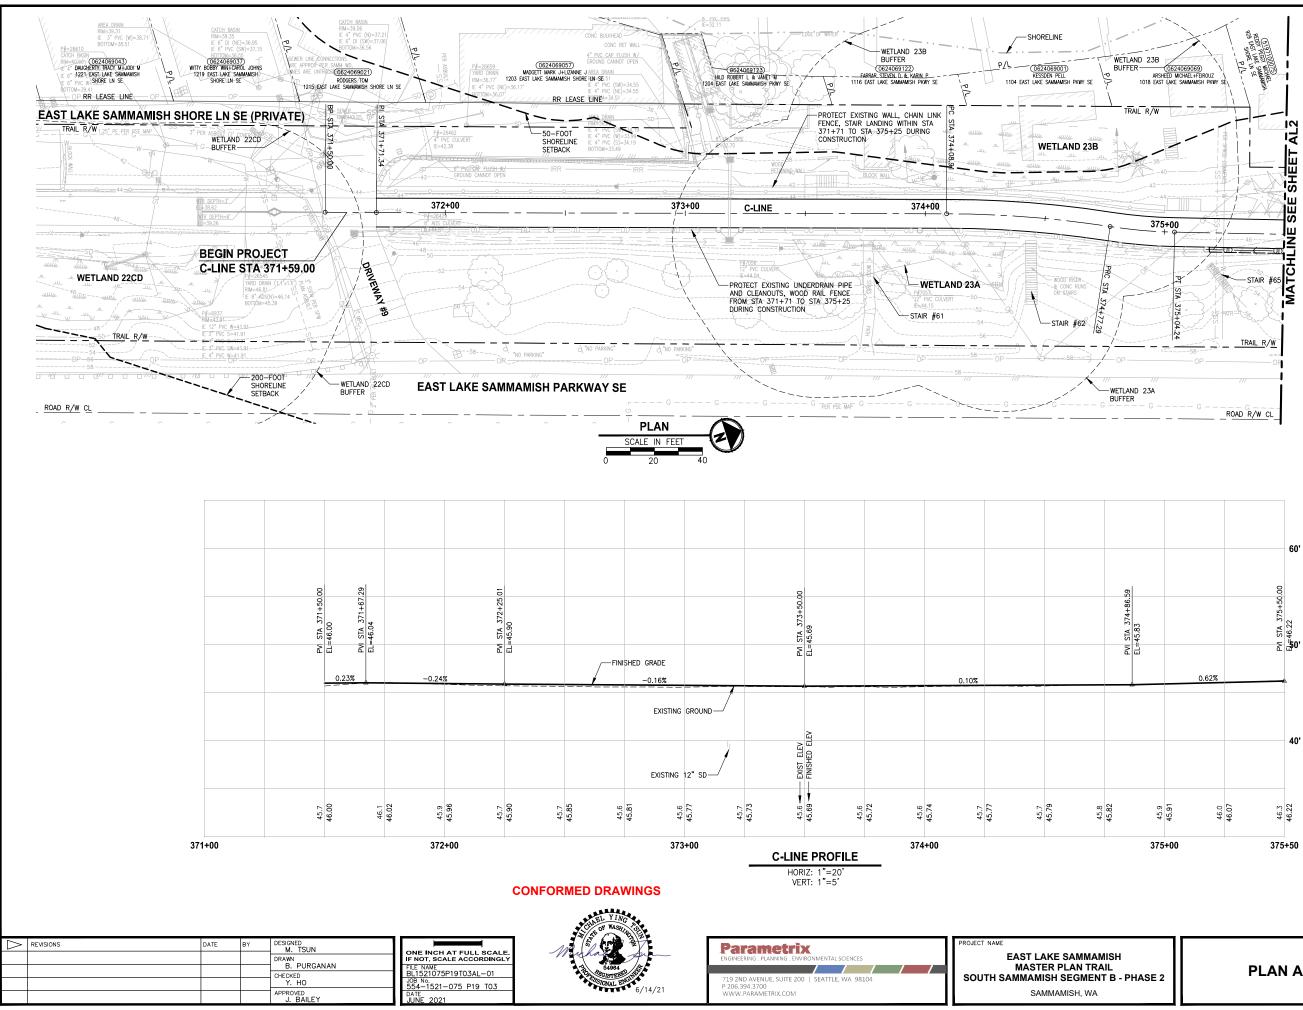


CIVIL CONSTRUCTION NOTES:		
$\overline{(1)}$	INSTALL STAIR. CIP CONCRETE STAIR TYPE. SEE S SHEETS FOR DETAILS.	
$(\widetilde{2})$	NOT USED.	
$(\overline{3})$	NOT USED.	
$\check{4}$	INSTALL STRUCTURAL EARTH WALL. SEE WALL DETAILS ON SHEET WD1. SEE WALL PROFILES ON WP SHEETS.	
5	INSTALL 4-FOOT COATED CHAIN LINK FENCE. SEE DETAILS ON SHEET MD8. SEE SHEET WD1 FOR MOUNTING ON TOP OF WALL.	
6	NEW DRIVEWAY.	
Ø	INSTALL WOOD GUARDRAIL, SEE DETAILS ON SHEET MD2.	
(3)	INSTALL 2-RAIL FENCE, SEE DETAILS ON SHEET MD3.	
9	INSTALL CONCRETE PAD. SEE DETAIL 2 ON SHEET MD1.	
	INSTALL ROCK WALL. SEE DETAILS ON SHEET MD1 AND DP SHEETS.	
(1)	NOT USED.	
(12)	INSTALL TYPE 1 REST STOP. SEE DETAILS ON SHEET MD1.	
(13)	NOT USED.	
14	INSTALL PEDESTRIAN RAILING PER COS FIG 03-15 ON CONCRETE COPING. SEE APPENDIX B IN THE SPECIFICATIONS.	
(15)	INSTALL GRAVITY BLOCK WALL. SEE WALL DETAILS ON SHEET WD1. SEE WALL PROFILES ON WP SHEETS.	
(16)	NOT USED.	
Ű	INSTALL EXTRUDED CURB PER WSDOT STD PLAN F-10.42-00. SEE APPENDIX B IN THE SPECIFICATIONS.	
(18)	NOT USED.	
(19)	LEAVE 5' GAP IN FENCING FOR STAIR ACCESS.	
20	INSTALL METAL HANDRAIL PER KCRS FIG. 5-007. SEE S SHEETS FOR LIMITS AND DETAILS OF HANDRAIL. SEE APPENDIX B IN SPECIFICATIONS.	
21	INSTALL SLOPE PROTECTION. OMIT 0.5' SLOPE ROUNDING. SEE DETAIL 4 ON SHEET MD4.	
22	RESTORE CONCRETE STAIR LANDING PAD, SEE DETAIL 5 ON SHEET MD4.	
23	INSTALL SLOPE PROTECTION, SEE DETAIL 4 ON SHEET MD4.	
24	NOT USED.	
25	NOT USED.	
26	INSTALL REDIROCK WALL PER DETAIL 4 ON SHEET WD1.	
(27)	NOT USED.	
LEG	END:	
	RETAINING WALL WOOD GUARDRAIL	
	LANDING PAD	
	SLOPE PROTECTION	
GEN	IERAL NOTES:	
	E UT SHEETS FOR UTILITY AND DRAINAGE PROVEMENTS.	
2. SE	E DP SHEETS FOR DRIVEWAY DETAILS AND GRADING.	
3. EX ON CL	ISTING FEATURES/TREES CALLED OUT TO BE REMOVED N SP SHEETS ARE NOT SHOWN ON AL SHEETS FOR ARITY PURPOSES.	
4. SE OF	E LA SHEETS FOR RESTORATION ALONG TRAIL SIDE R ALONG BOTTOM OF WALLS.	
	E LA SHEETS FOR CUT WALL BACK SLOPE STORATION TREATMENT.	
	DEVELOPMENT REVIEW se drawings have been reviewed for compliance	
	City of Sammamish Clearing and Grading and mwater requirements and also in accordance with	
	equirements as established in the Settlement	

Agreement between King County vs. City of Sammarnish No. C17-0921 JCC and King County vs. City of Sammarnish No. 17-2-29922-7 SEA and have been deemed ACCEPTABLE. The reviewer accepts n responsibility for any errors and/or omissions made by the preparer of these drawings.

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PLAN AND PROFILE

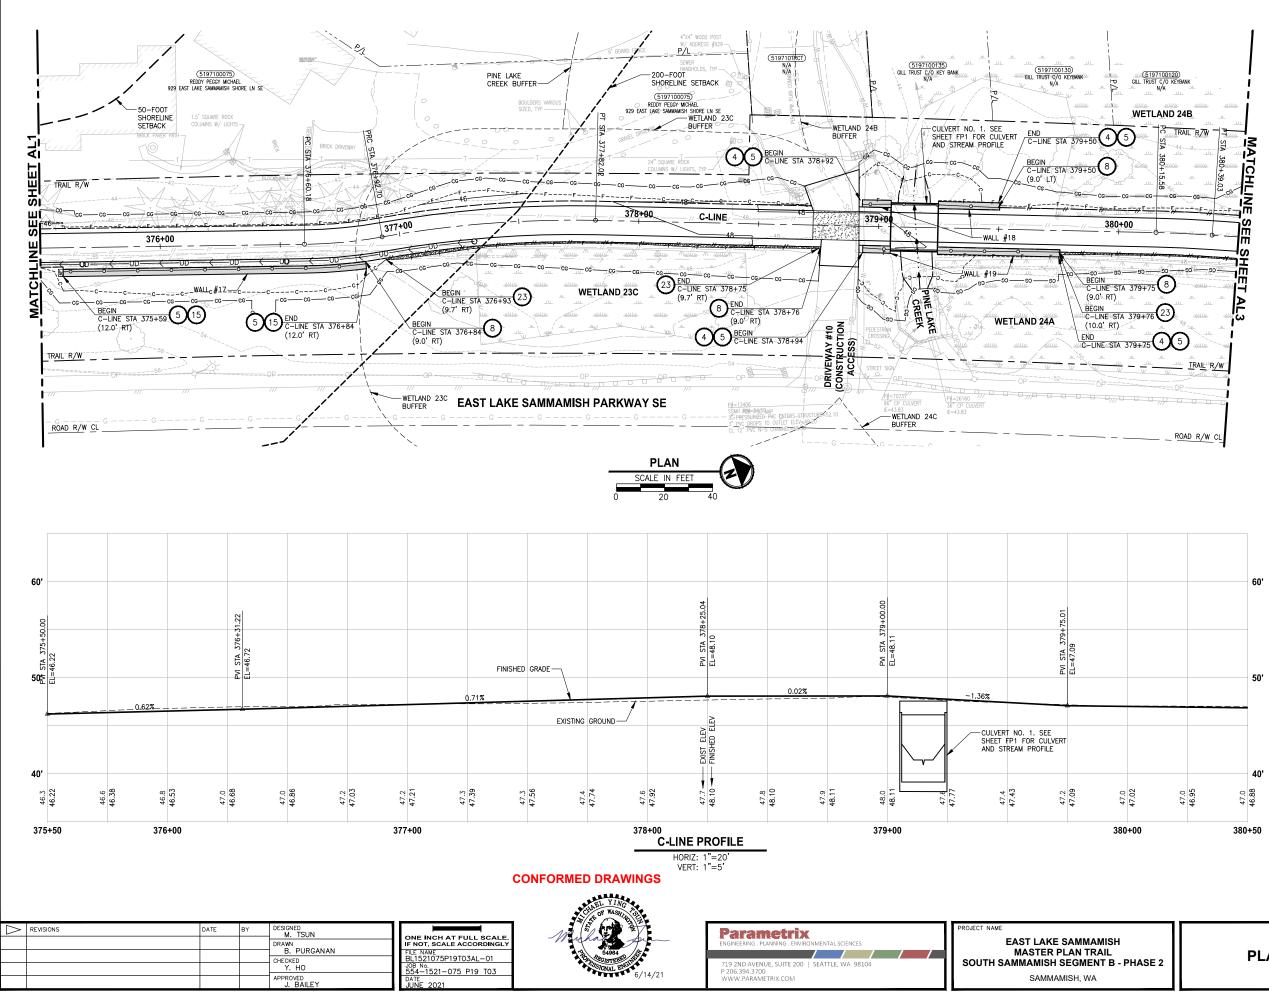


CIVIL CONSTRUCTION NOTES:		
INSTALL STAIR. CIP CONCRETE STAIR TYPE. SEE S SHEETS FOR DETAILS.		
2 NOT USED.		
3 NOT USED.		
$\overbrace{4}^{4}$ INSTALL STRUCTURAL EARTH WALL. SEE WALL DETAILS ON SHEET WD1. SEE WALL PROFILES ON WP SHEETS.		
5 INSTALL 4-FOOT COATED CHAIN LINK FENCE. SEE DETAILS ON SHEET MDB. SEE SHEET WD1 FOR MOUNTING ON TOP OF WALL.		
6 NEW DRIVEWAY.		
INSTALL WOOD GUARDRAIL, SEE DETAILS ON SHEET MD2.		
8 INSTALL 2-RAIL FENCE, SEE DETAILS ON SHEET MD3.		
(9) INSTALL CONCRETE PAD. SEE DETAIL 2 ON SHEET MD1.		
10 INSTALL ROCK WALL. SEE DETAILS ON SHEET MD1 AND DP SHEETS.		
11 NOT USED.		
12 INSTALL TYPE 1 REST STOP. SEE DETAILS ON SHEET MD1.		
13 NOT USED. INSTALL PEDESTRIAN RAILING PER COS FIG 03-15		
(14) ON CONCRETE COPING. SEE APPENDIX B IN THE SPECIFICATIONS.		
15 INSTALL GRAVITY BLOCK WALL. SEE WALL DETAILS ON SHEET WD1. SEE WALL PROFILES ON WP SHEETS.		
16 NOT USED. INSTALL EXTRUDED CURB PER WSDOT STD PLAN		
TT F-10.42-00. SEE APPENDIX B IN THE SPECIFICATIONS.		
(18) NOT USED.		
 LEAVE 5' GAP IN FENCING FOR STAIR ACCESS. INSTALL METAL HANDRAIL PER KCRS FIG. 5-007. SEE S SHEETS FOR LIMITS AND DETAILS OF HANDRAIL. SEE APPENDIX B IN SPECIFICATIONS. 		
(2) INSTALL SLOPE PROTECTION. OMIT 0.5' SLOPE ROUNDING. SEE DETAIL 4 ON SHEET MD4.		
22 RESTORE CONCRETE STAIR LANDING PAD, SEE DETAIL 5 ON SHEET MD4.		
[23] INSTALL SLOPE PROTECTION, SEE DETAIL 4 ON SHEET MD4.		
24 NOT USED.		
25 NOT USED.		
26 INSTALL REDIROCK WALL PER DETAIL 4 ON SHEET WD1.		
27 NOT USED.		
LEGEND:		
RETAINING WALL		
WOOD GUARDRAIL		
LANDING PAD		
SLOPE PROTECTION		
GENERAL NOTES:		
 SEE UT SHEETS FOR UTILITY AND DRAINAGE IMPROVEMENTS. 		
2. SEE DP SHEETS FOR DRIVEWAY DETAILS AND GRADING.		
 EXISTING FEATURES/TREES CALLED OUT TO BE REMOVED ON SP SHEETS ARE NOT SHOWN ON AL SHEETS FOR CLARITY PURPOSES. 		
 SEE LA SHEETS FOR RESTORATION ALONG TRAIL SIDE OR ALONG BOTTOM OF WALLS. 		
5. SEE LA SHEETS FOR CUT WALL BACK SLOPE RESTORATION TREATMENT.		
CITY OF SAMMAMISH PUBLIC WORKS DEVELOPMENT REVIEW		

These drawings have been reviewed for compliance with City of Sammamish Clearing and Grading and vater requirements and also in accorda the requirements as established in the Settlement Agreement between King County vs. City of Sammarish No. C17-0921 JCC and King County vs. City of Sammarish No. 17-2-29922-7 SEA and have been deemed ACCEPTABLE. The reviewer accepts r the preparer of these drawings.

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PLAN AND PROFILE

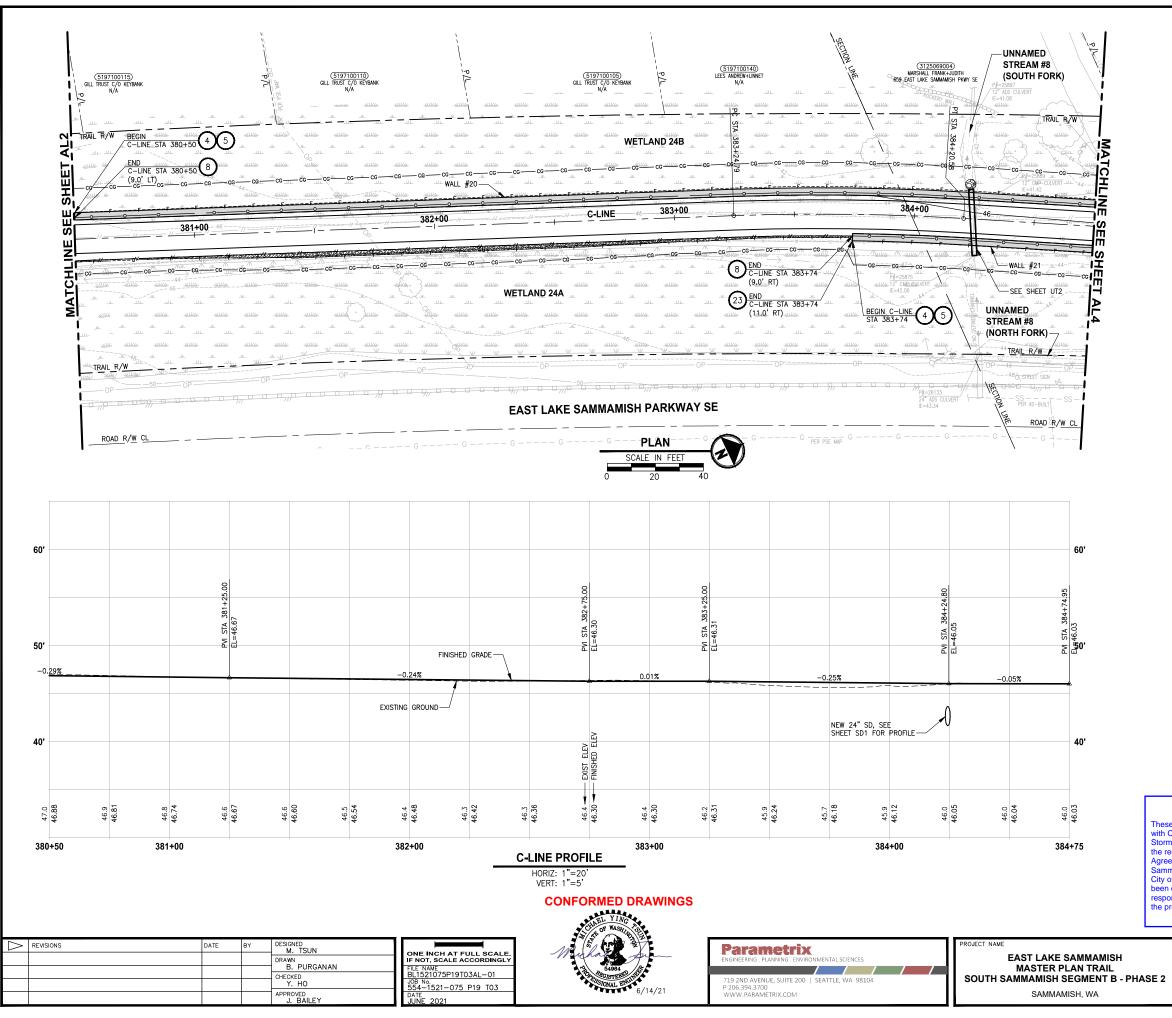

CIVIL CONSTRUCTION NOTES:		
INSTALL STAIR. CIP CONCRETE STAIR TYPE. SEE S SHEETS FOR DETAILS.		
2 NOT USED.		
3 NOT USED.		
$\overbrace{4}^{4}$ INSTALL STRUCTURAL EARTH WALL SEE WALL DETAILS ON SHEET WD1. SEE WALL PROFILES ON WP SHEETS.		
5 DETAILS ON SHEET WOLL SOLVER THAT FROM LESS ON WE SHEETS. 5 DETAILS ON SHEET MOB. SEE SHEET WOLL FOR MOUNTING ON TOP OF WALL.		
\sim		
6 NEW DRIVEWAY.		
TINSTALL WOOD GUARDRAIL, SEE DETAILS ON SHEET MD2.		
8 INSTALL 2-RAIL FENCE, SEE DETAILS ON SHEET MD3.		
(9) INSTALL CONCRETE PAD. SEE DETAIL 2 ON SHEET MD1.		
10 INSTALL ROCK WALL. SEE DETAILS ON SHEET MD1 AND DP SHEETS.		
11 NOT USED.		
12 INSTALL TYPE 1 REST STOP. SEE DETAILS ON SHEET MD1.		
13 NOT USED.		
14 INSTALL PEDESTRIAN RAILING PER COS FIG 03-15 ON CONCRETE COPING. SEE APPENDIX B IN THE SPECIFICATIONS.		
(15) INSTALL GRAVITY BLOCK WALL. SEE WALL DETAILS ON SHEET WD1. SEE WALL PROFILES ON WP SHEETS.		
16 NOT USED.		
17 INSTALL EXTRUDED CURB PER WSDOT STD PLAN F-10.42-00. SEE APPENDIX B IN THE SPECIFICATIONS.		
(18) NOT USED.		
19 LEAVE 5' GAP IN FENCING FOR STAIR ACCESS.		
20 INSTALL METAL HANDRAIL PER KCRS FIG. 5-007. SEE S SHEETS FOR LIMITS AND DETAILS OF HANDRAIL. SEE APPENDIX B IN SPECIFICATIONS.		
(21) INSTALL SLOPE PROTECTION. OMIT 0.5' SLOPE ROUNDING. SEE DETAIL 4 ON SHEET MD4.		
22) RESTORE CONCRETE STAIR LANDING PAD, SEE DETAIL 5 ON SHEET MD4.		
(23) INSTALL SLOPE PROTECTION, SEE DETAIL 4 ON SHEET MD4.		
24 NOT USED.		
25 NOT USED.		
(26) INSTALL REDIROCK WALL PER DETAIL 4 ON SHEET WD1.		
07 NOT USED.		
LEGEND:		
RETAINING WALL		
LANDING PAD SLOPE PROTECTION		
GENERAL NOTES:		
1. SEE UT SHEETS FOR UTILITY AND DRAINAGE		
IMPROVEMENTS.		


- 2. SEE DP SHEETS FOR DRIVEWAY DETAILS AND GRADING.
- 3. EXISTING FEATURES/TREES CALLED OUT TO BE REMOVED ON SP SHEETS ARE NOT SHOWN ON AL SHEETS FOR CLARITY PURPOSES.
- 4. SEE LA SHEETS FOR RESTORATION ALONG TRAIL SIDE OR ALONG BOTTOM OF WALLS.
- 5. SEE LA SHEETS FOR CUT WALL BACK SLOPE RESTORATION TREATMENT.

CITY OF SAMMAMISH PUBLIC WORKS DEVELOPMENT REVIEW DEVELOPMENT REVIEW These drawings have been reviewed for compliance with City of Sammamish Clearing and Grading and Stormwater requirements and also in accordance with the requirements as established in the Settlement Agreement between King County vs. City of Sammamish No. C17-0921 JCC and King County vs. City of Sammamish No. 17-2-29922-7 SEA and have been deemed ACCEPTABLE. The reviewer accepts no responsibility for any errors and/or omissions made by the preparer of these drawings. 17 February 2022 CITY OF City Engineer Community Dev

SAMMAMISH	APPROVAL
	Date
relopment	Date

PLAN AND PROFILE

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CIVIL CONSTRUCTION NOTES:
INSTALL STAIR. CIP CONCRETE STAIR TYPE. SEE S
2 NOT USED.
3 NOT USED.
INSTALL 4-FOOT COATED CHAIN LINK FENCE. SEE
5 DETAILS ON SHEET MDB. SEE SHEET WD1 FOR MOUNTING ON TOP OF WALL.
INSTALL WOOD GUARDRAIL, SEE DETAILS ON SHEET MD2.
8 INSTALL 2-RAIL FENCE, SEE DETAILS ON SHEET MD3.
9 install concrete pad. See detail 2 on sheet md1.
10 INSTALL ROCK WALL. SEE DETAILS ON SHEET MD1 AND DP SHEETS.
1) NOT USED.
12 INSTALL TYPE 1 REST STOP. SEE DETAILS ON SHEET MD1.
(13) NOT USED.
14 INSTALL PEDESTRIAN RAILING PER COS FIG 03-15 ON CONCRETE COPING. SEE APPENDIX B IN THE SPECIFICATIONS.
15 INSTALL GRAVITY BLOCK WALL. SEE WALL DETAILS ON SHEET WD1. SEE WALL PROFILES ON WP SHEETS.
16 NOT USED. INSTALL EXTRUDED CURB PER WSDOT STD PLAN
(17) F-10.42-00. SEE APPENDIX B IN THE SPECIFICATIONS.
(18) NOT USED.
 (19) LEAVE 5' GAP IN FENCING FOR STAIR ACCESS. (20) INSTALL METAL HANDRAIL PER KCRS FIG. 5-007. SEE S SHEETS FOR LIMITS AND DETAILS OF HANDRAIL. SEE APPENDIX B IN SPECIFICATIONS.
21 INSTALL SLOPE PROTECTION. OMIT 0.5' SLOPE ROUNDING. SEE DETAIL 4 ON SHEET MD4.
22 RESTORE CONCRETE STAIR LANDING PAD, SEE DETAIL 5 ON SHEET MD4.
(23) INSTALL SLOPE PROTECTION, SEE DETAIL 4 ON SHEET MD4.
(24) NOT USED.
25 NOT USED.
26 INSTALL REDIROCK WALL PER DETAIL 4 ON SHEET WD1.
(27) NOT USED.
\bigcirc
LEGEND: RETAINING WALL
WOOD GUARDRAIL
LANDING PAD
SLOPE PROTECTION
GENERAL NOTES:
 SEE UT SHEETS FOR UTILITY AND DRAINAGE IMPROVEMENTS.
2. SEE DP SHEETS FOR DRIVEWAY DETAILS AND GRADING.
 EXISTING FEATURES/TREES CALLED OUT TO BE REMOVED ON SP SHEETS ARE NOT SHOWN ON AL SHEETS FOR CLARITY PURPOSES.
4. SEE LA SHEETS FOR RESTORATION ALONG TRAIL SIDE OR ALONG BOTTOM OF WALLS.
5. SEE LA SHEETS FOR CUT WALL BACK SLOPE RESTORATION TREATMENT.
DEVELOPMENT REVIEW These drawings have been reviewed for compliance with City of Sammamish Clearing and Grading and
Stormwater requirements and also in accordance with
the requirements as established in the Settlement Agreement between King County vs. City of PROVAL

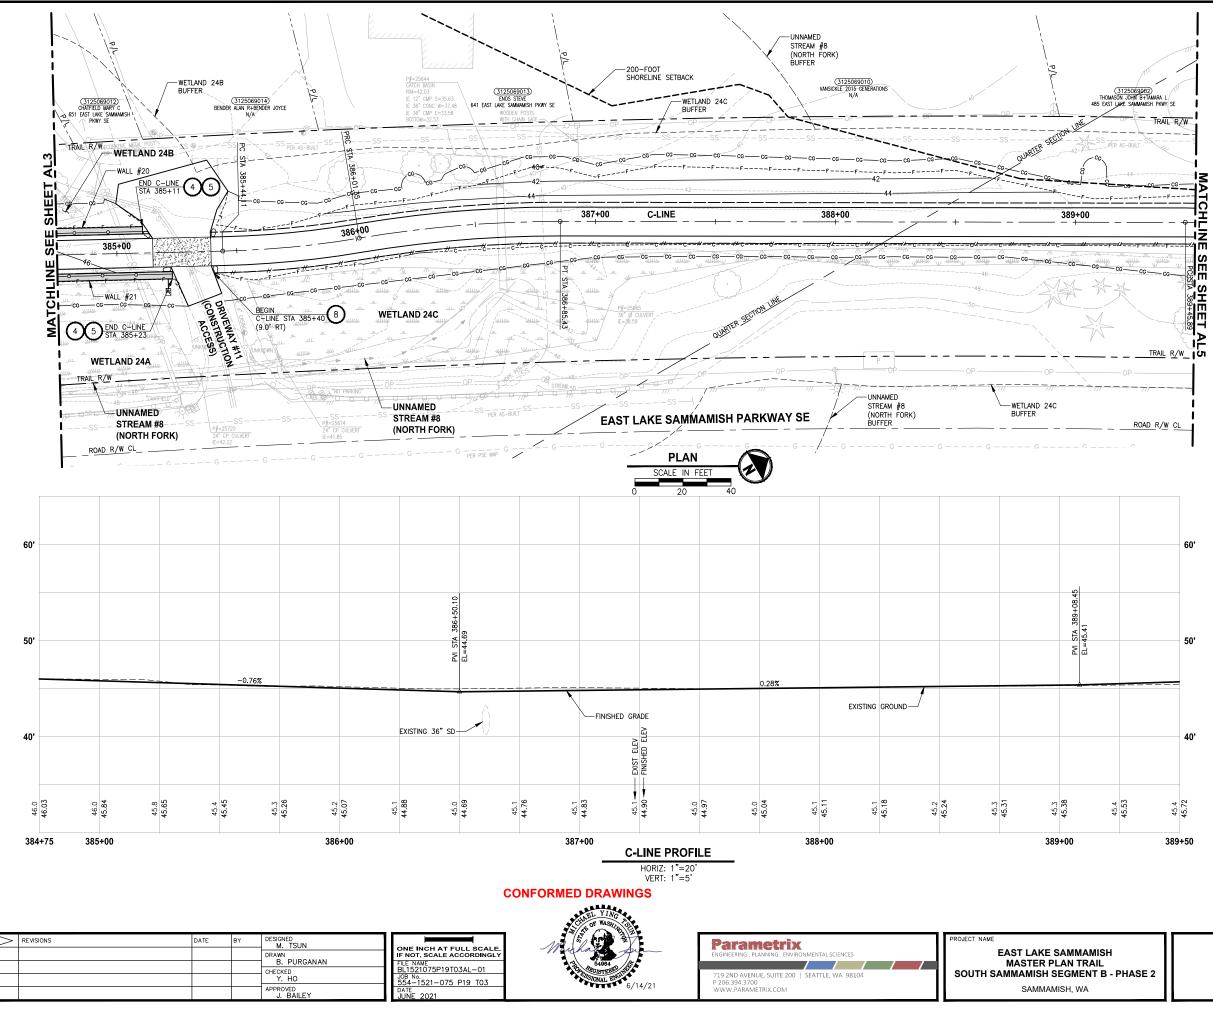PLAN AND PROFILE


Sammamish No. C17-0921 JCC and King County vs. City of Sammamish No. 17-2-29922-7 SEA and have been deemed ACCEPTABLE. The reviewePaccepts r

sions made by

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responsibility for any errors and/or omis the preparer of these drawing sment 17 February 2022




CIVIL CONSTRUCTION NOTES:		
$\overline{(1)}$	INSTALL STAIR. CIP CONCRETE STAIR TYPE. SEE S SHEETS FOR DETAILS.	
$\overbrace{2}{2}$	NOT USED.	
$\overline{\mathfrak{S}}$	NOT USED.	
$\overset{\bigcirc}{\triangleleft}$	INSTALL STRUCTURAL EARTH WALL. SEE WALL DETAILS	
	ON SHEET WD1. SEE WALL PROFILES ON WP SHEETS. INSTALL 4-FOOT COATED CHAIN LINK FENCE. SEE	
(5)	DETAILS ON SHEET MD8. SEE SHEET WD1 FOR MOUNTING ON TOP OF WALL.	
(<u>6</u>)	NEW DRIVEWAY.	
Ø	INSTALL WOOD GUARDRAIL, SEE DETAILS ON SHEET MD2.	
8	INSTALL 2-RAIL FENCE, SEE DETAILS ON SHEET MD3.	
\odot	INSTALL CONCRETE PAD. SEE DETAIL 2 ON SHEET MD1.	
10	INSTALL ROCK WALL. SEE DETAILS ON SHEET MD1 AND DP SHEETS.	
	NOT USED.	
	INSTALL TYPE 1 REST STOP. SEE DETAILS ON SHEET MD1.	
(13)	NOT USED.	
(14)	INSTALL PEDESTRIAN RAILING PER COS FIG 03-15 ON CONCRETE COPING. SEE APPENDIX B IN THE SPECIFICATIONS.	
15	INSTALL GRAVITY BLOCK WALL. SEE WALL DETAILS ON SHEET WD1. SEE WALL PROFILES ON WP SHEETS.	
(16)	NOT USED.	
	INSTALL EXTRUDED CURB PER WSDOT STD PLAN F-10.42-00. SEE APPENDIX B IN THE SPECIFICATIONS.	
(18)	NOT USED.	
(19)	LEAVE 5' GAP IN FENCING FOR STAIR ACCESS.	
20	INSTALL METAL HANDRAIL PER KCRS FIG. 5–007. SEE S SHEETS FOR LIMITS AND DETAILS OF HANDRAIL. SEE APPENDIX B IN SPECIFICATIONS.	
(21)	INSTALL SLOPE PROTECTION. OMIT 0.5' SLOPE ROUNDING. SEE DETAIL 4 ON SHEET MD4.	
(22)	RESTORE CONCRETE STAIR LANDING PAD, SEE DETAIL 5 ON SHEET MD4.	
$\tilde{23}$	INSTALL SLOPE PROTECTION, SEE DETAIL 4 ON SHEET MD4.	
24	NOT USED.	
(25)	NOT USED.	
26	INSTALL REDIROCK WALL PER DETAIL 4 ON SHEET WD1.	
(27)	NOT USED.	
LEG	END:	
	RETAINING WALL	
	WOOD GUARDRAIL	
	LANDING PAD	
SLOPE PROTECTION		
<u>GENERAL NOTES:</u>		
	E UT SHEETS FOR UTILITY AND DRAINAGE PROVEMENTS.	
	E DP SHEETS FOR DRIVEWAY DETAILS AND GRADING.	
3. EX ON CL	ISTING FEATURES/TREES CALLED OUT TO BE REMOVED I SP SHEETS ARE NOT SHOWN ON AL SHEETS FOR ARITY PURPOSES.	

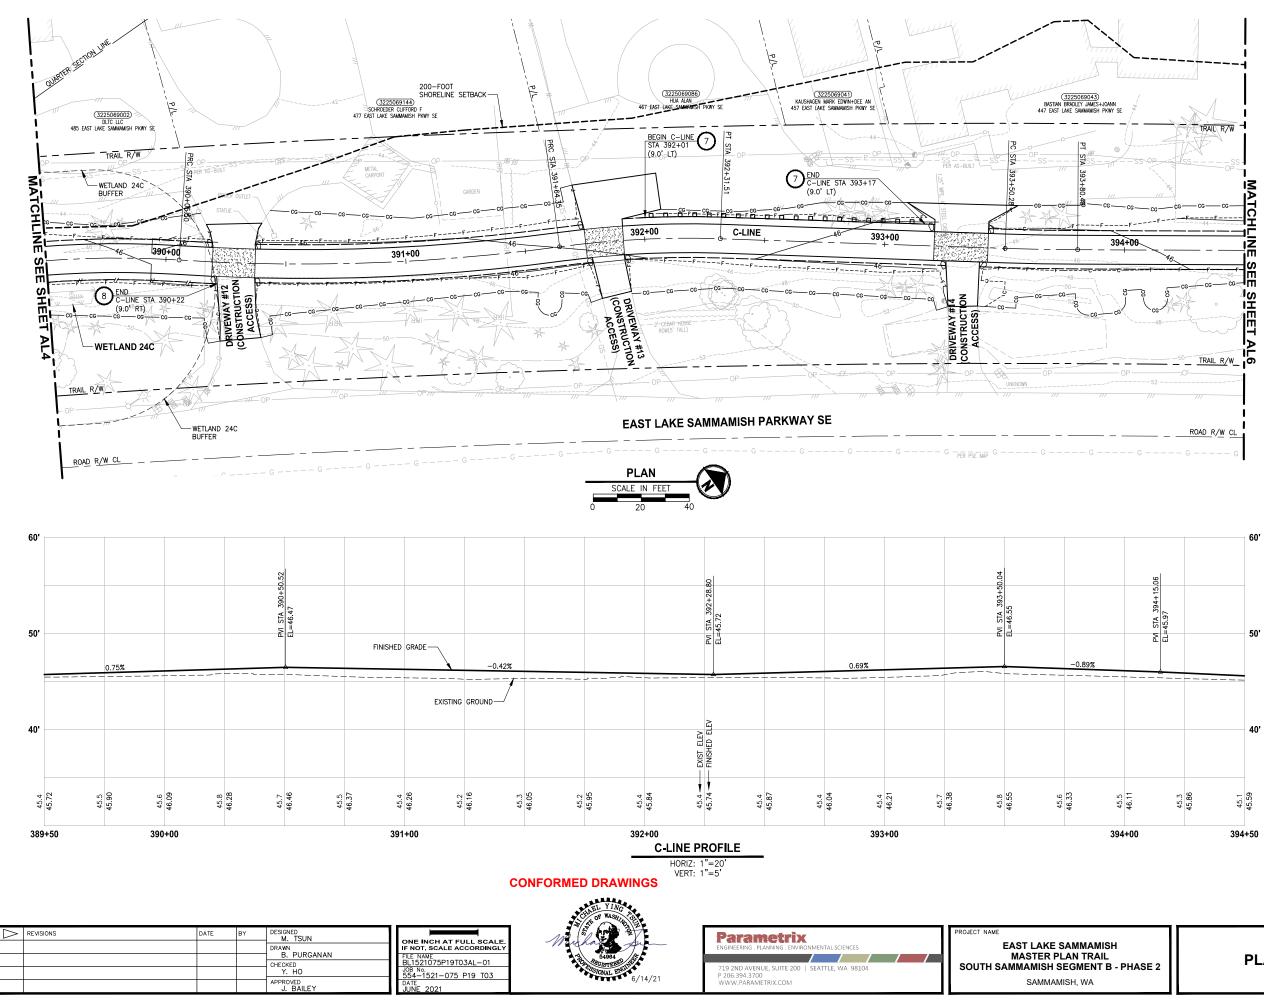- 4. SEE LA SHEETS FOR RESTORATION ALONG TRAIL SIDE OR ALONG BOTTOM OF WALLS.
- 5. SEE LA SHEETS FOR CUT WALL BACK SLOPE RESTORATION TREATMENT.

CITY OF SAMMAMISH PUBLIC WORKS DEVELOPMENT REVIEW These drawings have been reviewed for compliance with City of Sammamish Clearing and Grading and Stormwater requirements and also in accordance with Stormwater requirements and also in accordance with the requirements, as established in the Settlement. Agreement between King County vs. City of Sammamish No. C17-0921 JCC and King County vs. City of Sammamish No. 17-2-29922-7 SEA and have been deemed ACCEPTABLE. The reviewer accepts n responsibility for any errors and/or omissions made by the preparec of these drawings.

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PLAN AND PROFILE

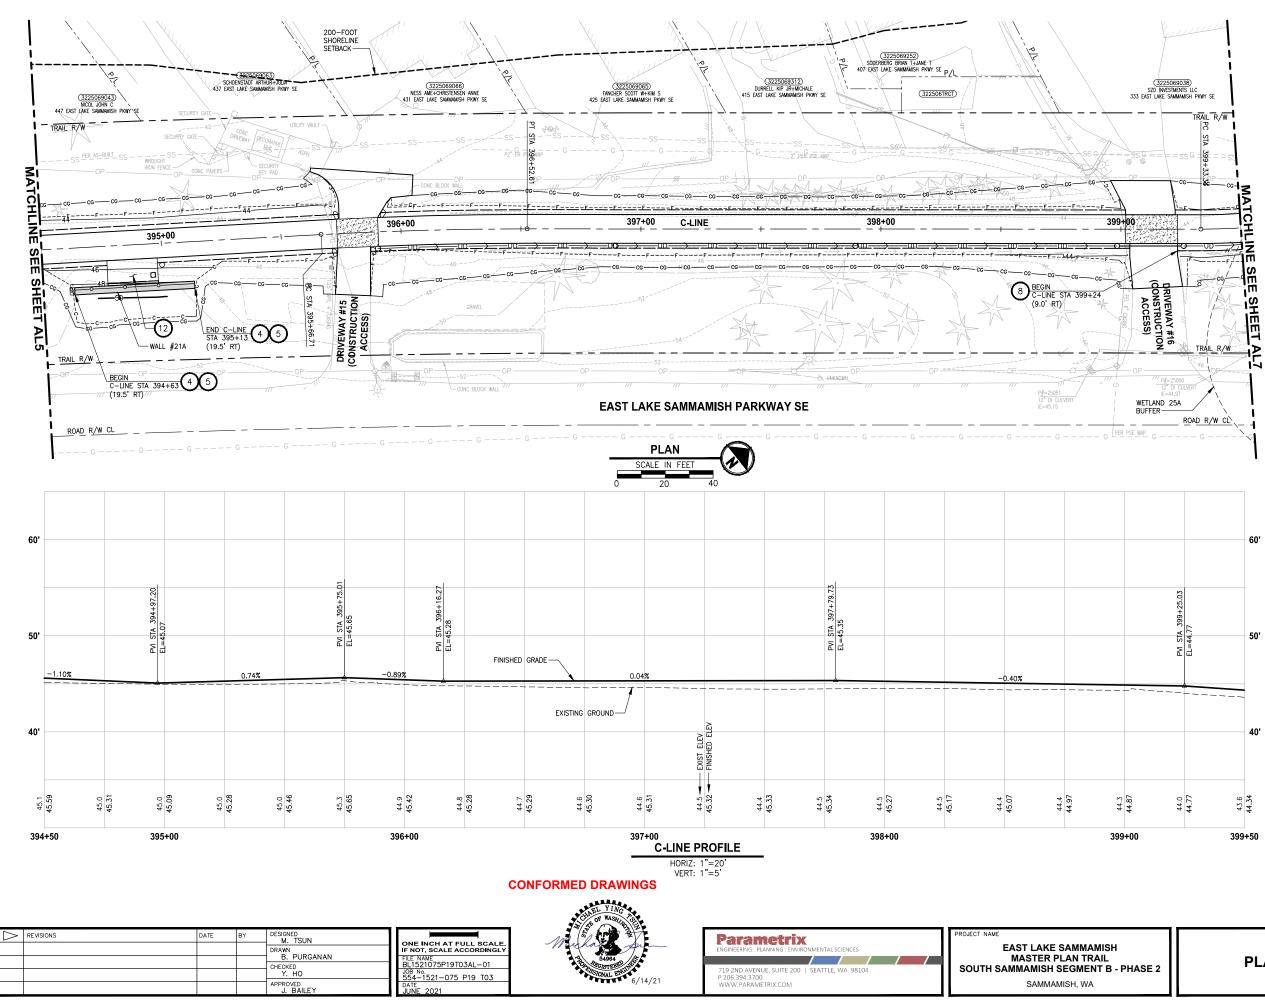


CIVIL CONSTRUCTION NOTES:
1 INSTALL STAIR. CIP CONCRETE STAIR TYPE. SEE S SHEETS FOR DETAILS.
2 NOT USED.
3 NOT USED.
$\overbrace{4}^{\fbox}$ install structural earth wall. See wall details on sheet wd1. See wall profiles on wp sheets.
5 INSTALL 4-FOOT COATED CHAIN LINK FENCE. SEE DETAILS ON SHEET MD8. SEE SHEET WD1 FOR MOUNTING ON TOP OF WALL.
6 NEW DRIVEWAY.
INSTALL WOOD GUARDRAIL, SEE DETAILS ON SHEET MD2.
8 INSTALL 2-RAIL FENCE, SEE DETAILS ON SHEET MD3.
9 INSTALL CONCRETE PAD. SEE DETAIL 2 ON SHEET MD1.
10 INSTALL ROCK WALL. SEE DETAILS ON SHEET MD1 AND DP SHEETS.
11 NOT USED.
12 INSTALL TYPE 1 REST STOP. SEE DETAILS ON SHEET MD1.
13 NOT USED.
INSTALL PEDESTRIAN RAILING PER COS FIG 03-15 ON CONCRETE COPING. SEE APPENDIX B IN THE SPECIFICATIONS.
15 INSTALL GRAVITY BLOCK WALL. SEE WALL DETAILS ON SHEET WD1. SEE WALL PROFILES ON WP SHEETS.
(16) NOT USED.
INSTALL EXTRUDED CURB PER WSDOT STD PLAN F-10.42-00. SEE APPENDIX B IN THE SPECIFICATIONS.
(18) NOT USED.
 (19) LEAVE 5' GAP IN FENCING FOR STAIR ACCESS. (20) INSTALL METAL HANDRAIL PER KCRS FIG. 5-007. SEE S SHEETS FOR LIMITS AND DETAILS OF HANDRAIL. SEE APPENDIX B IN SPECIFICATIONS.
21 INSTALL SLOPE PROTECTION. OMIT 0.5' SLOPE ROUNDING. SEE DETAIL 4 ON SHEET MD4.
22 RESTORE CONCRETE STAIR LANDING PAD, SEE DETAIL 5 ON SHEET MD4.
23 INSTALL SLOPE PROTECTION, SEE DETAIL 4 ON SHEET MD4.
(24) NOT USED.
25 NOT USED.
26 INSTALL REDIROCK WALL PER DETAIL 4 ON SHEET WD1.
27 NOT USED.
LEGEND:
RETAINING WALL
LANDING PAD
SLOPE PROTECTION
GENERAL NOTES:
1. SEE UT SHEETS FOR UTILITY AND DRAINAGE IMPROVEMENTS.
2. SEE DP SHEETS FOR DRIVEWAY DETAILS AND GRADING.
 EXISTING FEATURES/TREES CALLED OUT TO BE REMOVED ON SP SHEETS ARE NOT SHOWN ON AL SHEETS FOR CLARITY PURPOSES.
 SEE LA SHEETS FOR RESTORATION ALONG TRAIL SIDE OR ALONG BOTTOM OF WALLS.
5. SEE LA SHEETS FOR CUT WALL BACK SLOPE RESTORATION TREATMENT.

CITY OF SAMMAMISH PUBLIC WORKS DEVELOPMENT REVIEW These drawings have been reviewed for compliance with City of Sammamish Clearing and Grading and vater requirements and also in accord the requirements as established in the Settle Agreement between King County vs. City of Sammamish No. C17-0921 JCC and King County vs. City of Sammamish No. 17-2-29922-7 SEA and have been deemed ACCEPTABLE. The reviewer accepts n responsibility for any errors and/or omissions made by the preparer of these drawings! 17 February 2022

PLAN AND PROFILE

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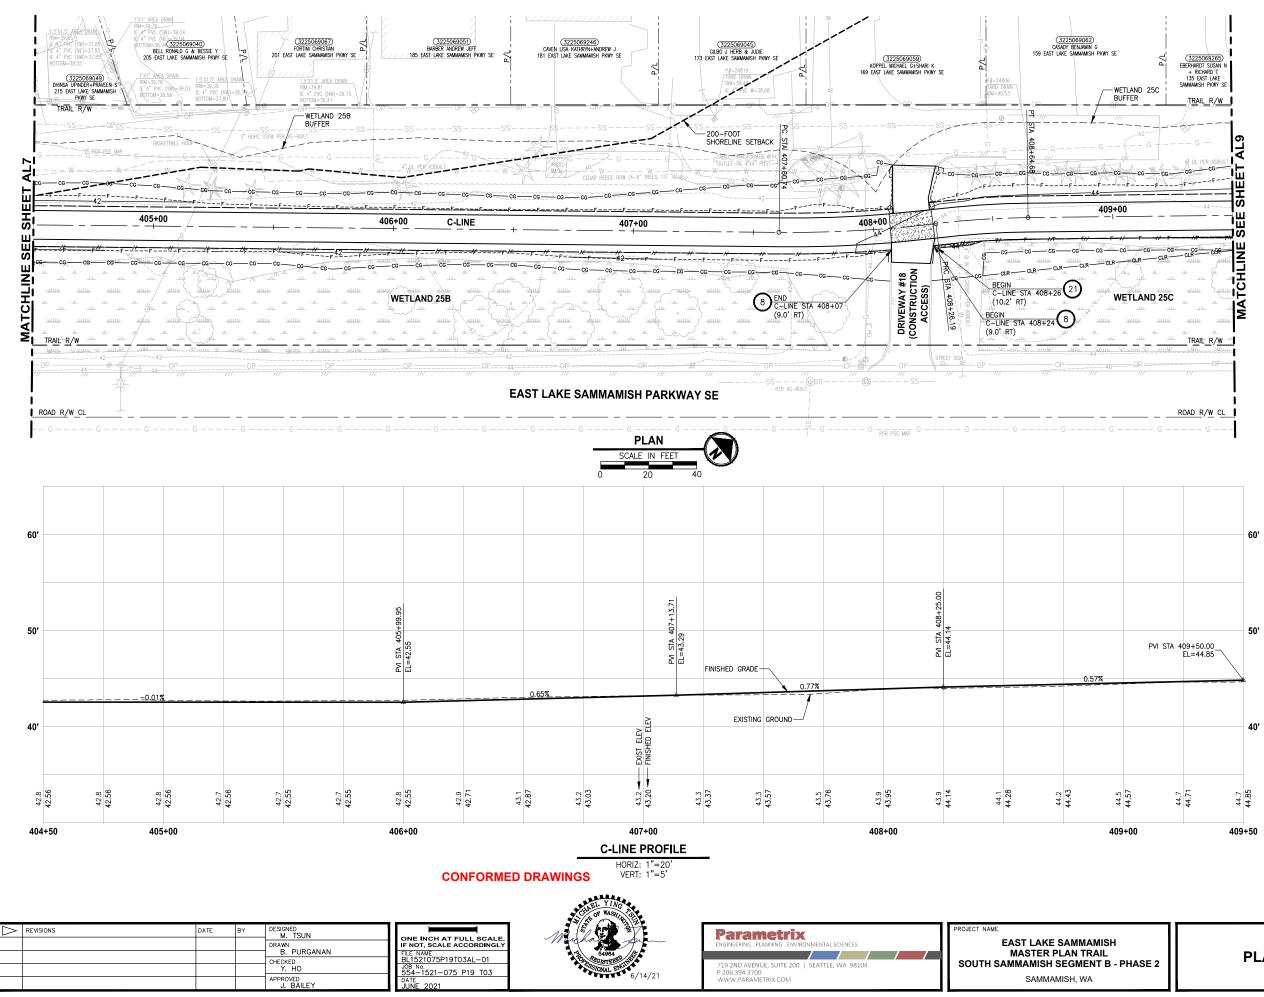


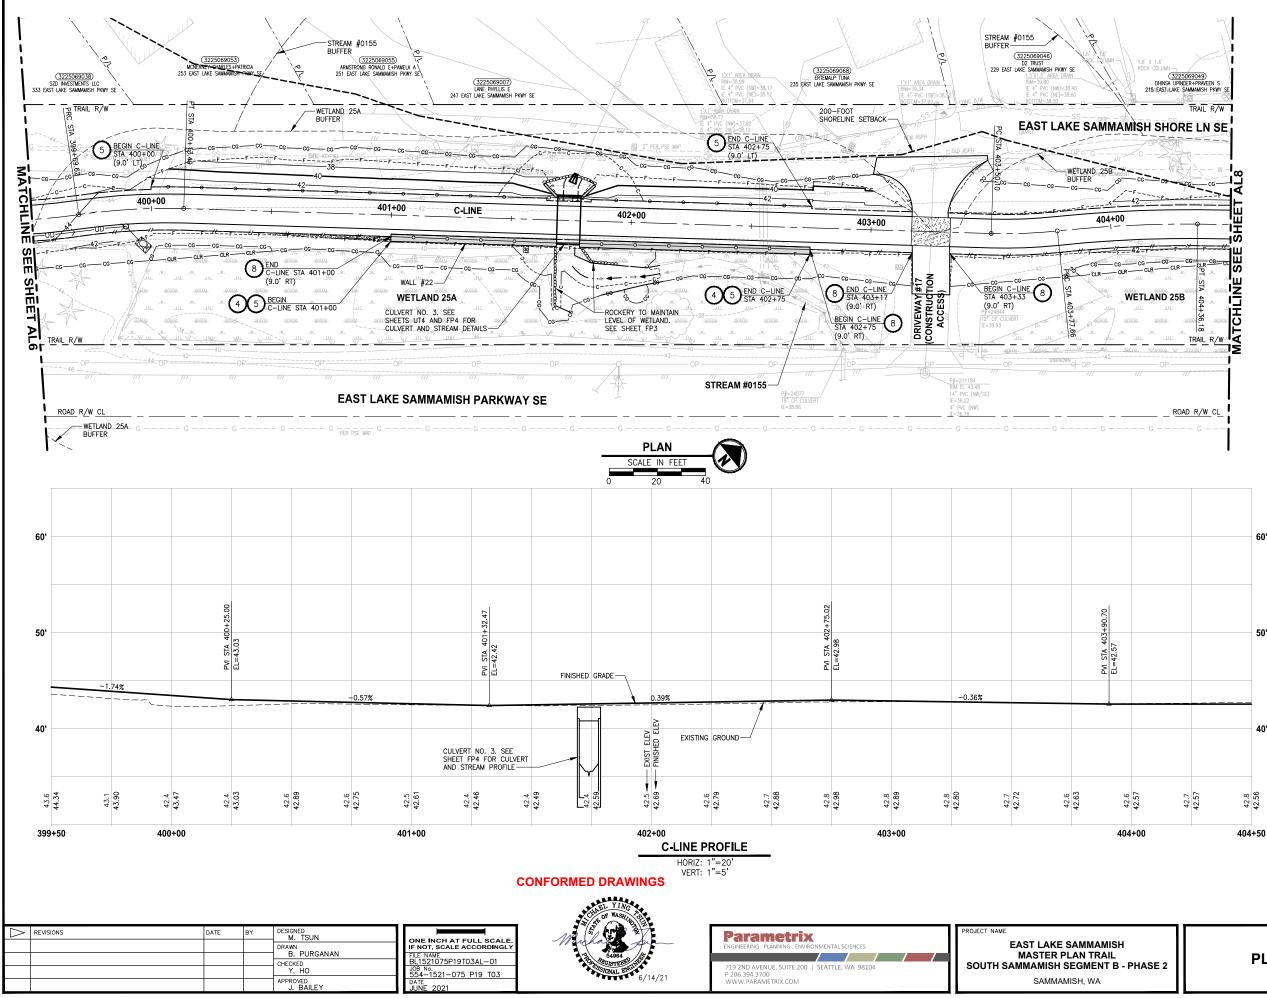00	404	+50
7.24	4 2.57 42.8	42.56
		40'
		50
		50'

CIVIL CONSTRUCTION NOTES:	
(1)	INSTALL STAIR. CIP CONCRETE STAIR TYPE. SEE S SHEETS FOR DETAILS.
(2)	NOT USED.
$\breve{\mathfrak{S}}$	NOT USED.
$\overbrace{4}{4}$	INSTALL STRUCTURAL EARTH WALL. SEE WALL DETAILS ON SHEET WD1. SEE WALL PROFILES ON WP SHEETS.
5	INSTALL 4-FOOT COATED CHAIN LINK FENCE. SEE DETAILS ON SHEET MD8. SEE SHEET WD1 FOR MOUNTING ON TOP OF WALL.
Õ	NEW DRIVEWAY.
ă	INSTALL WOOD GUARDRAIL, SEE DETAILS ON
ă	SHEET MD2. INSTALL 2-RAIL FENCE, SEE DETAILS ON SHEET MD3.
ð	INSTALL CONCRETE PAD. SEE DETAIL 2 ON SHEET MD1.
$\tilde{0}$	INSTALL ROCK WALL. SEE DETAILS ON SHEET MD1
M	AND DP SHEETS. NOT USED.
	INSTALL TYPE 1 REST STOP. SEE DETAILS ON
X	SHEET MD1.
	NOT USED. INSTALL PEDESTRIAN RAILING PER COS FIG 03-15
(14)	ON CONCRETE COPING. SEE APPENDIX B IN THE SPECIFICATIONS.
	INSTALL GRAVITY BLOCK WALL. SEE WALL DETAILS ON SHEET WD1. SEE WALL PROFILES ON WP SHEETS.
	NOT USED. INSTALL EXTRUDED CURB PER WSDOT STD PLAN
(17)	F-10.42-00. SEE APPENDIX B IN THE SPECIFICATIONS.
	NOT USED.
(19)	LEAVE 5' GAP IN FENCING FOR STAIR ACCESS.
20	INSTALL METAL HANDRAIL PER KCRS FIG. 5–007. SEE S SHEETS FOR LIMITS AND DETAILS OF HANDRAIL. SEE APPENDIX B IN SPECIFICATIONS.
(21)	INSTALL SLOPE PROTECTION. OMIT 0.5' SLOPE ROUNDING. SEE DETAIL 4 ON SHEET MD4.
(22)	RESTORE CONCRETE STAIR LANDING PAD, SEE DETAIL 5 ON SHEET MD4.
(23)	INSTALL SLOPE PROTECTION, SEE DETAIL 4 ON SHEET MD4.
(24)	NOT USED.
(25)	NOT USED.
(26)	INSTALL REDIROCK WALL PER DETAIL 4 ON SHEET WD1.
(27)	NOT USED.
LEG	END:
	RETAINING WALL
	WOOD GUARDRAIL
	LANDING PAD
10.4	IERAL NOTES:
1. SE	E UT SHEETS FOR UTILITY AND DRAINAGE
	PROVEMENTS. E DP SHEETS FOR DRIVEWAY DETAILS AND GRADING.
3. EX	ISTING FEATURES/TREES CALLED OUT TO BE REMOVED
4. SE	ARITY PURPOSES. E LA SHEETS FOR RESTORATION ALONG TRAIL SIDE ALONG BOTTOM OF WALLS.
5. SEE LA SHEETS FOR CUT WALL BACK SLOPE RESTORATION TREATMENT.	
	CITY OF SAMMAMISH PUBLIC WORKS
	DEVELOPMENT REVIEW se drawings have been reviewed for compliance
Stor	City of Sammamish Clearing and Grading and mwater requirements and also in accordance with
Agre	requirements as established in the Settlement cement between King County vs. City of
City	of Sammanish No. 17-2-29922-7 SEA and have
resp	n deemed ACCEPTABLE. The reviewer accepts no ponsibility for any errors and/or omissions made by
ine	preparer of these drawings. 17 February 2022

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PLAN AND PROFILE




CIV	L CONSTRUCTION NOTES:	
(1)	INSTALL STAIR. CIP CONCRETE STAIR TYPE. SEE S SHEETS FOR DETAILS.	
(2)	NOT USED.	
(3)	NOT USED.	
(4)	INSTALL STRUCTURAL EARTH WALL. SEE WALL DETAILS ON SHEET WD1. SEE WALL PROFILES ON WP SHEETS.	
5	INSTALL 4-FOOT COATED CHAIN LINK FENCE. SEE DETAILS ON SHEET MDB. SEE SHEET WD1 FOR MOUNTING ON TOP OF WALL.	
6	NEW DRIVEWAY.	
()	INSTALL WOOD GUARDRAIL, SEE DETAILS ON SHEET MD2.	
(8)	INSTALL 2-RAIL FENCE, SEE DETAILS ON SHEET MD3.	
Ő	INSTALL CONCRETE PAD. SEE DETAIL 2 ON SHEET MD1.	
(10)	INSTALL ROCK WALL. SEE DETAILS ON SHEET MD1 AND DP SHEETS.	
(11)	NOT USED.	
	INSTALL TYPE 1 REST STOP. SEE DETAILS ON SHEET MD1.	
(13)	NOT USED.	
(14)	INSTALL PEDESTRIAN RAILING PER COS FIG 03-15 ON CONCRETE COPING. SEE APPENDIX B IN THE SPECIFICATIONS.	
	INSTALL GRAVITY BLOCK WALL. SEE WALL DETAILS ON SHEET WD1. SEE WALL PROFILES ON WP SHEETS.	
(16)	NOT USED.	
(17)	INSTALL EXTRUDED CURB PER WSDOT STD PLAN F-10.42-00. SEE APPENDIX B IN THE SPECIFICATIONS.	
(18)	NOT USED.	
$\begin{pmatrix} 19\\ 20 \end{pmatrix}$	LEAVE 5' GAP IN FENCING FOR STAIR ACCESS. INSTALL METAL HANDRAIL PER KCRS FIG. 5–007. SEE S SHEETS FOR LIMITS AND DETAILS OF HANDRAIL SEE	
(2)	APPENDIX B IN SPECIFICATIONS. INSTALL SLOPE PROTECTION. OMIT 0.5' SLOPE	
(22)	ROUNDING. SEE DETAIL 4 ON SHEET MD4. RESTORE CONCRETE STAIR LANDING PAD, SEE	
(23)	DETAIL 5 ON SHEET MD4. INSTALL SLOPE PROTECTION, SEE DETAIL 4 ON	
X	SHEET MD4.	
	NOT USED.	
	NOT USED.	
	INSTALL REDIROCK WALL PER DETAIL 4 ON SHEET WD1.	
(27)	NOT USED.	
LEG	END: RETAINING WALL	
	WOOD GUARDRAIL	
	LANDING PAD	
	SLOPE PROTECTION	
GENERAL NOTES:		
	E UT SHEETS FOR UTILITY AND DRAINAGE PROVEMENTS.	
2. SE	E DP SHEETS FOR DRIVEWAY DETAILS AND GRADING.	
ON	ISTING FEATURES/TREES CALLED OUT TO BE REMOVED I SP SHEETS ARE NOT SHOWN ON AL SHEETS FOR ARITY PURPOSES.	
	E LA SHEETS FOR RESTORATION ALONG TRAIL SIDE ALONG BOTTOM OF WALLS.	
	E LA SHEETS FOR CUT WALL BACK SLOPE STORATION TREATMENT.	

CITY OF SAMMAMISH PUBLIC WORKS DEVELOPMENT REVIEW These drawings have been reviewed for com with City of Sammamish Clearing and Grading and Stormwater requirements and also in accordance with Agreement between King County vs. City of Sammamish No. C17-0921 JCC and King County vs. City of Sammamish No. 17-2-29922-7 SEA and have been deamed ACCEPTABLE. The reviewer accepts n responsibility for any errors and/or omissions made by the preparer of these drawings.

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PLAN AND PROFILE

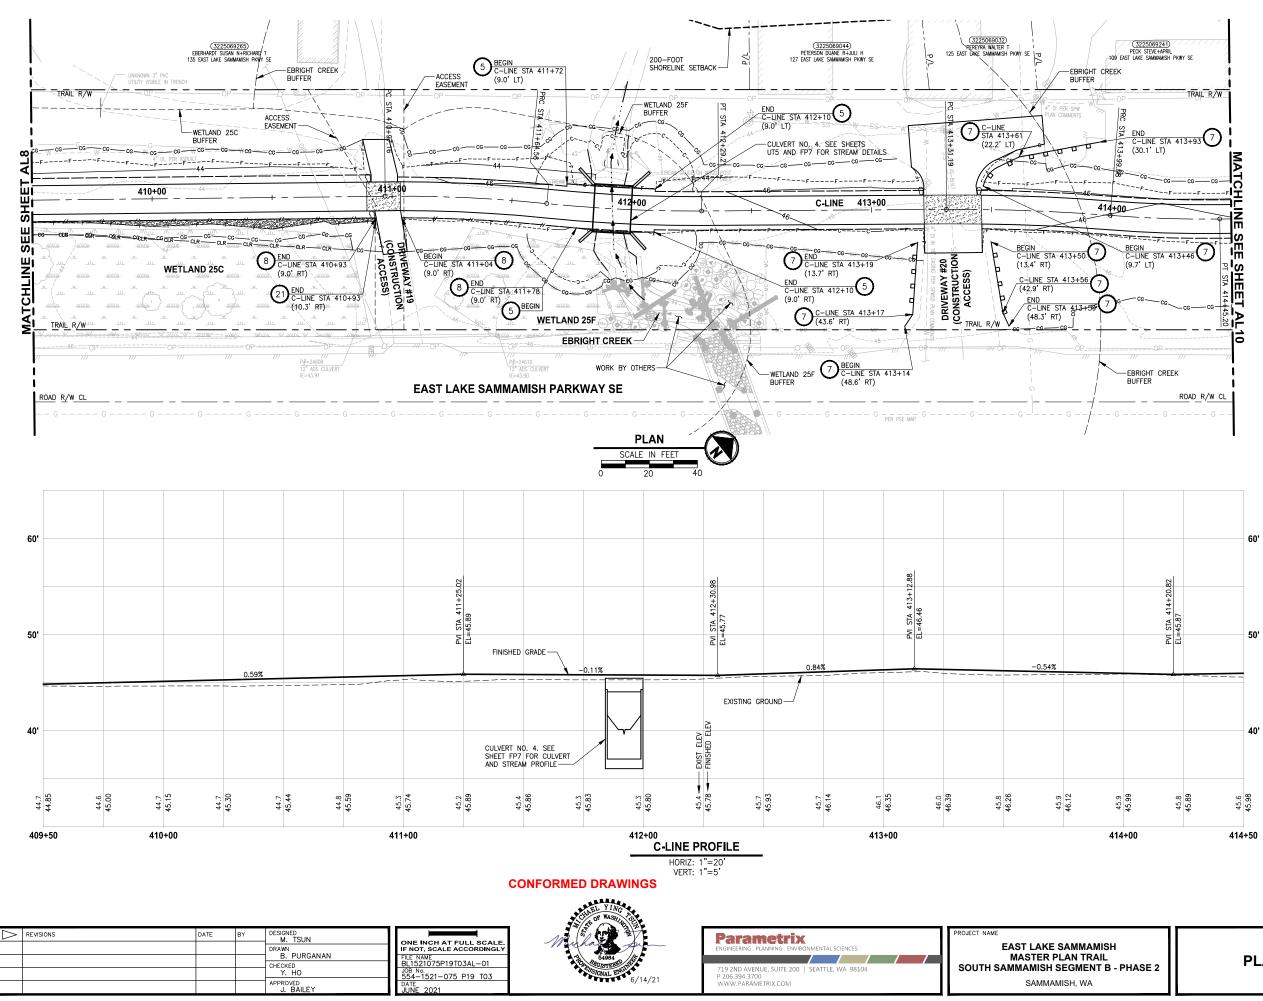



-		L CONSTRUCTION NOTES:
(1	INSTALL STAIR. CIP CONCRETE STAIR TYPE. SEE S SHEETS FOR DETAILS.
(2)	NOT USED.
(3)	NOT USED.
(4)	INSTALL STRUCTURAL EARTH WALL. SEE WALL DETAILS ON SHEET WD1. SEE WALL PROFILES ON WP SHEETS.
(5	INSTALL 4-FOOT COATED CHAIN LINK FENCE. SEE DETAILS ON SHEET MDB. SEE SHEET WD1 FOR MOUNTING ON TOP OF WALL.
(6	NEW DRIVEWAY.
(7	INSTALL WOOD GUARDRAIL, SEE DETAILS ON SHEET MD2.
(8	INSTALL 2-RAIL FENCE, SEE DETAILS ON SHEET MD3.
(୭	INSTALL CONCRETE PAD. SEE DETAIL 2 ON SHEET MD1.
(10	INSTALL ROCK WALL. SEE DETAILS ON SHEET MD1 AND DP SHEETS.
(11)	NOT USED.
(12	INSTALL TYPE 1 REST STOP. SEE DETAILS ON SHEET MD1.
(13)	NOT USED.
(14	INSTALL PEDESTRIAN RAILING PER COS FIG 03-15 ON CONCRETE COPING. SEE APPENDIX B IN THE SPECIFICATIONS.
(15	INSTALL GRAVITY BLOCK WALL. SEE WALL DETAILS ON SHEET WD1. SEE WALL PROFILES ON WP SHEETS.
(16)	NOT USED.
(17	INSTALL EXTRUDED CURB PER WSDOT STD PLAN F-10.42-00. SEE APPENDIX B IN THE SPECIFICATIONS.
(18)	NOT USED.
(19	LEAVE 5' GAP IN FENCING FOR STAIR ACCESS.
(20	INSTALL METAL HANDRAIL PER KCRS FIG. 5-007. SEE S SHEETS FOR LIMITS AND DETAILS OF HANDRAIL. SEE APPENDIX B IN SPECIFICATIONS.
(21)	INSTALL SLOPE PROTECTION. OMIT 0.5' SLOPE ROUNDING. SEE DETAIL 4 ON SHEET MD4.
(22)	RESTORE CONCRETE STAIR LANDING PAD, SEE DETAIL 5 ON SHEET MD4.
(23)	INSTALL SLOPE PROTECTION, SEE DETAIL 4 ON SHEET MD4.
(24)	NOT USED.
(25	NOT USED.
(26)	INSTALL REDIROCK WALL PER DETAIL 4 ON SHEET WD1.
(27)	NOT USED.
L	.EG	END:
		RETAINING WALL
-		WOOD GUARDRAIL
	<u>7</u>	SLOPE PROTECTION
r	10.9	ERAL NOTES:
<u> </u>	SE	E UT SHEETS FOR UTILITY AND DRAINAGE PROVEMENTS.
2.	SE	E DP SHEETS FOR DRIVEWAY DETAILS AND GRADING.
3.	٥N	ISTING FEATURES/TREES CALLED OUT TO BE REMOVED SP SHEETS ARE NOT SHOWN ON AL SHEETS FOR ARITY PURPOSES.
4.	SE OF	E LA SHEETS FOR RESTORATION ALONG TRAIL SIDE ALONG BOTTOM OF WALLS.
5.		E LA SHEETS FOR CUT WALL BACK SLOPE STORATION TREATMENT.
[CITY OF SAMMAMISH PUBLIC WORKS
	The	DEVELOPMENT REVIEW ase drawings have been reviewed for compliance

with City of Sammamish Clearing and Grading and Stormwater requirements and also in accordance with Agreement between King County vs. City of Sammamish No. C17-0921 JCC and King County vs. City of Sammamish No. 17-2-29922-7 SEA and have been deemied ACCEPTABLE. The reviewer accepts n responsibility for any errors and/or omissions made by the preparer of these drawings.

SHEET NO. 50 OF 213

PLAN AND PROFILE

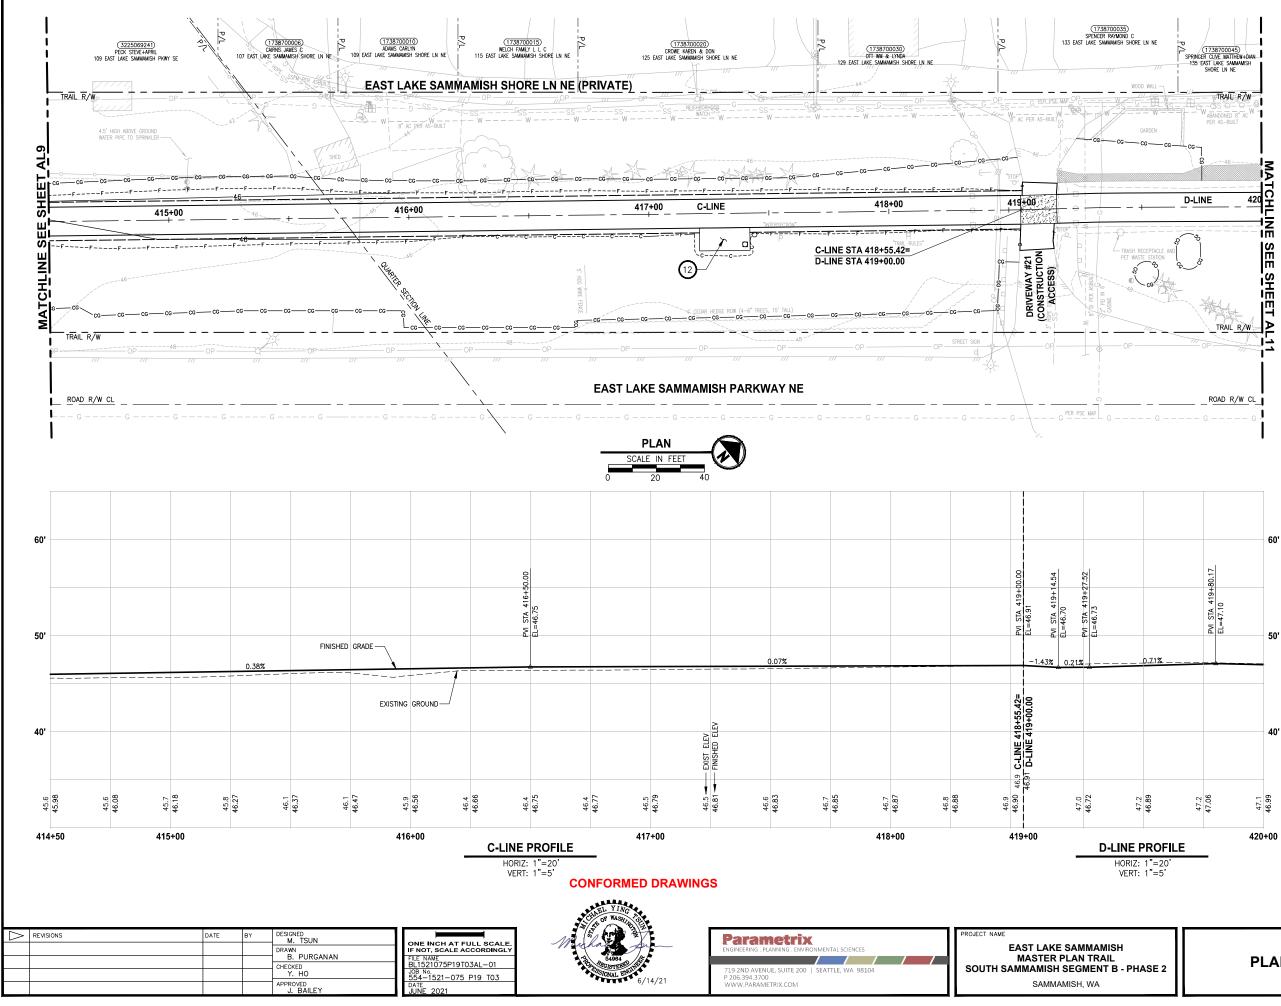

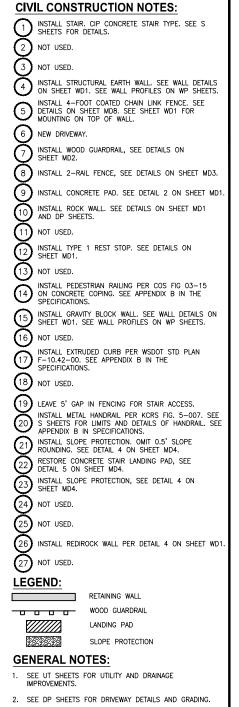


- EXISTING FEATURES/TREES CALLED OUT TO BE REMOVED ON SP SHEETS ARE NOT SHOWN ON AL SHEETS FOR CLARITY PURPOSES.
- 4. SEE LA SHEETS FOR RESTORATION ALONG TRAIL SIDE OR ALONG BOTTOM OF WALLS.
- 5. SEE LA SHEETS FOR CUT WALL BACK SLOPE RESTORATION TREATMENT.

CITY OF SAMMAMISH PUBLIC WORKS DEVELOPMENT REVIEW These drawings have been reviewed for con with City of Sammamish Clearing and Grading and Stormwater requirements and also in accordance with City of Sammamish No. 17-2-29922-7 SEA and have been deemed ACCEPTABLE. The reviewer accepts r esponsibility for any errors and/or omissions made by the preparer of these drawings.

SHEET NO. 51 OF 213

PLAN AND PROFILE

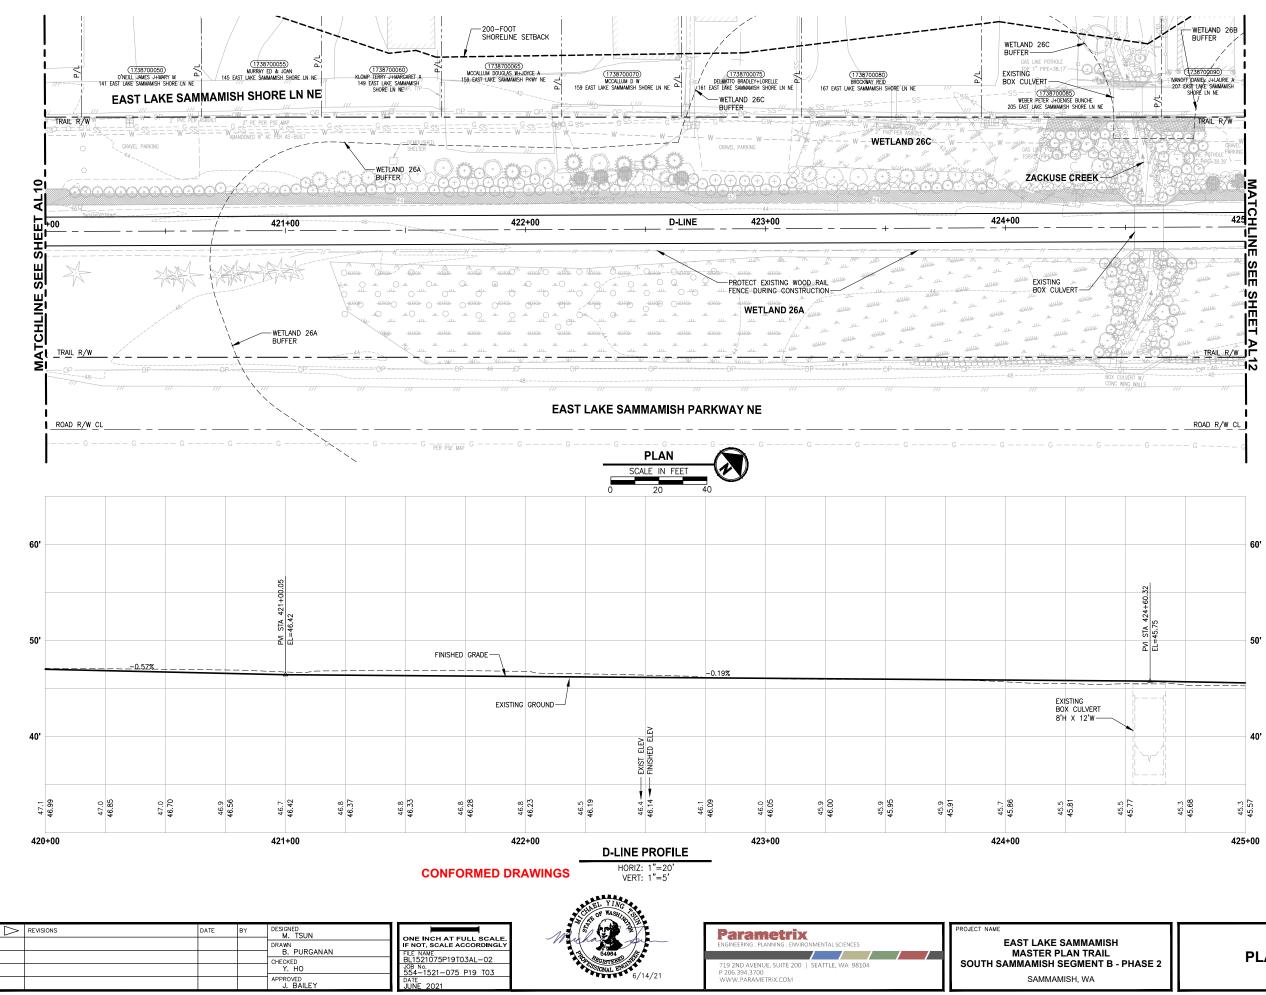


CIVIL CONSTRUCTION NOTES:		
(1)	INSTALL STAIR. CIP CONCRETE STAIR TYPE. SEE S SHEETS FOR DETAILS.	
$\overline{(2)}$	NOT USED.	
$(\tilde{3})$	NOT USED.	
$\check{4}$	INSTALL STRUCTURAL EARTH WALL. SEE WALL DETAILS ON SHEET WD1. SEE WALL PROFILES ON WP SHEETS.	
5	INSTALL 4-FOOT COATED CHAIN LINK FENCE. SEE DETAILS ON SHEET MDB. SEE SHEET WD1 FOR MOUNTING ON TOP OF WALL.	
6	NEW DRIVEWAY.	
Õ	INSTALL WOOD GUARDRAIL, SEE DETAILS ON SHEET MD2.	
(8)	INSTALL 2-RAIL FENCE, SEE DETAILS ON SHEET MD3.	
Ō	INSTALL CONCRETE PAD. SEE DETAIL 2 ON SHEET MD1.	
(10)	INSTALL ROCK WALL. SEE DETAILS ON SHEET MD1 AND DP SHEETS.	
$(\tilde{1})$	NOT USED.	
	INSTALL TYPE 1 REST STOP. SEE DETAILS ON SHEET MD1.	
(13)	NOT USED.	
14	INSTALL PEDESTRIAN RAILING PER COS FIG 03-15 ON CONCRETE COPING. SEE APPENDIX B IN THE SPECIFICATIONS.	
(15)	INSTALL GRAVITY BLOCK WALL. SEE WALL DETAILS ON SHEET WD1. SEE WALL PROFILES ON WP SHEETS.	
(16)	NOT USED.	
	INSTALL EXTRUDED CURB PER WSDOT STD PLAN F-10.42-00. SEE APPENDIX B IN THE SPECIFICATIONS.	
(18)	NOT USED.	
(19) (20)	LEAVE 5' GAP IN FENCING FOR STAIR ACCESS. INSTALL METAL HANDRAIL PER KCRS FIG. 5-007. SEE S SHEETS FOR LIMITS AND DETAILS OF HANDRAIL. SEE APPENDIX B IN SPECIFICATIONS.	
$\tilde{(2)}$	INSTALL SLOPE PROTECTION. OMIT 0.5' SLOPE ROUNDING. SEE DETAIL 4 ON SHEET MD4.	
(22)	RESTORE CONCRETE STAIR LANDING PAD, SEE DETAIL 5 ON SHEET MD4.	
(23)	INSTALL SLOPE PROTECTION, SEE DETAIL 4 ON SHEET MD4.	
24	NOT USED.	
25	NOT USED.	
26	INSTALL REDIROCK WALL PER DETAIL 4 ON SHEET WD1.	
27	NOT USED.	
LĒG	END:	
	RETAINING WALL	
	WOOD GUARDRAIL	
	LANDING PAD	
8	SLOPE PROTECTION	
GEN	IERAL NOTES:	
	E UT SHEETS FOR UTILITY AND DRAINAGE PROVEMENTS.	
2. SE	E DP SHEETS FOR DRIVEWAY DETAILS AND GRADING.	
3. EX ON CL	ISTING FEATURES/TREES CALLED OUT TO BE REMOVED I SP SHEETS ARE NOT SHOWN ON AL SHEETS FOR ARITY PURPOSES.	
	E LA SHEETS FOR RESTORATION ALONG TRAIL SIDE 2 ALONG BOTTOM OF WALLS.	
	E LA SHEETS FOR CUT WALL BACK SLOPE STORATION TREATMENT.	
	CITY OF SAMMAMISH PUBLIC WORKS DEVELOPMENT REVIEW	

These drawings have been reviewed for compliance with City of Sammamish Clearing and Grading and Stormwater requirements and also in accordance with the requirements as established in the Settle Agreement between King County vs. City of Sammamish No. C17-0921 JCC and King County vs. City of Sammamish No. 17-2-29922-7 SEA and have been deemed ACCEPTABLE. The reviewer accepts n responsibility for any errors and/or om ssions made by the preparer of these drawings. Date 17 February 2022


SHEET NO. 52 OF 213

PLAN AND PROFILE

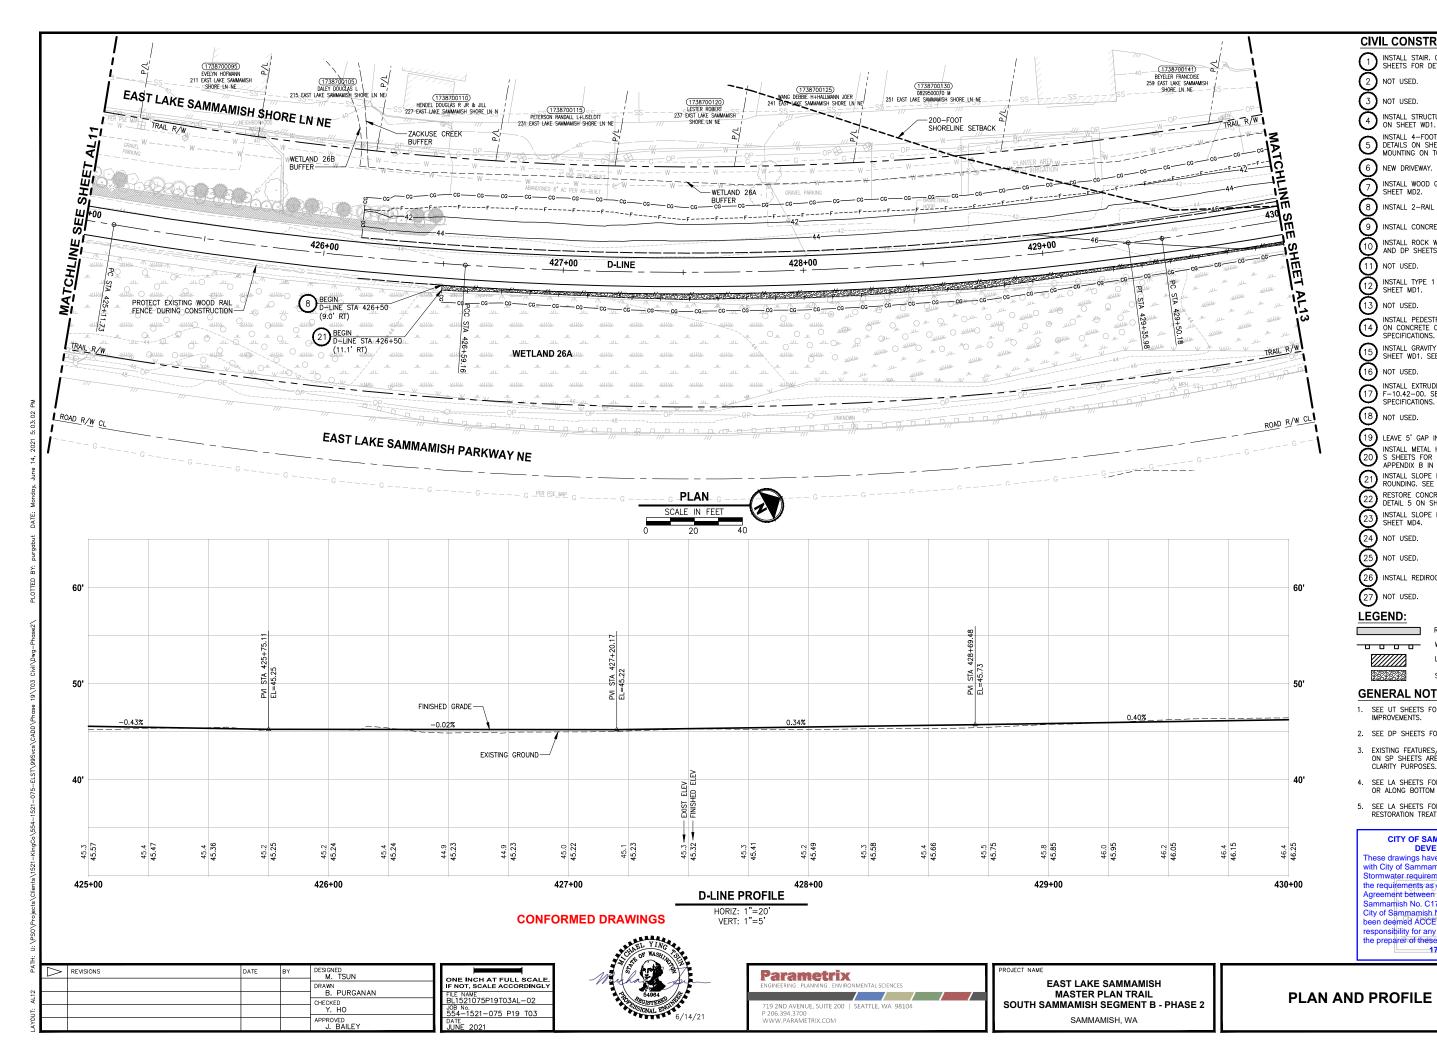

	L CONSTRUCTION NOTES:
1	INSTALL STAIR. CIP CONCRETE STAIR TYPE. SEE S SHEETS FOR DETAILS.
2	NOT USED.
3	NOT USED.
(4)	INSTALL STRUCTURAL EARTH WALL. SEE WALL DETAILS ON SHEET WD1. SEE WALL PROFILES ON WP SHEETS.
5	INSTALL 4-FOOT COATED CHAIN LINK FENCE. SEE DETAILS ON SHEET MD8. SEE SHEET WD1 FOR MOUNTING ON TOP OF WALL.
6	NEW DRIVEWAY.
\bigcirc	INSTALL WOOD GUARDRAIL, SEE DETAILS ON SHEET MD2.
8	INSTALL 2-RAIL FENCE, SEE DETAILS ON SHEET MD3.
9	INSTALL CONCRETE PAD. SEE DETAIL 2 ON SHEET MD1.
10	INSTALL ROCK WALL. SEE DETAILS ON SHEET MD1 AND DP SHEETS.
(1)	NOT USED.
	INSTALL TYPE 1 REST STOP. SEE DETAILS ON SHEET MD1.
(13)	NOT USED.
(14)	INSTALL PEDESTRIAN RAILING PER COS FIG 03-15 ON CONCRETE COPING. SEE APPENDIX B IN THE SPECIFICATIONS.
(15)	INSTALL GRAVITY BLOCK WALL. SEE WALL DETAILS ON SHEET WD1. SEE WALL PROFILES ON WP SHEETS.
(16)	NOT USED.
	INSTALL EXTRUDED CURB PER WSDOT STD PLAN F-10.42-00. SEE APPENDIX B IN THE SPECIFICATIONS.
	NOT USED.
(19)	LEAVE 5' GAP IN FENCING FOR STAIR ACCESS.
20	INSTALL METAL HANDRAIL PER KCRS FIG. 5–007. SEE S SHEETS FOR LIMITS AND DETAILS OF HANDRAIL. SEE APPENDIX B IN SPECIFICATIONS.
(21)	INSTALL SLOPE PROTECTION. OMIT 0.5' SLOPE ROUNDING. SEE DETAIL 4 ON SHEET MD4.
(22)	RESTORE CONCRETE STAIR LANDING PAD, SEE DETAIL 5 ON SHEET MD4.
(23)	INSTALL SLOPE PROTECTION, SEE DETAIL 4 ON SHEET MD4.
(24)	NOT USED.
(25)	NOT USED.
(26)	INSTALL REDIROCK WALL PER DETAIL 4 ON SHEET WD1.
(27)	NOT USED.
LEG	END:
	RETAINING WALL
	WOOD GUARDRAIL
2	SLOPE PROTECTION
	IERAL NOTES:
1. SE	E UT SHEETS FOR UTILITY AND DRAINAGE PROVEMENTS.
	e dp sheets for driveway details and grading.
ON	ISTING FEATURES/TREES CALLED OUT TO BE REMOVED I SP SHEETS ARE NOT SHOWN ON AL SHEETS FOR ARITY PURPOSES.
4. SE	E LA SHEETS FOR RESTORATION ALONG TRAIL SIDE R ALONG BOTTOM OF WALLS.
5. SE	E LA SHEETS FOR CUT WALL BACK SLOPE STORATION TREATMENT.
	CITY OF SAMMAMISH PUBLIC WORKS
	DEVELOPMENT REVIEW se drawings have been reviewed for compliance
Stor	City of Sammamish Clearing and Grading and mwater requirements and also in accordance with
Agre	equirements as established in the Settlement
City	marhish No. C17-0921 JCC and King County vs. of Sammarish No. 17-2-29922-7 SEA and have
beer resp	n deemed ACCEPTABLE. The reviewer accepts no onsibility for any errors and/or omissions made by
the p	breparercof these drawings. 17 February 2022

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CIVIL CONSTRUCTION NOTES.			
1	INSTALL STAIR. CIP CONCRETE STAIR TYPE. SEE S SHEETS FOR DETAILS.		
(2)	NOT USED.		
$(\bar{3})$	NOT USED.		
(4)	INSTALL STRUCTURAL EARTH WALL. SEE WALL DETAILS ON SHEET WD1. SEE WALL PROFILES ON WP SHEETS.		
5	INSTALL 4-FOOT COATED CHAIN LINK FENCE. SEE DETAILS ON SHEET MD8. SEE SHEET WD1 FOR MOUNTING ON TOP OF WALL.		
(6)	NEW DRIVEWAY.		
Ō	INSTALL WOOD GUARDRAIL, SEE DETAILS ON SHEET MD2.		
8	INSTALL 2-RAIL FENCE, SEE DETAILS ON SHEET MD3.		
٩	INSTALL CONCRETE PAD. SEE DETAIL 2 ON SHEET MD1.		
$\overline{(0)}$	INSTALL ROCK WALL. SEE DETAILS ON SHEET MD1 AND DP SHEETS.		
	NOT USED.		
$\overline{(12)}$	INSTALL TYPE 1 REST STOP. SEE DETAILS ON SHEET MD1.		
(13)	NOT USED.		
14	INSTALL PEDESTRIAN RAILING PER COS FIG 03-15 ON CONCRETE COPING. SEE APPENDIX B IN THE SPECIFICATIONS.		
(15)	INSTALL GRAVITY BLOCK WALL. SEE WALL DETAILS ON SHEET WD1. SEE WALL PROFILES ON WP SHEETS.		
(16)	NOT USED.		
$\tilde{0}$	INSTALL EXTRUDED CURB PER WSDOT STD PLAN F-10.42-00. SEE APPENDIX B IN THE SPECIFICATIONS.		
18	NOT USED.		
(19)	LEAVE 5' GAP IN FENCING FOR STAIR ACCESS.		
$\widecheck{20}$	INSTALL METAL HANDRAIL PER KCRS FIG. 5–007. SEE S SHEETS FOR LIMITS AND DETAILS OF HANDRAIL. SEE APPENDIX B IN SPECIFICATIONS.		
(21)	INSTALL SLOPE PROTECTION. OMIT 0.5' SLOPE ROUNDING, SEE DETAIL 4 ON SHEET MD4.		
$\widetilde{(22)}$	RESTORE CONCRETE STAIR LANDING PAD, SEE DETAIL 5 ON SHEET MD4.		
$\widecheck{23}$	INSTALL SLOPE PROTECTION, SEE DETAIL 4 ON SHEET MD4.		
(24)	NOT USED.		
(25)	NOT USED.		
26	INSTALL REDIROCK WALL PER DETAIL 4 ON SHEET WD1.		
$\overline{(27)}$	NOT USED.		
LEGEND:			
	RETAINING WALL		

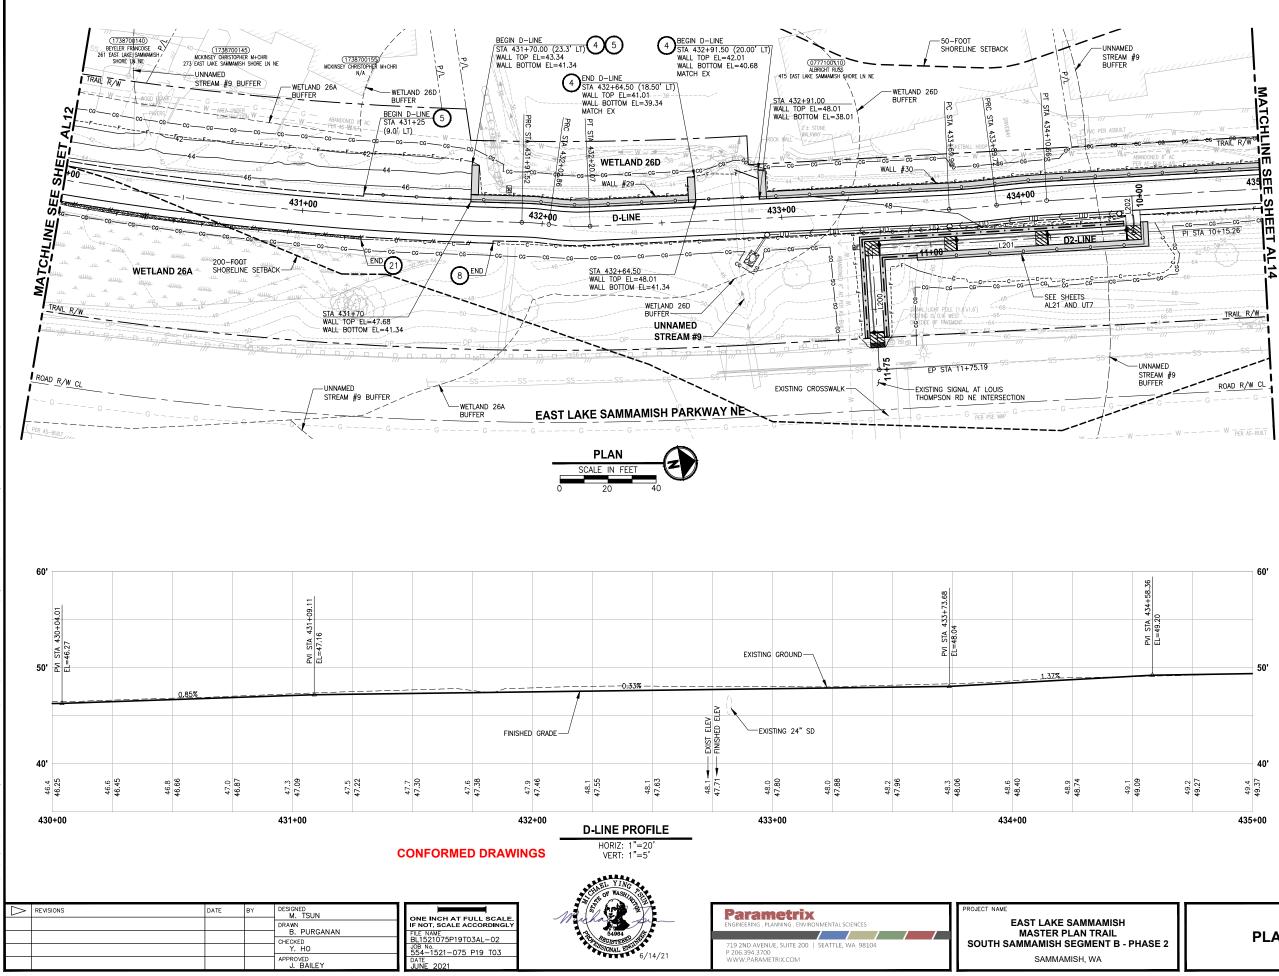CIVIL CONSTRUCTION NOTES:

WOOD GUARDRAIL *7777*77

LANDING PAD

SLOPE PROTECTION


GENERAL NOTES:

- 1. SEE UT SHEETS FOR UTILITY AND DRAINAGE IMPROVEMENTS.
- 2. SEE DP SHEETS FOR DRIVEWAY DETAILS AND GRADING.
- 3. EXISTING FEATURES/TREES CALLED OUT TO BE REMOVED ON SP SHEETS ARE NOT SHOWN ON AL SHEETS FOR CLARITY PURPOSES.
- 4. SEE LA SHEETS FOR RESTORATION ALONG TRAIL SIDE OR ALONG BOTTOM OF WALLS.
- 5. SEE LA SHEETS FOR CUT WALL BACK SLOPE RESTORATION TREATMENT.

CITY OF SAMMAMISH PUBLIC WORKS DEVELOPMENT REVIEW These drawings have been reviewed for compliance with City of Sammamish Clearing and Grading and Stormwater requirements and also in accordance with the requirements as established in the Settlement Agreement between King County vs. City of Sammamish No. C17-0921 JCC and King County vs. City of Sammamish No. 17-2-29922-7 SEA and have been deamed ACCEPTABLE. The reviewer accepts n responsibility for any errors and/or omissions made by the preparer of these drawings.

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PLAN AND PROFILE

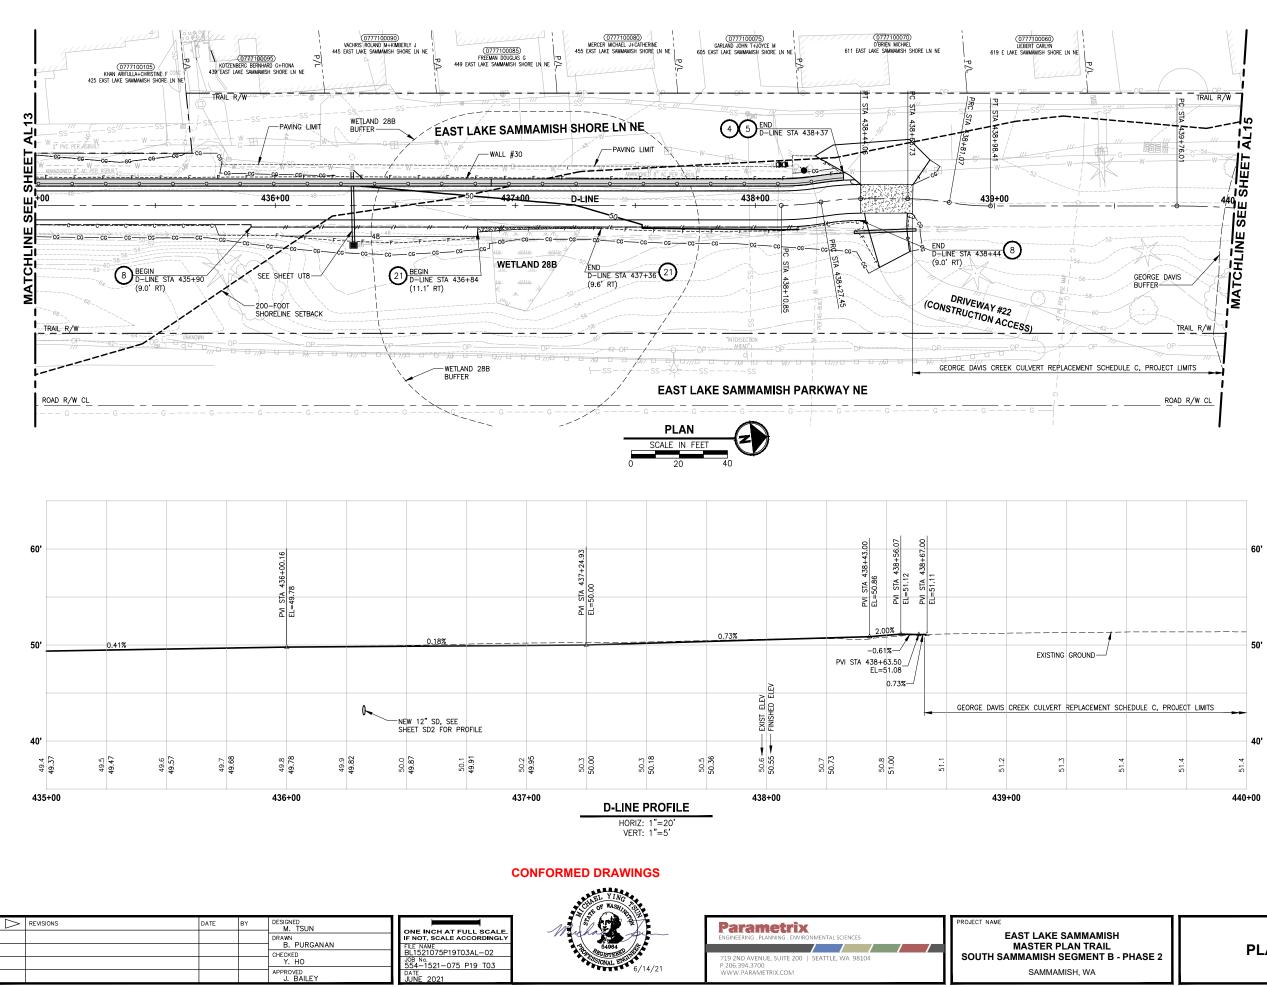

	VIL CONSTRUCTION NOTES:	
(1)	INSTALL STAIR. CIP CONCRETE STAIR TYPE. SEE S SHEETS FOR DETAILS.	
(2)	NOT USED.	
3	NOT USED.	
(4	INSTALL STRUCTURAL EARTH WALL. SEE WALL DETAILS ON SHEET WD1. SEE WALL PROFILES ON WP SHEETS.	
5	INSTALL 4-FOOT COATED CHAIN LINK FENCE. SEE DETAILS ON SHEET MD8. SEE SHEET WD1 FOR MOUNTING ON TOP OF WALL.	
6	NEW DRIVEWAY.	
Õ	INSTALL WOOD GUARDRAIL, SEE DETAILS ON SHEET MD2.	
(8	INSTALL 2-RAIL FENCE, SEE DETAILS ON SHEET MD3.	
9	INSTALL CONCRETE PAD. SEE DETAIL 2 ON SHEET MD1.	
	INSTALL ROCK WALL. SEE DETAILS ON SHEET MD1 AND DP SHEETS.	
(11	NOT USED.	
	INSTALL TYPE 1 REST STOP. SEE DETAILS ON SHEET MD1.	
(13	NOT USED.	
	INSTALL PEDESTRIAN RAILING PER COS FIG 03-15 ON CONCRETE COPING. SEE APPENDIX B IN THE SPECIFICATIONS.	
	INSTALL GRAVITY BLOCK WALL. SEE WALL DETAILS ON SHEET WD1. SEE WALL PROFILES ON WP SHEETS.	
(16	NOT USED.	
Ū	INSTALL EXTRUDED CURB PER WSDOT STD PLAN F-10.42-00. SEE APPENDIX B IN THE SPECIFICATIONS.	
(18	NOT USED.	
(19	LEAVE 5' GAP IN FENCING FOR STAIR ACCESS.	
20	INSTALL METAL HANDRAIL PER KCRS FIG. 5-007. SEE	
(21	NSTALL SLOPE PROTECTION. OMIT 0.5' SLOPE ROUNDING. SEE DETAIL 4 ON SHEET MD4.	
\tilde{c}_2	DESTORE CONCRETE STAIR LANDING DAD. SEE	
$\tilde{2}$		
\widetilde{c}_{4}		
(25	NOT USED.	
(26	INSTALL REDIROCK WALL PER DETAIL 4 ON SHEET WD1.	
(27	NOT USED.	
LE	GEND:	
	RETAINING WALL	
-0	WOOD GUARDRAIL	
	LANDING PAD	
	SLOPE PROTECTION	
GENERAL NOTES:		
	SEE UT SHEETS FOR UTILITY AND DRAINAGE	
2.	SEE DP SHEETS FOR DRIVEWAY DETAILS AND GRADING.	
3.	EXISTING FEATURES/TREES CALLED OUT TO BE REMOVED ON SP SHEETS ARE NOT SHOWN ON AL SHEETS FOR CLARITY PURPOSES.	

CIVIL CONSTRUCTION NOTES:


- 4. SEE LA SHEETS FOR RESTORATION ALONG TRAIL SIDE OR ALONG BOTTOM OF WALLS.
- 5. SEE LA SHEETS FOR CUT WALL BACK SLOPE RESTORATION TREATMENT.

CITY OF SAMMAMISH PUBLIC WORKS DEVELOPMENT REVIEW These drawings have been reviewed for compliance with City of Sammamish Clearing and Grading and Stormwater requirements and also in accordance with the requirements as established in the Settle Agreement between King County vs. City of Sammamish No. C17-0921 JCC and King County vs. City of Sammamish No. 17-2-29922-7 SEA and have een deemed ACCEPTABLE. The reviewer accepts responsibility for any errors and/or omissions made by the preparer of these drawings.

17 February 2022

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PLAN AND PROFILE

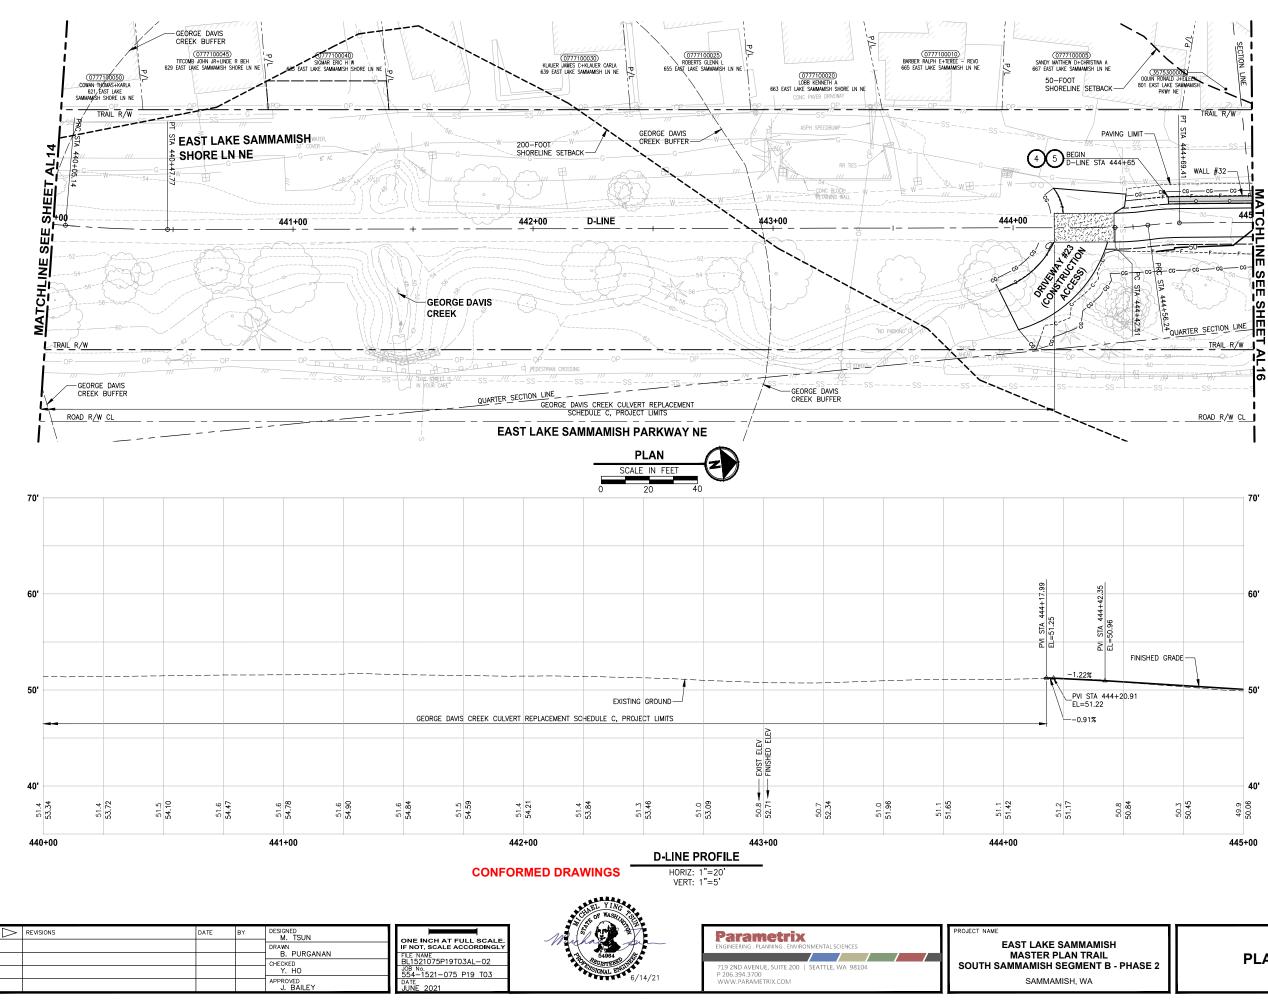

CIVIL CONSTRUCTION NOTES: (1) INSTALL STAIR. CIP CONCRETE STAIR TYPE. SEE S SHEETS FOR DETAILS.

2 NOT USED.

3 NOT USED.

 $\overline{4}$ install structural earth wall. See wall details on sheet wd1. See wall profiles on wp sheets. 5 INSTALL 4-FOOT COATED CHAIN LINK FENCE. SEE DETAILS ON SHEET MD8. SEE SHEET WD1 FOR MOUNTING ON TOP OF WALL. 6 NEW DRIVEWAY.

T INSTALL WOOD GUARDRAIL, SEE DETAILS ON SHEET MD2.

(8) INSTALL 2-RAIL FENCE, SEE DETAILS ON SHEET MD3.

(9) INSTALL CONCRETE PAD. SEE DETAIL 2 ON SHEET MD

10 INSTALL ROCK WALL. SEE DETAILS ON SHEET MD1 AND DP SHEETS.

(11) NOT USED.

12 INSTALL TYPE 1 REST STOP. SEE DETAILS ON SHEET MD1.

13 NOT USED.

14 INSTALL PEDESTRIAN RAILING PER COS FIG 03-15 ON CONCRETE COPING. SEE APPENDIX B IN THE SPECIFICATIONS.

 $\overbrace{15}^{\text{ISTALL}}$ gravity block wall. See wall details on sheet wd1. See wall profiles on wp sheets. 16 NOT USED.

17 INSTALL EXTRUDED CURB PER WSDOT STD PLAN F-10.42-00. SEE APPENDIX B IN THE SPECIFICATIONS.

(18) NOT USED.

(19) LEAVE 5' GAP IN FENCING FOR STAIR ACCESS. INSTALL METAL HANDRAIL PER KCRS FIG. 5-007. SEE

(20) APPENDIX B IN SPECIFICATIONS.

(21) INSTALL SLOPE PROTECTION. OMIT 0.5' SLOPE ROUNDING. SEE DETAIL 4 ON SHEET MD4. RESTORE CONCRETE STAIR LANDING PAD, SEE

(22) DETAIL 5 ON SHEET MD4.

(23) INSTALL SLOPE PROTECTION, SEE DETAIL 4 ON SHEET MD4.

(24) NOT USED.

(25) NOT USED.

(26) INSTALL REDIROCK WALL PER DETAIL 4 ON SHEET WD

27 NOT USED.

LEGEND:

*7777*77

RETAINING WALL

WOOD GUARDRAIL ______ LANDING PAD

SLOPE PROTECTION


GENERAL NOTES:

- 1. SEE UT SHEETS FOR UTILITY AND DRAINAGE IMPROVEMENTS.
- 2. SEE DP SHEETS FOR DRIVEWAY DETAILS AND GRADING.
- 3. EXISTING FEATURES/TREES CALLED OUT TO BE REMOVED ON SP SHEETS ARE NOT SHOWN ON AL SHEETS FOR CLARITY PURPOSES.
- 4. SEE LA SHEETS FOR RESTORATION ALONG TRAIL SIDE OR ALONG BOTTOM OF WALLS.
- 5. SEE LA SHEETS FOR CUT WALL BACK SLOPE RESTORATION TREATMENT.

CITY OF SAMMAMISH PUBLIC WORKS DEVELOPMENT REVIEW These drawings have been reviewed for compliance with City of Sammamish Clearing and Grading and ater requirements and also in accord the requirements as established in the Settlement Agreement between King County vs. Gity of Sammamish No. C17-0921 JCC and King County vs. City of Sammamish No. 17-2-29922-7 SEA and have been deemed ACCEPTABLE. The reviewer accepts responsibility for any errors and/or omissions made by the preparer of these drawings. Date 17 February 2022

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PLAN AND PROFILE

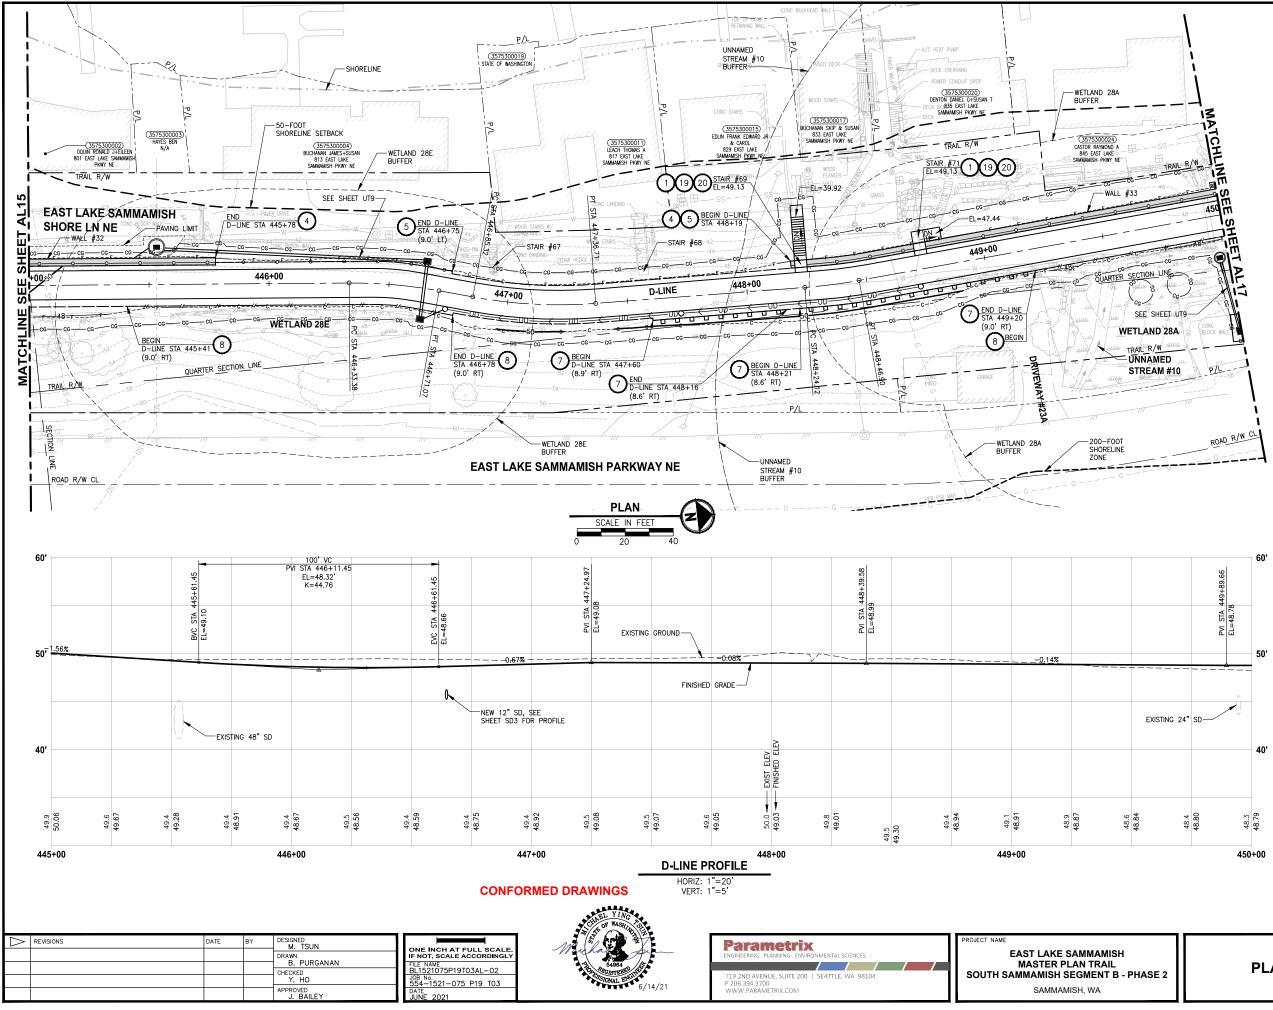

CIV	IL CONSTRUCTION NOTES:
	INSTALL STAIR. CIP CONCRETE STAIR TYPE. SEE S SHEETS FOR DETAILS.
2	NOT USED.
3	NOT USED.
$\check{4}$	INSTALL STRUCTURAL EARTH WALL. SEE WALL DETAILS ON SHEET WD1. SEE WALL PROFILES ON WP SHEETS.
5	INSTALL 4-FOOT COATED CHAIN LINK FENCE. SEE DETAILS ON SHEET MD8. SEE SHEET WD1 FOR MOUNTING ON TOP OF WALL.
6)	NEW DRIVEWAY.
Ž	INSTALL WOOD GUARDRAIL, SEE DETAILS ON SHEET MD2.
8	INSTALL 2-RAIL FENCE, SEE DETAILS ON SHEET MD3.
٩	INSTALL CONCRETE PAD. SEE DETAIL 2 ON SHEET MD1.
10	INSTALL ROCK WALL. SEE DETAILS ON SHEET MD1 AND DP SHEETS.
11)	NOT USED.
12	INSTALL TYPE 1 REST STOP. SEE DETAILS ON SHEET MD1.
13)	NOT USED.
14	INSTALL PEDESTRIAN RAILING PER COS FIG 03-15 ON CONCRETE COPING. SEE APPENDIX B IN THE SPECIFICATIONS.
15	INSTALL GRAVITY BLOCK WALL. SEE WALL DETAILS ON SHEET WD1. SEE WALL PROFILES ON WP SHEETS.
16)	NOT USED.
17	INSTALL EXTRUDED CURB PER WSDOT STD PLAN F-10.42-00. SEE APPENDIX B IN THE SPECIFICATIONS.

- (18) NOT USED.
- (19) LEAVE 5' GAP IN FENCING FOR STAIR ACCESS.
- INSTALL METAL HANDRAIL PER KCRS FIG. 5-007. SEE S SHEETS FOR LIMITS AND DETAILS OF HANDRAIL. SEE APPENDIX B IN SPECIFICATIONS. 20
- (21) INSTALL SLOPE PROTECTION. OMIT 0.5' SLOPE ROUNDING. SEE DETAIL 4 ON SHEET MD4. RESTORE CONCRETE STAIR LANDING PAD, SEE
- 22 RESTORE CONCRETE STAIF DETAIL 5 ON SHEET MD4.
- (23) INSTALL SLOPE PROTECTION, SEE DETAIL 4 ON SHEET MD4.
- (24) NOT USED.
- (25) NOT USED.
- INSTALL REDIROCK WALL PER DETAIL 4 ON SHEET WD (26)
- 27 NOT USED.

LEGEND:

*7777*77

RETAINING WALL WOOD GUARDRAIL

LANDING PAD

SLOPE PROTECTION

GENERAL NOTES:


- 1. SEE UT SHEETS FOR UTILITY AND DRAINAGE IMPROVEMENTS.
- 2. SEE DP SHEETS FOR DRIVEWAY DETAILS AND GRADING.
- 3. EXISTING FEATURES/TREES CALLED OUT TO BE REMOVED ON SP SHEETS ARE NOT SHOWN ON AL SHEETS FOR CLARITY PURPOSES.
- 4. SEE LA SHEETS FOR RESTORATION ALONG TRAIL SIDE OR ALONG BOTTOM OF WALLS.
- 5. SEE LA SHEETS FOR CUT WALL BACK SLOPE RESTORATION TREATMENT.

CITY OF SAMMAMISH PUBLIC WORKS DEVELOPMENT REVIEW These drawings have been reviewed for compliance with City of Sammamish Clearing and Grading and Stormwater requirements and also in accordance wi the requirements as established in the Settle Agreement between King County vs. City of Sammamish No. C17-0921 JCC and King County vs. City of Sammamish No. 17-2-29922-7 SEA and have een deemed ACCEPTABLE. The reviewer accepts responsibility for any errors and/or om ssions made by the preparer of these drawings.

17 February 2022

SHEET NO. 57 OF 213

PLAN AND PROFILE

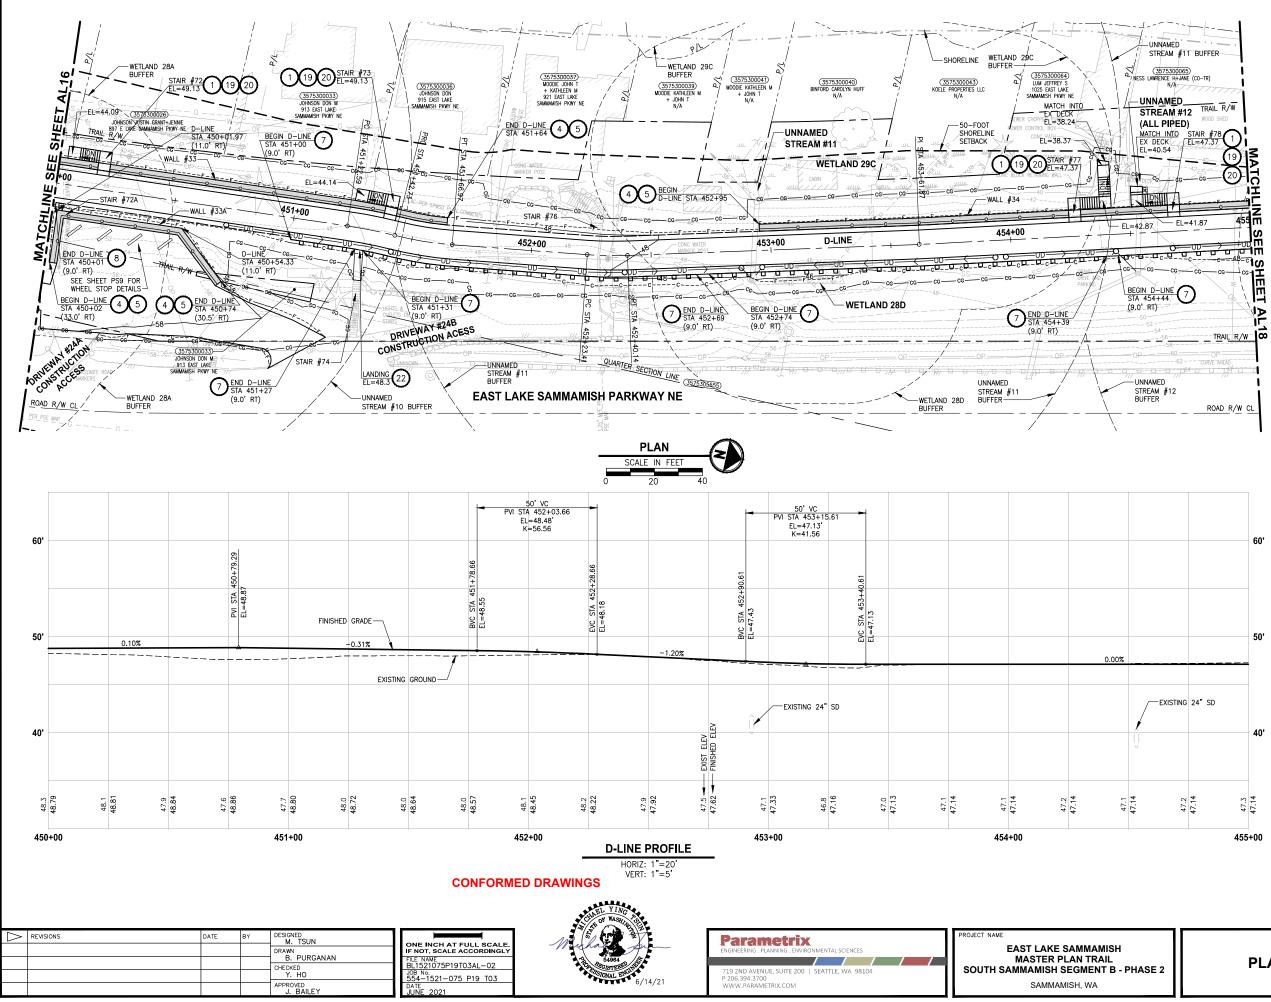


\bigcirc	INSTALL STAIR. CIP CONCRETE STAIR TYPE. SEE S SHEETS FOR DETAILS.
$\overline{2}$	NOT USED.
$(\tilde{3})$	NOT USED.
$(\bar{4})$	INSTALL STRUCTURAL EARTH WALL. SEE WALL DETAILS ON SHEET WD1. SEE WALL PROFILES ON WP SHEETS.
5	INSTALL 4-FOOT COATED CHAIN LINK FENCE. SEE DETAILS ON SHEET MDB. SEE SHEET WD1 FOR MOUNTING ON TOP OF WALL.
6	NEW DRIVEWAY.
\overline{O}	INSTALL WOOD GUARDRAIL, SEE DETAILS ON SHEET MD2.
(ð)	INSTALL 2-RAIL FENCE, SEE DETAILS ON SHEET MD3.
ŏ	INSTALL CONCRETE PAD. SEE DETAIL 2 ON SHEET MD1.
$\overleftarrow{10}$	INSTALL ROCK WALL. SEE DETAILS ON SHEET MD1 AND DP SHEETS.
$\widetilde{\mathbb{M}}$	NOT USED.
$\widetilde{12}$	INSTALL TYPE 1 REST STOP. SEE DETAILS ON
(13)	SHEET MD1. NOT USED.
×	INSTALL PEDESTRIAN RAILING PER COS FIG 03-15
(14)	ON CONCRETE COPING. SEE APPENDIX B IN THE SPECIFICATIONS.
(15)	INSTALL GRAVITY BLOCK WALL. SEE WALL DETAILS ON SHEET WD1. SEE WALL PROFILES ON WP SHEETS.
(16)	NOT USED.
(17)	INSTALL EXTRUDED CURB PER WSDOT STD PLAN F-10.42-00. SEE APPENDIX B IN THE
$\widetilde{(18)}$	SPECIFICATIONS. NOT USED.
$\widetilde{\mathbb{O}}$	LEAVE 5' GAP IN FENCING FOR STAIR ACCESS.
\bigotimes_{20}	INSTALL METAL HANDRAIL PER KCRS FIG. 5-007. SEE S SHEETS FOR LIMITS AND DETAILS OF HANDRAIL. SEE
Ξ	APPENDIX B IN SPECIFICATIONS. INSTALL SLOPE PROTECTION. OMIT 0.5' SLOPE
	ROUNDING. SEE DETAIL 4 ON SHEET MD4.
	RESTORE CONCRETE STAIR LANDING PAD, SEE DETAIL 5 ON SHEET MD4.
(23)	INSTALL SLOPE PROTECTION, SEE DETAIL 4 ON SHEET MD4.
(24)	NOT USED.
(25)	NOT USED.
(26)	INSTALL REDIROCK WALL PER DETAIL 4 ON SHEET WD1.
27	NOT USED.
LEG	END:
	RETAINING WALL
	LANDING PAD
	SLOPE PROTECTION
GEN	IERAL NOTES:
1. SE	E UT SHEETS FOR UTILITY AND DRAINAGE PROVEMENTS.
	E DP SHEETS FOR DRIVEWAY DETAILS AND GRADING.
	ISTING FEATURES/TREES CALLED OUT TO BE REMOVED I SP SHEETS ARE NOT SHOWN ON AL SHEETS FOR
CL	I SP SHEETS ARE NOT SHOWN ON AL SHEETS FOR ARITY PURPOSES. IE LA SHEETS FOR RESTORATION ALONG TRAIL SIDE
OF	R ALONG BOTTOM OF WALLS.
	E LA SHEETS FOR CUT WALL BACK SLOPE STORATION TREATMENT.
	CITY OF SAMMAMISH PUBLIC WORKS DEVELOPMENT REVIEW
	se drawings have been reviewed for compliance
Stor	City of Sammamish Clearing and Grading and mwater requirements and also in accordance with
Agre	requirements as established in the Settlement_
Sam	nmamish No. C17-0921 JCC and King County vs. of Sammamish No. 17-2-29922-7 SEA and have
	n deemed ACCEPTABLE. The reviewer accepts no

CIVIL CONSTRUCTION NOTES:

the prepare of these drawings.

SHEET NO. 58 OF 213

PLAN AND PROFILE

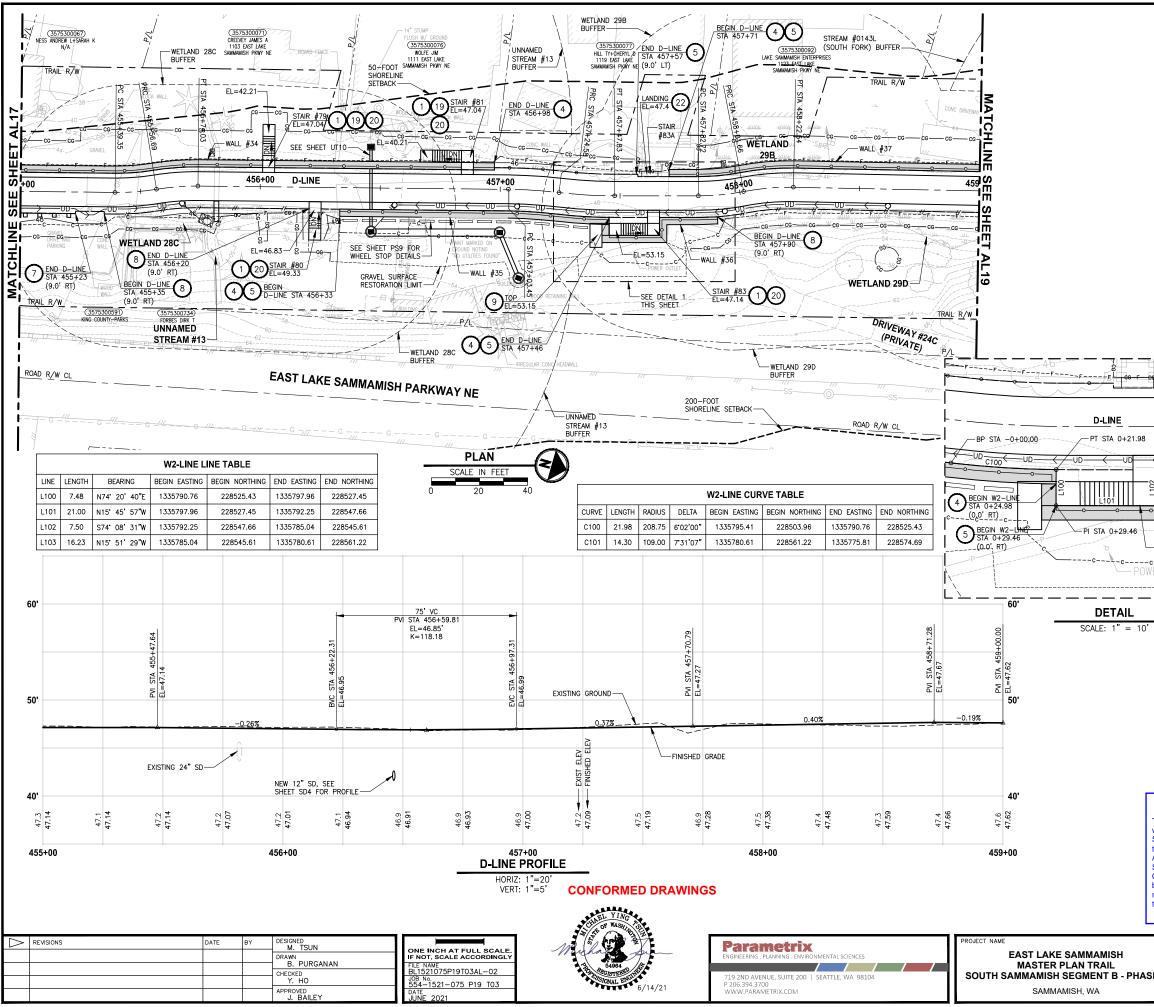

PLAN AN	ND PROFILE AL18
Sammamish No. C17-0921 JCC and King Co Dity of Sammamish No. 17-2-29922-7 SEA ar been deemed ACCEPTABLE. The reviewer a esponsibility for any errors and/or omissions i he preparer of these drawings. 17 February 2022	nd have accepts no City Engineer
CITY OF SAMMAMISH PUBLIC WOR DEVELOPMENT REVIEW These drawings have been reviewed for comp with City of Sammamish Clearing and Grading Stormwater requirements and also in accorda he requirements as established in the Settlen Agreement between King County vs. City of	pliance ig and ance with
	5. SEE LA SHEETS FOR CUT WALL BACK SLOPE RESTORATION TREATMENT.
	4. SEE LA SHEETS FOR RESTORATION ALONG TRAIL SIDE OR ALONG BOTTOM OF WALLS.
	 EXISTING FEATURES/TREES CALLED OUT TO BE REMOVED ON SP SHEETS ARE NOT SHOWN ON AL SHEETS FOR CLARITY PURPOSES.
	IMPROVEMENTS. 2. SEE DP SHEETS FOR DRIVEWAY DETAILS AND GRADING.
	GENERAL NOTES: 1. SEE UT SHEETS FOR UTILITY AND DRAINAGE INDODUCTION
	WOOD GUARDRAIL
	RETAINING WALL
ER OUTLET	LEGEND:
W2-LINE (0.0' T)	 (26) INSTALL REDIROCK WALL PER DETAIL 4 ON SHEET WD1. (27) NOT USED.
	25 NOT USED.
4 5 END W2-LANE SEA-0+82.04	24 NOT USED.
PI STA 0+50.46	104. 23 INSTALL SLOPE PROTECTION, SEE DETAIL 4 ON SHEET MD4.
	21 ROUNDING. SEE DETAIL 4 ON SHEET MD4. 22 RESTORE CONCRETE STAIR LANDING PAD, SEE DETAIL 5 ON SHEET MD4.
PC STA 0+74.18 PI STA 0+57.95	(20) S SHEETS FOR LIMITS AND DETAILS OF HANDRAIL. SEE APPENDIX B IN SPECIFICATIONS. (21) INSTALL SLOPE PROTECTION. OMIT 0.5' SLOPE
EP STA 0+88.49	19 LEAVE 5' GAP IN FENCING FOR STAIR ACCESS. INSTALL METAL HANDRAIL PER KCRS FIG. 5-007. SEE
00	18 NOT USED.
	17 INSTALL EXTRUDED CURB PER WSDOT STD PLAN F-10.42-00. SEE APPENDIX B IN THE SPECIFICATIONS.
	16 NOT USED.
	SPECIFICATIONS.
	13 INSTALL PEDESTRIAN RAILING PER COS FIG 03–15 14 ON CONCRETE COPING. SEE APPENDIX B IN THE
	(12) SHEET MD1. (13) NOT USED.
	11 NOT USED.
	10 install rock wall. See details on sheet md1 and dp sheets.
	(9) INSTALL CONCRETE PAD. SEE DETAIL 2 ON SHEET MD1.
	7 INSTALL WOOD GUARDRAIL, SEE DETAILS ON 8 INSTALL 2-RAIL FENCE, SEE DETAILS ON SHEET MD3.
	6 New DRIVEWAY. 7 INSTALL WOOD GUARDRAIL, SEE DETAILS ON

CIVIL CONSTRUCTION NOTES:

2 NOT USED.


3 NOT USED.

 \sim

(1) INSTALL STAIR. CIP CONCRETE STAIR TYPE. SEE S SHEETS FOR DETAILS.

 $\widecheck{(4)}$ install structural earth wall. See wall details on sheet wd1. See wall profiles on wp sheets.

5 INSTALL 4-FOOT COATED CHAIN LINK FENCE. SEE DETAILS ON SHEET MD8. SEE SHEET WD1 FOR MOUNTING ON TOP OF WALL.

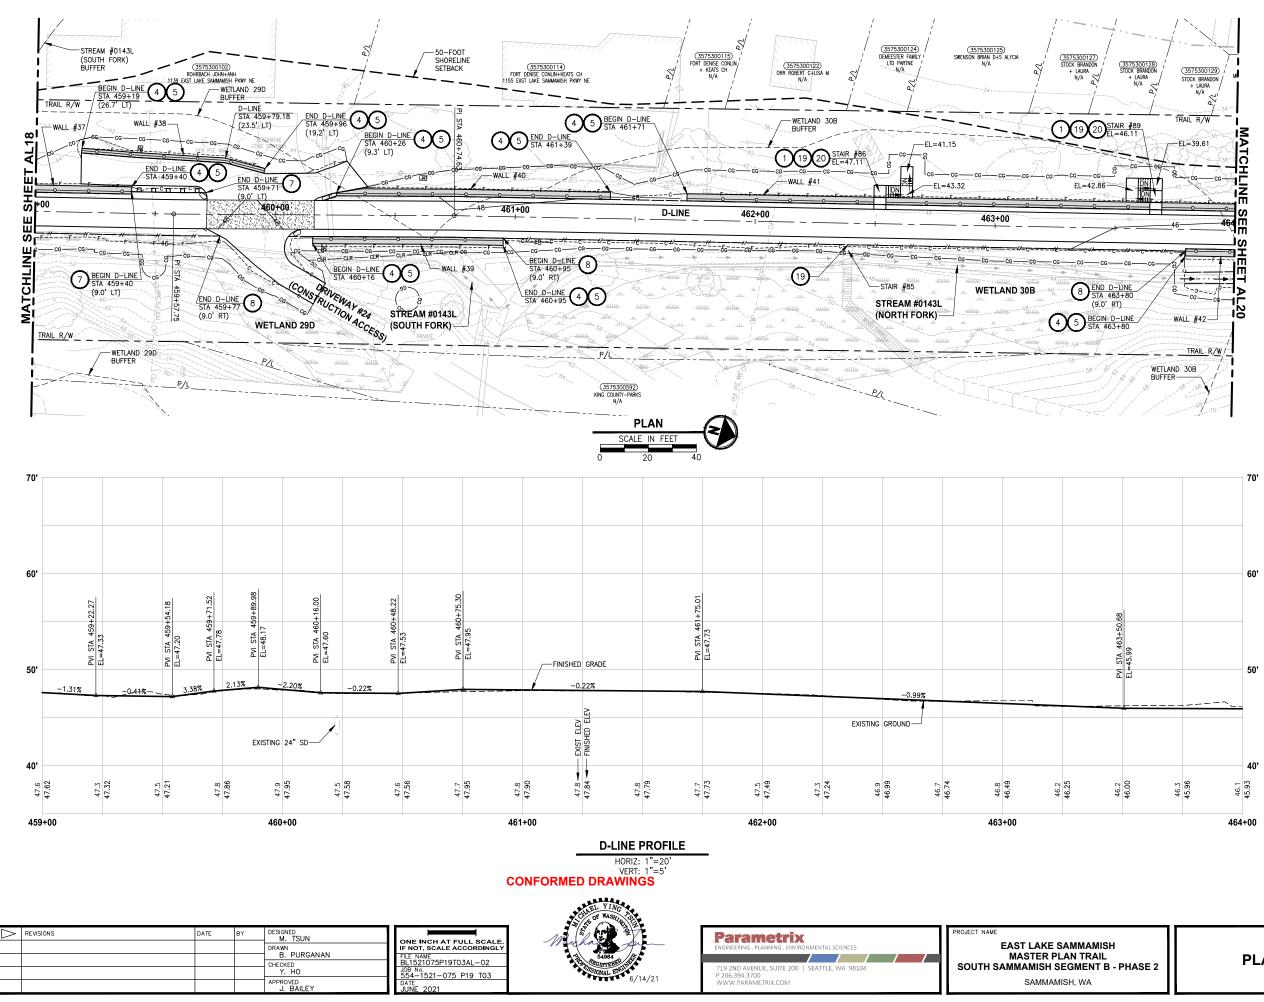


CIVIL CONSTRUCTION NOTES:					
$\overline{\mathbb{A}}$	INSTALL STAIR. CIP CONCRETE STAIR TYPE, SEE S				
$\overleftarrow{2}$	SHEETS FOR DETAILS. NOT USED.				
\times					
$(\underline{3})$	NOT USED.				
(4)	INSTALL STRUCTURAL EARTH WALL. SEE WALL DETAILS ON SHEET WD1. SEE WALL PROFILES ON WP SHEETS.				
5	INSTALL 4-FOOT COATED CHAIN LINK FENCE. SEE DETAILS ON SHEET MD8. SEE SHEET WD1 FOR MOUNTING ON TOP OF WALL.				
6	NEW DRIVEWAY.				
Õ	INSTALL WOOD GUARDRAIL, SEE DETAILS ON SHEET MD2.				
8	INSTALL 2-RAIL FENCE, SEE DETAILS ON SHEET MD3.				
9	INSTALL CONCRETE PAD. SEE DETAIL 2 ON SHEET MD1.				
	INSTALL ROCK WALL. SEE DETAILS ON SHEET MD1 AND DP SHEETS.				
	NOT USED.				
(12)	INSTALL TYPE 1 REST STOP. SEE DETAILS ON SHEET MD1.				
(13)	NOT USED.				
14	INSTALL PEDESTRIAN RAILING PER COS FIG 03-15 ON CONCRETE COPING. SEE APPENDIX B IN THE SPECIFICATIONS.				
(15)	INSTALL GRAVITY BLOCK WALL. SEE WALL DETAILS ON SHEET WD1. SEE WALL PROFILES ON WP SHEETS.				
(16)	NOT USED.				
Ū)	INSTALL EXTRUDED CURB PER WSDOT STD PLAN F-10.42-00. SEE APPENDIX B IN THE SPECIFICATIONS.				
(18)	NOT USED.				
(19)	LEAVE 5' GAP IN FENCING FOR STAIR ACCESS.				
(20)	INSTALL METAL HANDRAIL PER KCRS FIG. 5–007. SEE S SHEETS FOR LIMITS AND DETAILS OF HANDRAIL, SEE APPENDIX B IN SPECIFICATIONS.				
$\widetilde{(21)}$	INSTALL SLOPE PROTECTION. OMIT 0.5' SLOPE ROUNDING. SEE DETAIL 4 ON SHEET MD4.				
(22)	RESTORE CONCRETE STAIR LANDING PAD, SEE DETAIL 5 ON SHEET MD4.				
$\widecheck{23}$	INSTALL SLOPE PROTECTION, SEE DETAIL 4 ON SHEET MD4.				
$\overline{(24)}$	NOT USED.				
25	NOT USED.				
$\overline{(26)}$	INSTALL REDIROCK WALL PER DETAIL 4 ON SHEET WD1.				
2 7	NOT USED.				
LEGEND:					
	RETAINING WALL				
	WOOD GUARDRAIL				
Ľ	LANDING PAD				
	SLOPE PROTECTION				
GEN	IERAL NOTES:				
	I. SEE UT SHEETS FOR UTILITY AND DRAINAGE IMPROVEMENTS.				
2. SE	2. SEE DP SHEETS FOR DRIVEWAY DETAILS AND GRADING.				
3. EX	3. EXISTING FEATURES/TREES CALLED OUT TO BE REMOVED				

- ON SP SHEETS ARE NOT SHOWN ON AL SHEETS FOR CLARITY PURPOSES.
- 4. SEE LA SHEETS FOR RESTORATION ALONG TRAIL SIDE OR ALONG BOTTOM OF WALLS.
- 5. SEE LA SHEETS FOR CUT WALL BACK SLOPE RESTORATION TREATMENT.

CITY OF SAMMAMISH PUBLIC WORKS DEVELOPMENT REVIEW rings have been reviewed for con These dra ance with City of Sammamish Clearing and Grading and Stormwater requirements and also in accordance with Stormwater requirements and also in accordance with the requirements as established in the Settlement. Agreement between King County vs. City of Sammarnish No. C17-0921 JCC and King County vs. City of Sammarnish No. 17-2-2922-7 SEA and have been deemed ACCEPTABLE. The reviewer accepts n responsibility for any errors and/or omissions made by the preparer of these drawings.

SHEET NO. 60 OF 213

PLAN AND PROFILE

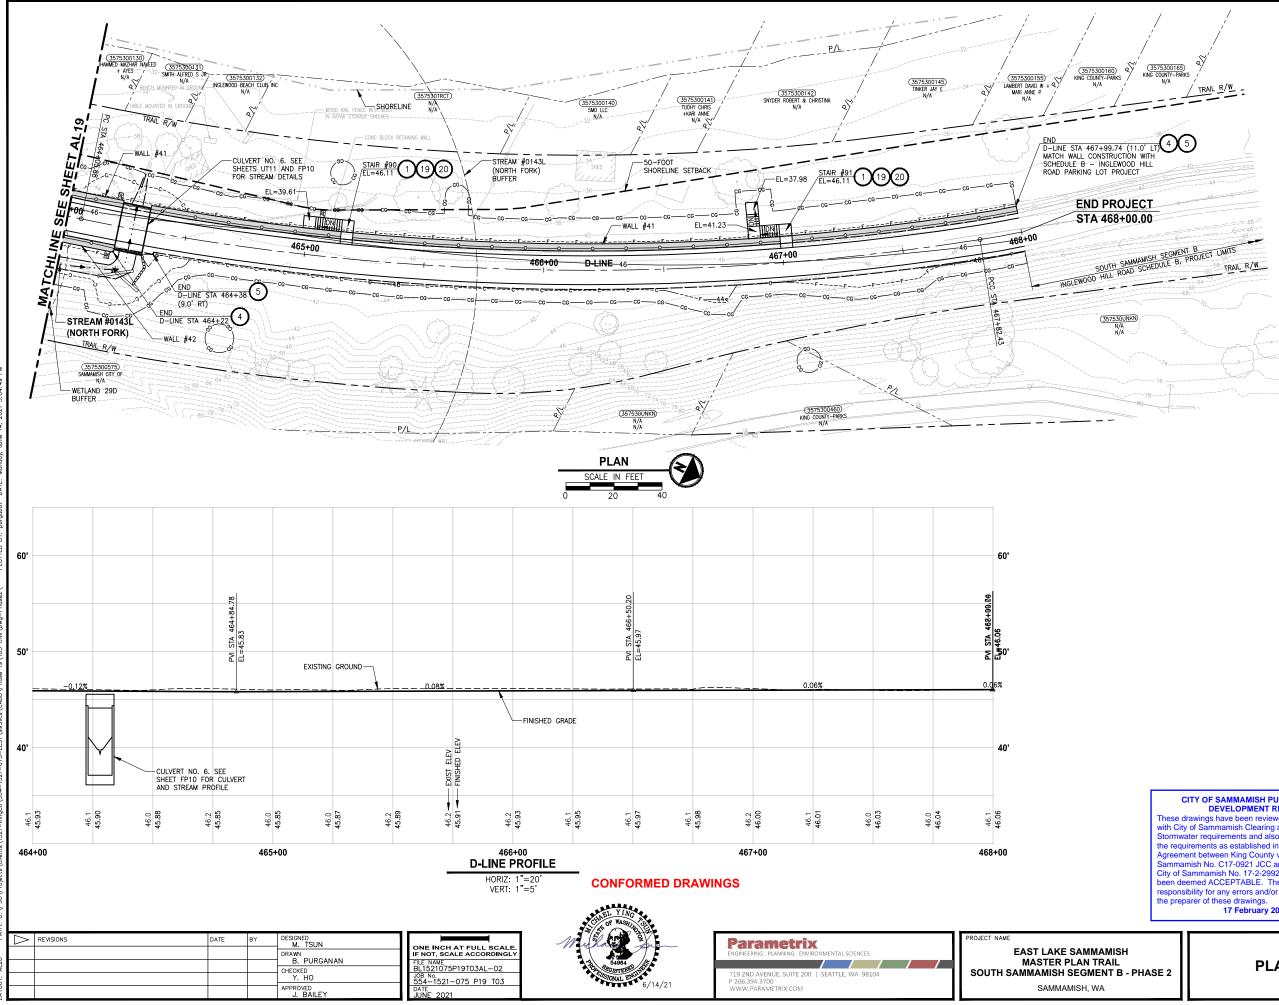


	L CONSTRUCTION NOTES:
	INSTALL STAIR. CIP CONCRETE STAIR TYPE. SEE S SHEETS FOR DETAILS.
2	NOT USED.
3	NOT USED.
$\tilde{4}$	INSTALL STRUCTURAL EARTH WALL. SEE WALL DETAILS ON SHEET WD1. SEE WALL PROFILES ON WP SHEETS.
5	INSTALL 4-FOOT COATED CHAIN LINK FENCE. SEE DETAILS ON SHEET MD8. SEE SHEET WD1 FOR MOUNTING ON TOP OF WALL.
6)	NEW DRIVEWAY.
$\overline{\mathcal{O}}$	INSTALL WOOD GUARDRAIL, SEE DETAILS ON SHEET MD2.
8	INSTALL 2-RAIL FENCE, SEE DETAILS ON SHEET MD3.
9	INSTALL CONCRETE PAD. SEE DETAIL 2 ON SHEET MD1
	INSTALL ROCK WALL. SEE DETAILS ON SHEET MD1 AND DP SHEETS.
1)	NOT USED.
	INSTALL TYPE 1 REST STOP. SEE DETAILS ON SHEET MD1.
13)	NOT USED.
4	INSTALL PEDESTRIAN RAILING PER COS FIG 03-15 ON CONCRETE COPING. SEE APPENDIX B IN THE SPECIFICATIONS.
15	INSTALL GRAVITY BLOCK WALL. SEE WALL DETAILS ON SHEET WD1. SEE WALL PROFILES ON WP SHEETS.
16)	NOT USED.
0	INSTALL EXTRUDED CURB PER WSDOT STD PLAN F-10.42-00. SEE APPENDIX B IN THE SPECIFICATIONS.
18)	NOT USED.
19)	LEAVE 5' GAP IN FENCING FOR STAIR ACCESS.
20	INSTALL METAL HANDRAIL PER KCRS FIG. 5–007. SEE S SHEETS FOR LIMITS AND DETAILS OF HANDRAIL. SEE APPENDIX B IN SPECIFICATIONS.
21)	INSTALL SLOPE PROTECTION. OMIT 0.5' SLOPE ROUNDING. SEE DETAIL 4 ON SHEET MD4.
22)	RESTORE CONCRETE STAIR LANDING PAD, SEE DETAIL 5 ON SHEET MD4.
23	INSTALL SLOPE PROTECTION, SEE DETAIL 4 ON SHEET MD4.
24)	NOT USED.
25	NOT USED.
26	INSTALL REDIROCK WALL PER DETAIL 4 ON SHEET WD1
27)	NOT USED.
EG	END:
	RETAINING WALL
-	WOOD GUARDRAIL
	LANDING PAD
	SLOPE PROTECTION
12	SLOPE PROTECTION

GENERAL NOTES:

- 1. SEE UT SHEETS FOR UTILITY AND DRAINAGE IMPROVEMENTS.
- 2. SEE DP SHEETS FOR DRIVEWAY DETAILS AND GRADING.
- EXISTING FEATURES/TREES CALLED OUT TO BE REMOVED ON SP SHEETS ARE NOT SHOWN ON AL SHEETS FOR CLARITY PURPOSES.
- 4. SEE LA SHEETS FOR RESTORATION ALONG TRAIL SIDE OR ALONG BOTTOM OF WALLS.


SE 2 PLAN AND PRO		DFILE	
			SHEET NO. 61 OF 213
These with Ci Stormy the req Agreer Samma City of been d respon	CITY OF SAMMAMISH PUBLIC WORKS DEVELOPMENT REVIEW drawings have been reviewed for compliance ty of Sammamish Clearing and Grading and vater requirements and also in accordance with juirements as established in the Settlement nent between King County vs. City of amish No. C17-0921 JCC and King County vs. Sammamish No. 17-2-29922-7 SEA and have leemed ACCEPTABLE. The reviewer accepts no sibility for any errors and/or omissions made by sparer of these drawings. 17 February 2022	CITY OF SAMMAMISH City Engineer Community Development	Date
		A SHEETS FOR CUT WALL BACK RATION TREATMENT.	SLOPE

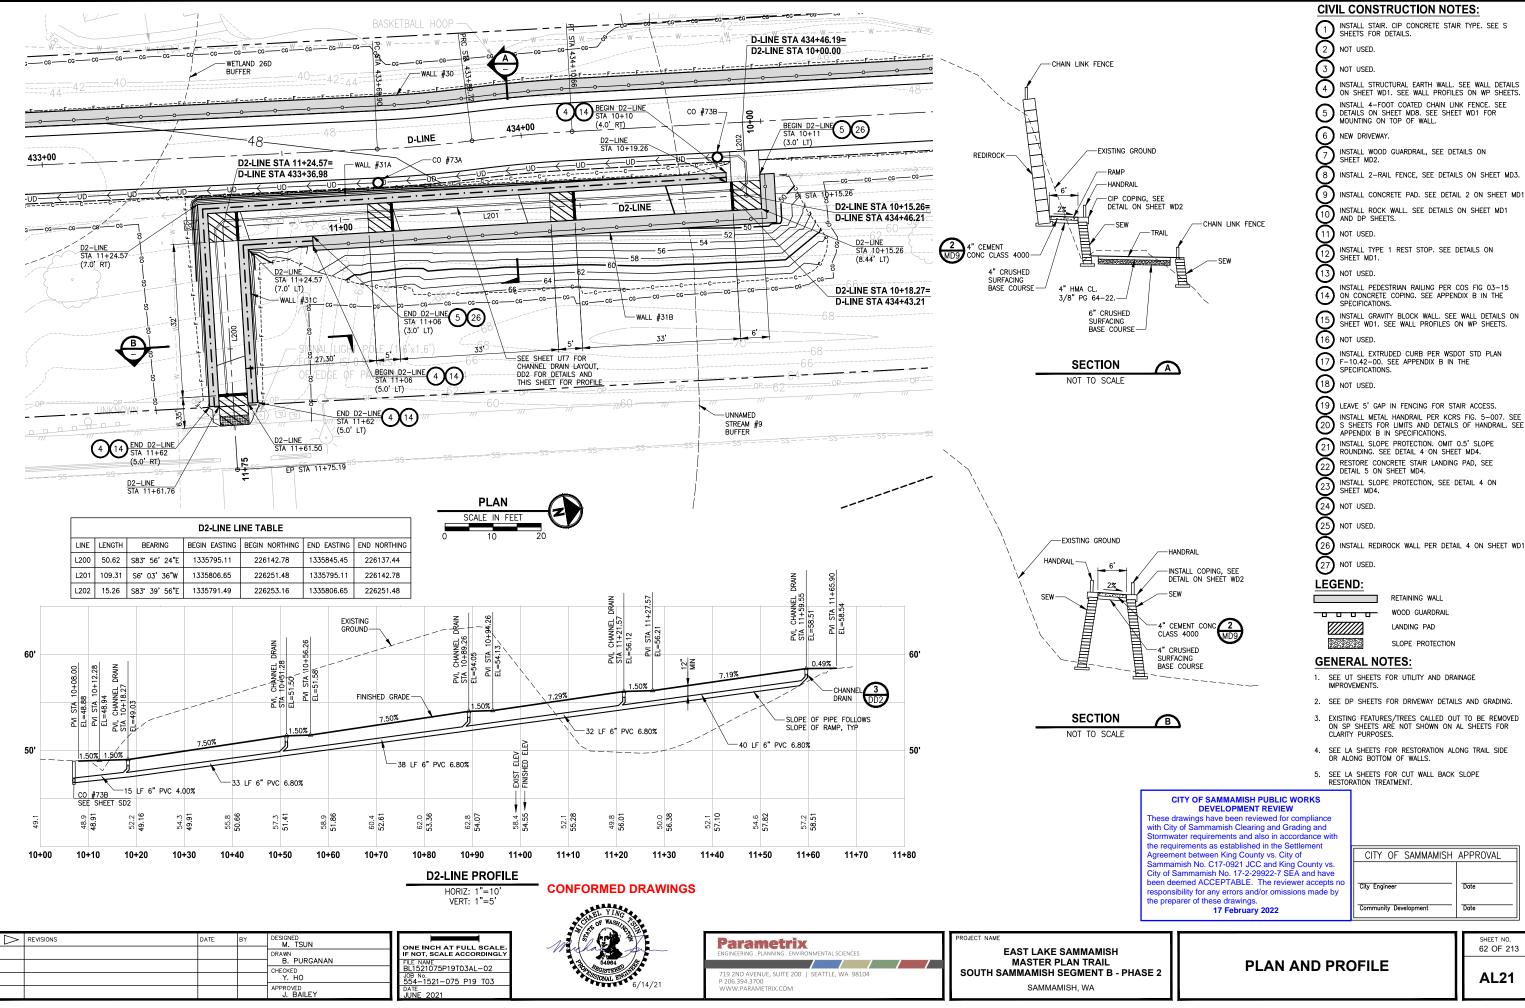


CIVIL CONSTRUCTION NOTES:

- 2. SEE DP SHEETS FOR DRIVEWAY DETAILS AND GRADING.
- 3. EXISTING FEATURES/TREES CALLED OUT TO BE REMOVED ON SP SHEETS ARE NOT SHOWN ON AL SHEETS FOR
- 4. SEE LA SHEETS FOR RESTORATION ALONG TRAIL SIDE OR ALONG BOTTOM OF WALLS.


SHEET 62 OF 213

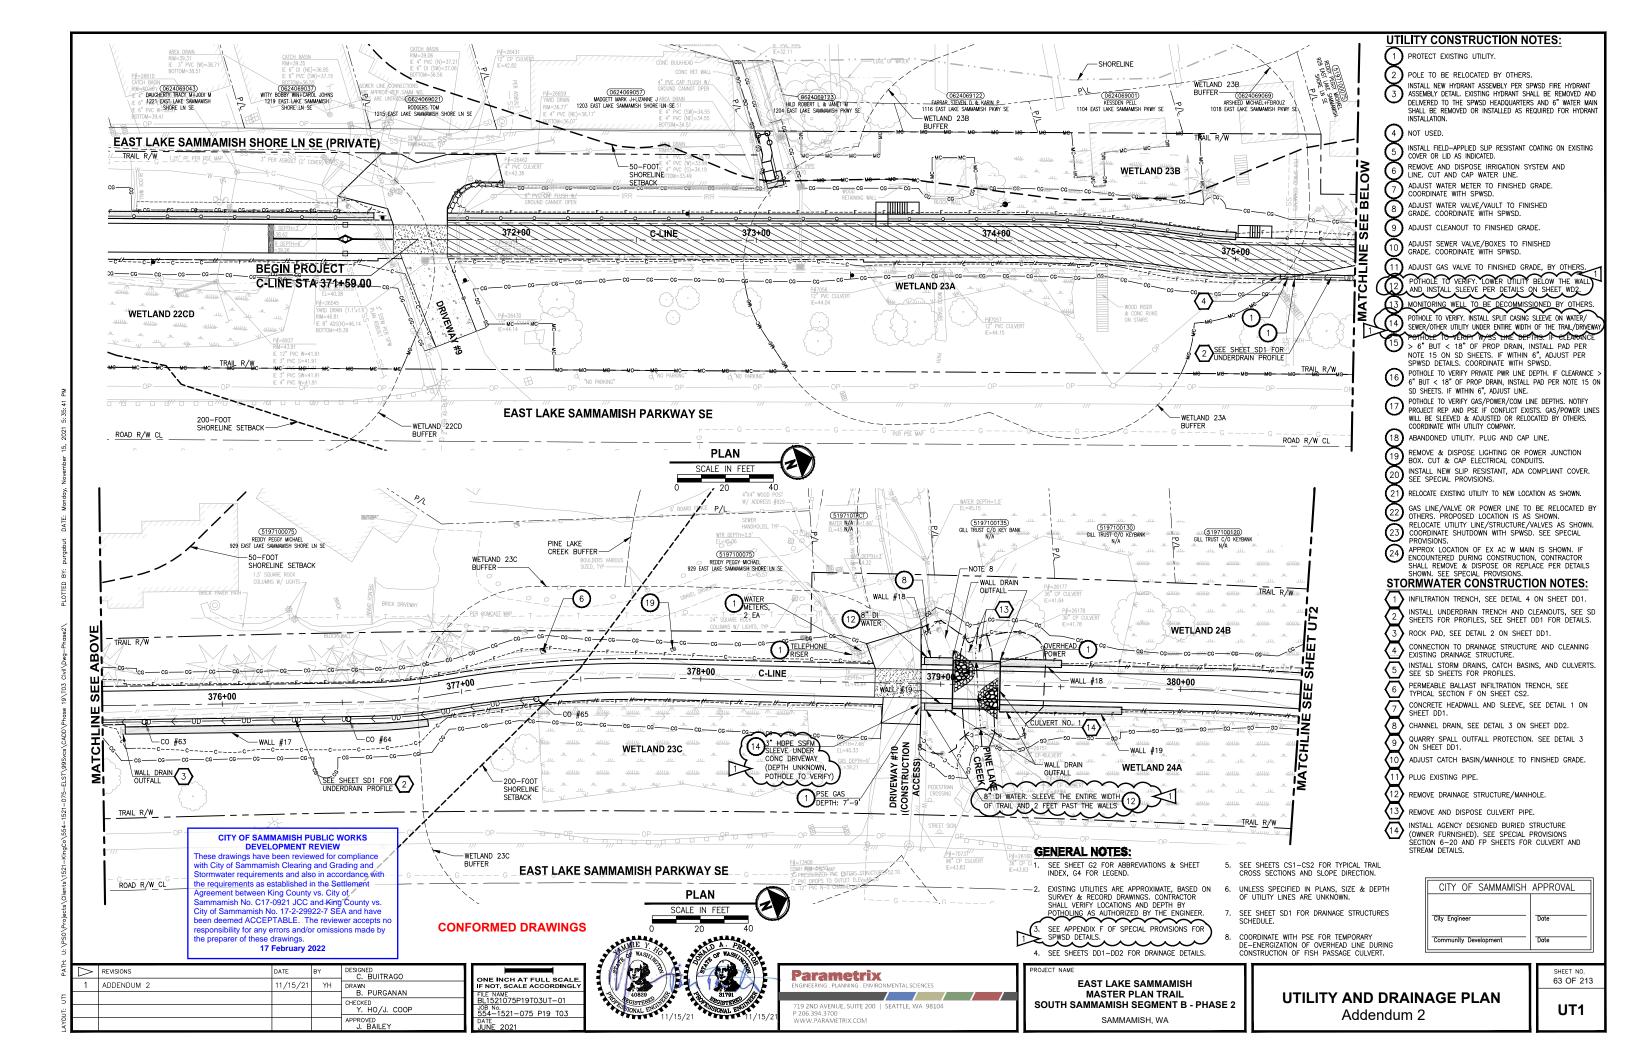


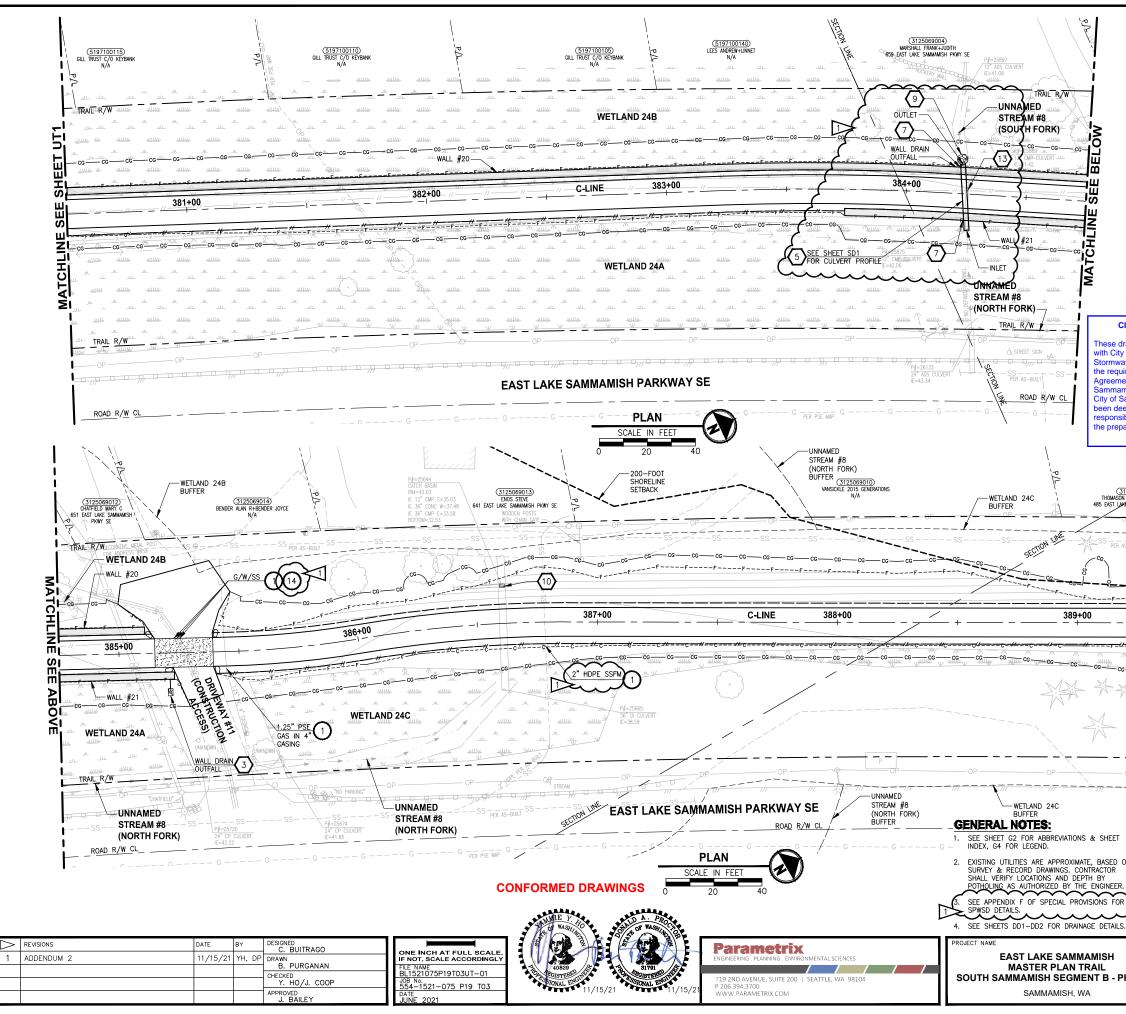


	핏	LITY CONSTRUCTION NOTES:
		PROTECT EXISTING UTILITY.
	$\begin{pmatrix} 2\\ 3 \end{pmatrix}$	POLE TO BE RELOCATED BY OTHERS. INSTALL NEW HYDRANT ASSEMBLY PER SPWSD FIRE HYDRANT ASSEMBLY DETAIL EXISTING HYDRANT SHALL BE REMOVED AND DELIVERED TO THE SPWSD HEADQUARTERS AND 6" WATER MAIN
	(4)	SHALL BE REMOVED OR INSTALLED AS REQUIRED FOR HYDRANT INSTALLATION. NOT USED.
	6	INSTALL FIELD-APPLIED SLIP RESISTANT COATING ON EXISTING COVER OR LID AS INDICATED.
	6	REMOVE AND DISPOSE IRRIGATION SYSTEM AND
	- Ж	LINE. CUT AND CAP WATER LINE. ADJUST WATER METER TO FINISHED GRADE.
	ä	COORDINATE WITH SPWSD. ADJUST WATER VALVE/VAULT TO FINISHED
	ð	GRADE. COORDINATE WITH SPWSD. ADJUST CLEANOUT TO FINISHED GRADE.
) M	ADJUST SEWER VALVE/BOXES TO FINISHED
	Ö	GRADE. COORDINATE WITH SPWSD. ADJUST GAS VALVE TO FINISHED GRADE, BY OTHERS.
		POTHOLE TO VERIFY LOWER UTILITY BELOW THE WALL
		AND INSTALL SLEEVE PER DETAILS ON SHEET WD2. MONITORING WELL TO BE DECOMMISSIONED BY OTHERS.
_		POTHOLE TO VERIFY. INSTALL SPLIT CASING SLEEVE ON WATER/
		SEWER/OTHER UTILITY UNDER ENTIRE WIDTH OF THE TRAIL/DRIVEWAY POTHOLE TO VERIFY W/SS LINE DEPTHS. IF CLEARANCE
CITY OF SAMMAMISH PUBLIC WORKS DEVELOPMENT REVIEW	\square	> 6" BUT < 18" OF PROP DRAIN, INSTALL PAD PER NOTE 15 ON SD SHEETS. IF WITHIN 6", ADJUST PER
drawings have been reviewed for compliance ity of Sammamish Clearing and Grading and water requirements and also in accordance with	16	SPWSD DETAILS. COORDINATE WITH SPWSD. POTHOLE TO VERIFY PRIVATE PWR LINE DEPTH. IF CLEARANCE > 6° BUT < 18" OF PROP DRAIN, INSTALL PAD PER NOTE 15 ON SD SHEETS. IF WITHIN 6", ADJUST LINE.
quirements as established in the Settlement ment between King County vs. City of		POTHOLE TO VERIFY GAS/POWER/COM LINE DEPTHS. NOTIFY PROJECT REP AND PSE IF CONFLICT EXISTS. GAS/POWER LINES
amish No. C17-0921 JCC and King County vs. f Sammamish No. 17-2-29922-7 SEA and have		WILL BE SLEEVED & ADJUSTED OR RELOCATED BY OTHERS. COORDINATE WITH UTILITY COMPANY.
deemed ACCEPTABLE. The reviewer accepts no nsibility for any errors and/or omissions made by		ABANDONED UTILITY. PLUG AND CAP LINE.
eparer of these drawings. 17 February 2022		REMOVE & DISPOSE LIGHTING OR POWER JUNCTION BOX. CUT & CAP ELECTRICAL CONDUITS.
TT	- 20	INSTALL NEW SLIP RESISTANT, ADA COMPLIANT COVER. SEE SPECIAL PROVISIONS.
		RELOCATE EXISTING UTILITY TO NEW LOCATION AS SHOWN. GAS LINE/VALVE OR POWER LINE TO BE RELOCATED BY
(3125069002) SON JOHN B-TAMARA L/ LAKE SAMMAMISH PKWY SE	(22)	OTHERS. PROPOSED LOCATION IS AS SHOWN. RELOCATE UTILITY LINE/STRUCTURE/VALVES AS SHOWN. COORDINATE SHUTDOWN WITH SPWSD. SEE SPECIAL
TRAIL R/W	23	PROVISIONS. APPROX LOCATION OF EX AC W MAIN IS SHOWN, IF
	U	ENCOUNTERED DURING CONSTRUCTION, CONTRACTOR SHALL REMOVE & DISPOSE OR REPLACE PER DETAILS SHOWN. SEE SPECIAL PROVISIONS.
	STC	DRMWATER CONSTRUCTION NOTES:
		INFILTRATION TRENCH, SEE DETAIL 4 ON SHEET DD1. INSTALL UNDERDRAIN TRENCH AND CLEANOUTS, SEE SD
		SHEETS FOR PROFILES, SEE SHEET DD1 FOR DETAILS.
i <u>u</u> iu	$\begin{pmatrix} 3 \\ 4 \end{pmatrix}$	ROCK PAD, SEE DETAIL 2 ON SHEET DD1. CONNECTION TO DRAINAGE STRUCTURE AND CLEANING
<mark></mark>	5	EXISTING DRAINAGE STRUCTURE. INSTALL STORM DRAINS, CATCH BASINS, AND CULVERTS.
	الم	SEE SD SHEETS FOR PROFILES. PERMEABLE BALLAST INFILTRATION TRENCH, SEE
	X	TYPICAL SECTION F ON SHEET CS2. CONCRETE HEADWALL AND SLEEVE, SEE DETAIL 1 ON
	_X	SHEET DD1. CHANNEL DRAIN, SEE DETAIL 3 ON SHEET DD2.
MA	K	QUARRY SPALL OUTFALL PROTECTION. SEE DETAIL 3 ON SHEET DD1.
i i i i i i i i i i i i i i i i i i i		ADJUST CATCH BASIN/MANHOLE TO FINISHED GRADE.
TRAIL R/W		PLUG EXISTING PIPE.
OP		REMOVE DRAINAGE STRUCTURE/MANHOLE.
		REMOVE AND DISPOSE CULVERT PIPE.
	<u>\14</u>	INSTALL AGENCY DESIGNED BURIED STRUCTURE (OWNER FURNISHED). SEE SPECIAL PROVISIONS SECTION 6–20 AND FP SHEETS FOR CULVERT AND STREAM DETAILS.
T 5. SEE SHEETS CS1-CS2 FOR TYPICAL TR CROSS SECTIONS AND SLOPE DIRECTION		
O ON 6. UNLESS SPECIFIED IN PLANS, SIZE & D OF UTILITY LINES ARE UNKNOWN.		CITY OF SAMMAMISH APPROVAL
ER. 7. SEE SHEET SD1 FOR DRAINAGE STRUCT SCHEDULE.	URES	City Engineer Date
8. COORDINATE WITH PSE FOR TEMPORARY DE-ENERGIZATION OF OVERHEAD LINE D	URING	Community Development Date
ILS. CONSTRUCTION OF FISH PASSAGE CULVE	LKI.	SHEET NO.
	_	64 OF 213

Addendum 2

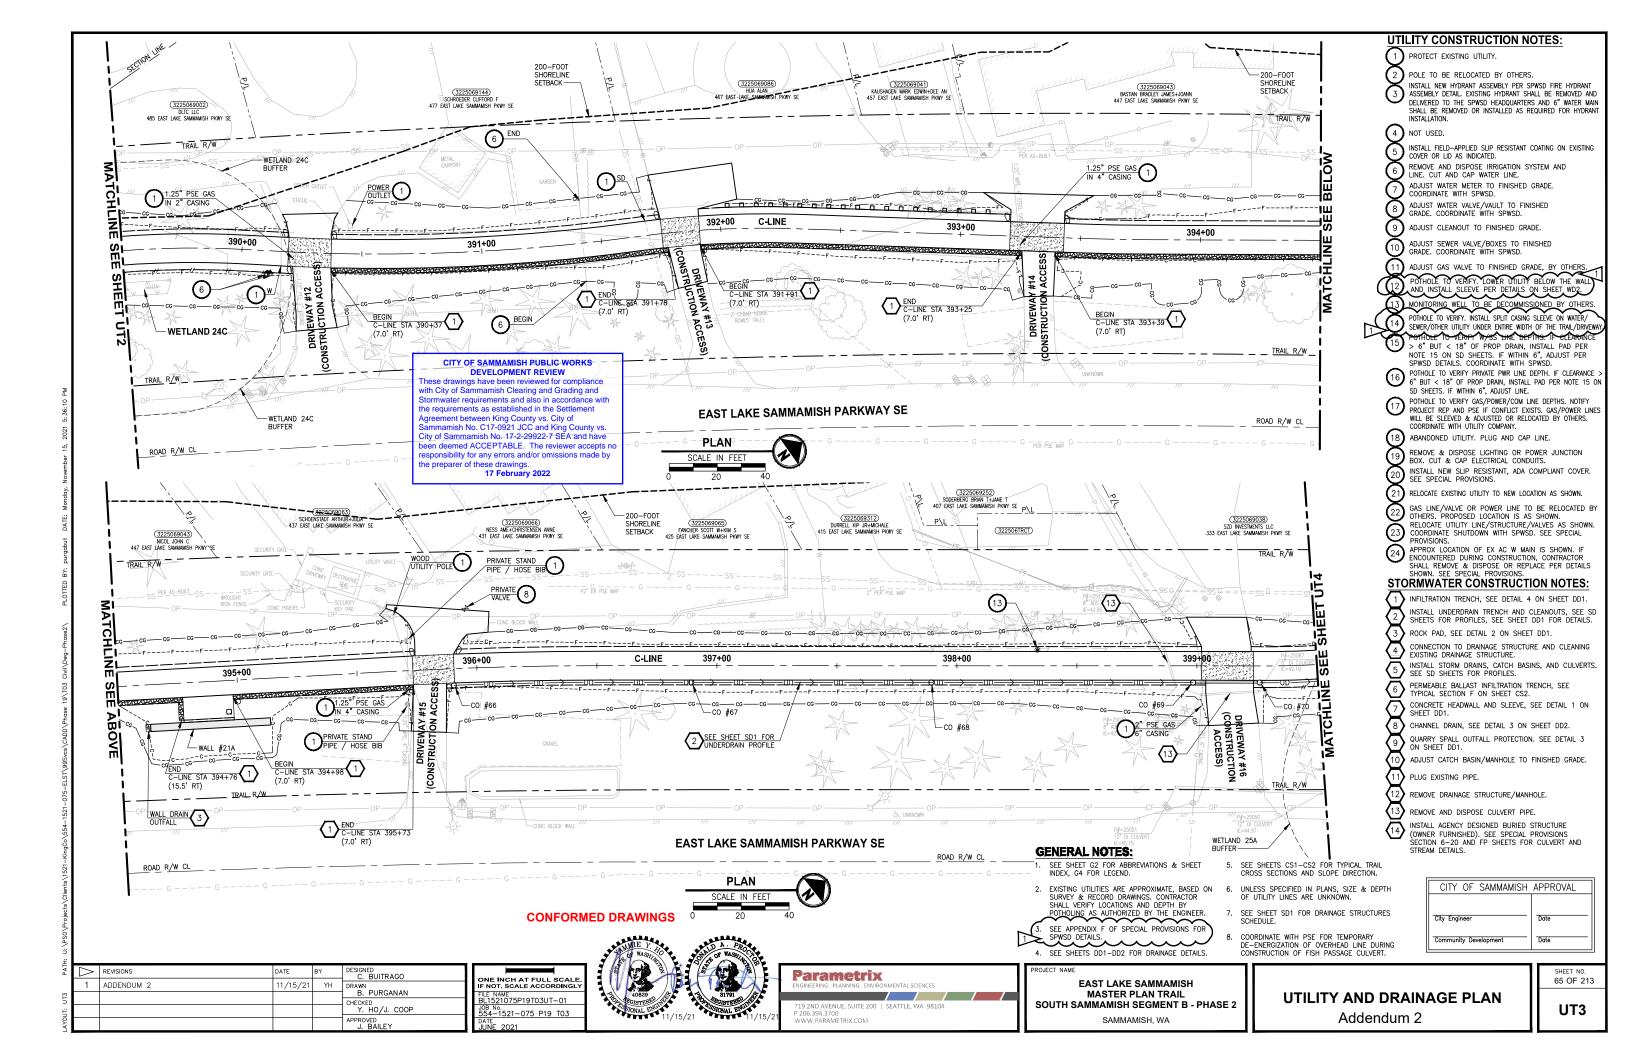


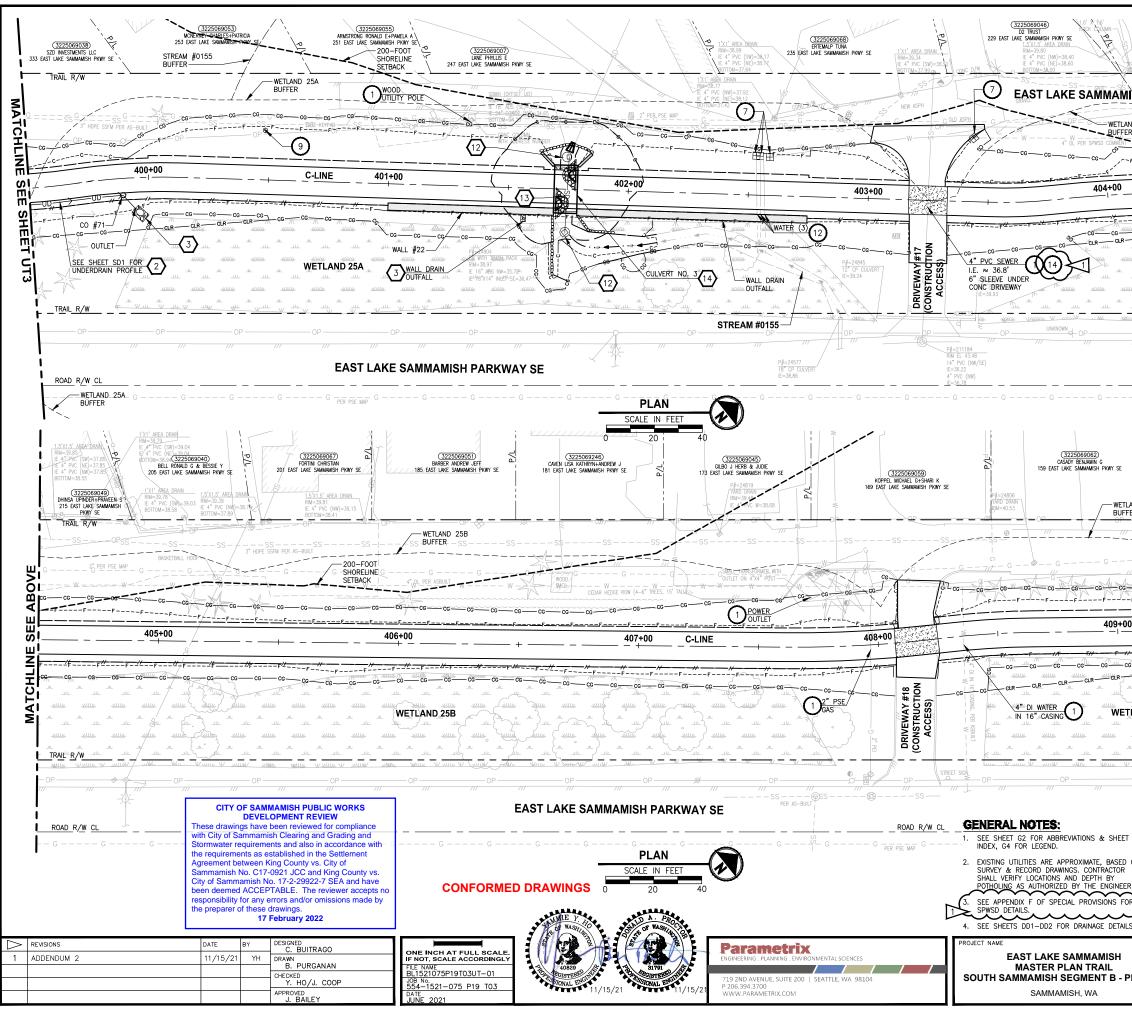


PHASE 2 UTILITY AND DRA Addendur	
	SHEET NO. 66 OF 213
8. COORDINATE WITH PSE FOR TEMPORARY DE-ENERGIZATION OF OVERHEAD LINE DURING CONSTRUCTION OF FISH PASSAGE CULVERT.	Community Development Date
ER. 7. SEE SHEET SD1 FOR DRAINAGE STRUCTURES SCHEDULE.	City Engineer Date
D ON 6. UNLESS SPECIFIED IN PLANS, SIZE & DEPTH OF UTILITY LINES ARE UNKNOWN.	CITY OF SAMMAMISH APPROVAL
5. SEE SHEETS CS1-CS2 FOR TYPICAL TRAIL CROSS SECTIONS AND SLOPE DIRECTION.	
	SECTION 6-20 AND FP SHEETS FOR CULVERT AND STREAM DETAILS.
	INSTALL AGENCY DESIGNED BURIED STRUCTURE (OWNER FURNISHED). SEE SPECIAL PROVISIONS
OP OP 13	REMOVE AND DISPOSE CULVERT PIPE.
¹ ² ² ⁴ ² ⁴ ² ⁴ ² ⁴ ¹ ² ¹ 11 ¹ / ₁₂ ² ¹ / ₁₂ ² ¹ / ₁₂ ² ¹ / ₁₂	PLUG EXISTING PIPE. REMOVE DRAINAGE STRUCTURE/MANHOLE.
	ADJUST CATCH BASIN/MANHOLE TO FINISHED GRADE.
	QUARRY SPALL OUTFALL PROTECTION. SEE DETAIL 3 ON SHEET DD1.
	SHEET DD1. CHANNEL DRAIN, SEE DETAIL 3 ON SHEET DD2.
	TYPICAL SECTION F ON SHEET CS2. CONCRETE HEADWALL AND SLEEVE, SEE DETAIL 1 ON
	SEE SD SHEETS FOR PROFILES. PERMEABLE BALLAST INFILTRATION TRENCH, SEE
<u>•• </u>	EXISTING DRAINAGE STRUCTURE AND CLEANING EXISTING DRAINAGE STRUCTURE. INSTALL STORM DRAINS, CATCH BASINS, AND CULVERTS.
<u></u> іо	ROCK PAD, SEE DETAIL 2 ON SHEET DD1.
	INSTALL UNDERDRAIN TRENCH AND CLEANOUTS, SEE SD SHEETS FOR PROFILES, SEE SHEET DD1 FOR DETAILS.
	DRMWATER CONSTRUCTION NOTES: INFILTRATION TRENCH, SEE DETAIL 4 ON SHEET DD1.
	SHALL REMOVE & DISPOSE OR REPLACE PER DETAILS SHOWN. SEE SPECIAL PROVISIONS.
FFER TRAIL R/W	PROVISIONS. APPROX LOCATION OF EX AC W MAIN IS SHOWN. IF ENCOUNTERED DURING CONSTRUCTION, CONTRACTOR
135 EAST LAKE SAMMAMISH PKWY SE	RELOCATE UTILITY LINE/STRUCTURE/VALVES AS SHOWN. COORDINATE SHUTDOWN WITH SPWSD. SEE SPECIAL
(3225069265) EBERHARDT SUSAN N H RICHARDT Y	GAS LINE/VALVE OR POWER LINE TO BE RELOCATED BY OTHERS. PROPOSED LOCATION IS AS SHOWN.
	SEE SPECIAL PROVISIONS. RELOCATE EXISTING UTILITY TO NEW LOCATION AS SHOWN.
	REMOVE & DISPOSE LIGHTING OR POWER JUNCTION BOX. CUT & CAP ELECTRICAL CONDUITS. INSTALL NEW SLIP RESISTANT, ADA COMPLIANT COVER.
	ABANDONED UTILITY. PLUG AND CAP LINE.
	PROJECT REP AND PSE IF CONFLICT EXISTS. GAS/POWER LINES WILL BE SLEEVED & ADJUSTED OR RELOCATED BY OTHERS. COORDINATE WITH UTILITY COMPANY.
ROAD R/W CL	SD SHEETS. IF WITHIN 6", ADJUST LINE. POTHOLE TO VERIFY GAS/POWER/COM LINE DEPTHS. NOTIFY PROJECT REP AND RSE IF CONFLICT FYISTS, CAS/POWER LINES.
11 11	Pothole to verify private pwr line depth. If clearance $>$ 6" but < 18" of prop drain, install pad per note 15 on
	5 6" BUT < 18" OF PROP DRAIN, INSTALL PAD PER NOTE 15 ON SD SHEETS. IF WITHIN 6", ADJUST PER SPWSD DETAILS. COORDINATE WITH SPWSD.
	SEWER/OTHER UTILITY UNDER ENTIRE WIDTH OF THE TRAIL/DRIVEWAY
WETLAND 25B	MONITORING WELL TO BE DECOMMISSIONED BY OTHERS. POTHOLE TO VERIFY. INSTALL SPLIT CASING SLEEVE ON WATER/
	POTHOLE TO VERIFY. LOWER UTILITY BELOW THE WALL AND INSTALL SLEEVE PER DETAILS ON SHEET WD2.
	ADJUST GAS VALVE TO FINISHED GRADE, BY OTHERS.
	ADJUST SEWER VALVE/BOXES TO FINISHED GRADE. COORDINATE WITH SPWSD.
	ADJUST CLEANOUT TO FINISHED GRADE.
	COORDINATE WITH SPWSD. ADJUST WATER VALVE/VAULT TO FINISHED GRADE. COORDINATE WITH SPWSD.
	ADJUST WATER METER TO FINISHED GRADE.
AND 258	COVER OR LID AS INDICATED. REMOVE AND DISPOSE IRRIGATION SYSTEM AND
	NOT USED.
	SHALL BE REMOVED OR INSTALLED AS REQUIRED FOR HYDRANT INSTALLATION.
TRAIL R/W	INSTALL NEW HYDRANT ASSEMBLY PER SPWSD FIRE HYDRANT ASSEMBLY DETAIL. EXISTING HYDRANT SHALL BE REMOVED AND DELIVERED TO THE SPWSD HEADQUARTERS AND 6" WATER MAIN
ROCK COLLINA <u>22225669049</u> DHIKS UPINDER+PRAVED S 215I EASTILLARE SAMAMISH PKNY SE	POLE TO BE RELOCATED BY OTHERS.
\ 1.6' X 1.6'	PROTECT EXISTING UTILITY.
UT	LITY CONSTRUCTION NOTES:

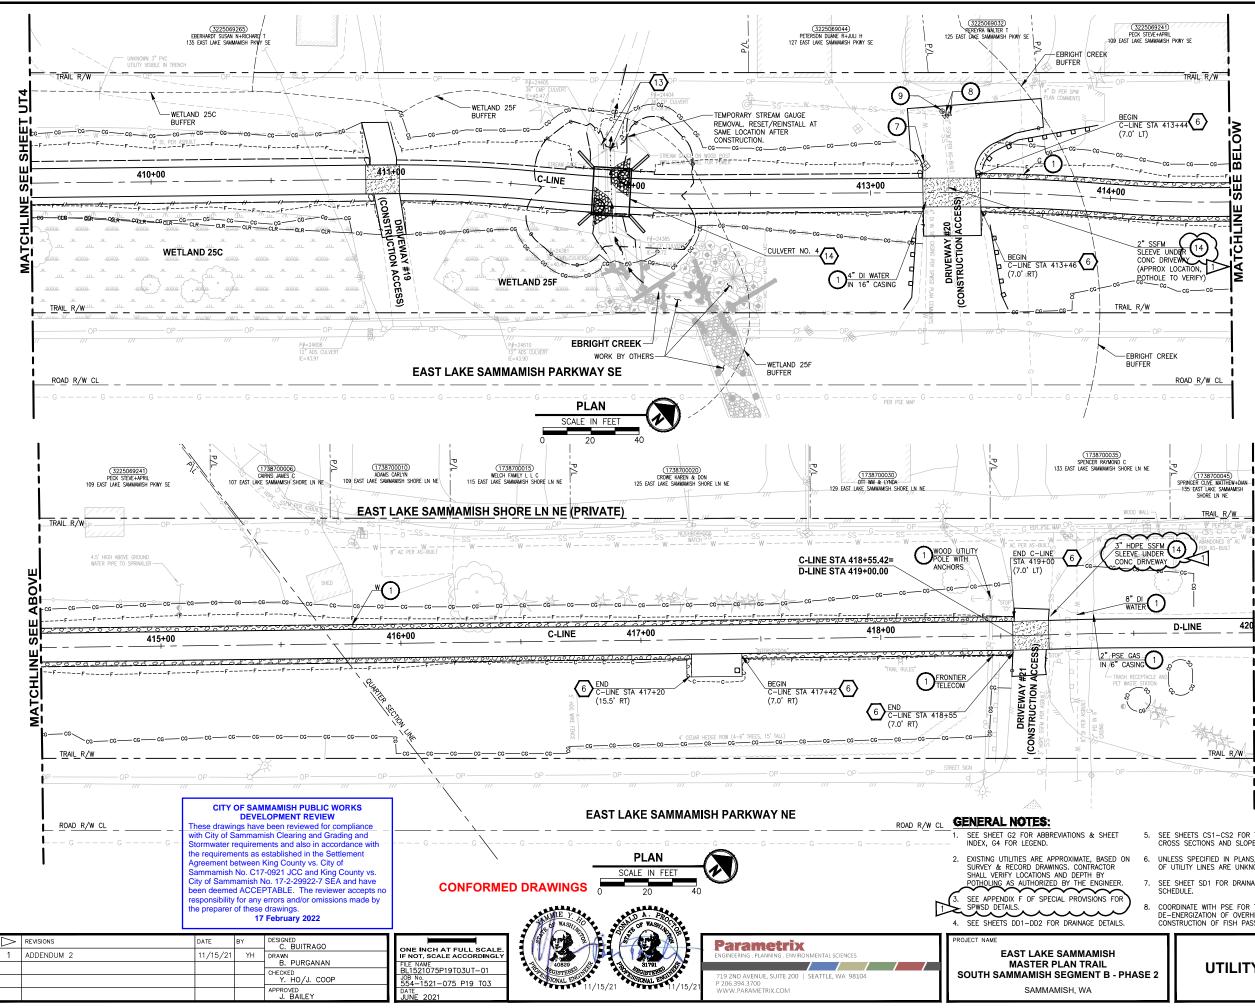


Addendum 2			UT5		
	05.0	UTILIT		AINAGE PLAN	SHEET NO. 67 OF 213
) 5.	DE-	ORDINATE WITH PSE FOR -ENERGIZATION OF OVERH NSTRUCTION OF FISH PAS	IEAD LINE DURING	Community Development	Date
		E SHEET SD1 FOR DRAIN/ HEDULE.	AGE STRUCTURES	City Engineer	Date
ON		LESS SPECIFIED IN PLANS UTILITY LINES ARE UNKN		CITY OF SAMMAMISH	APPROVAL
		E SHEETS CS1-CS2 FOR DSS SECTIONS AND SLOP			
			i 🕀	INSTALL AGENCY DESIGNED BURIED S (OWNER FURNISHED). SEE SPECIAL I SECTION 6-20 AND FP SHEETS FOR STREAM DETAILS.	STRUCTURE PROVISIONS
P ——		OP m	12	REMOVE DRAINAGE STRUCTURE/MANH	
	7			PLUG EXISTING PIPE.	
	<i>y</i> .	ALA		ADJUST CATCH BASIN/MANHOLE TO	FINISHED GRADE.
	co		MATCHI	QUARRY SPALL OUTFALL PROTECTION ON SHEET DD1.	I. SEE DETAIL 3
6-			<u>i</u>	CHANNEL DRAIN, SEE DETAIL 3 ON	SHEET DD2.
SH RECE	EPTACLE AND STATION			CONCRETE HEADWALL AND SLEEVE, S	SEE DETAIL 1 ON
E GAS CASIN				PERMEABLE BALLAST INFILTRATION THE TYPICAL SECTION F ON SHEET CS2.	RENCH, SEE
- +-		<u>D-LINE</u> 420		INSTALL STORM DRAINS, CATCH BASI SEE SD SHEETS FOR PROFILES.	NS, AND CULVERTS
WAIL		D-LINE 420	S Ш	CONNECTION TO DRAINAGE STRUCTURE	RE AND CLEANING
8" C WATE	$\frac{1}{2}$			SHEETS FOR PROFILES, SEE SHEET ROCK PAD, SEE DETAIL 2 ON SHEET	
	66			INSTALL UNDERDRAIN TRENCH AND C	LEANOUTS, SEE SI
			ㅋ	NFILTRATION TRENCH, SEE DETAIL 4	
HDP	E SSFM	ABANDONED 8" AC "	မျ	SHOWN. SEE SPECIAL PROVISIONS.	

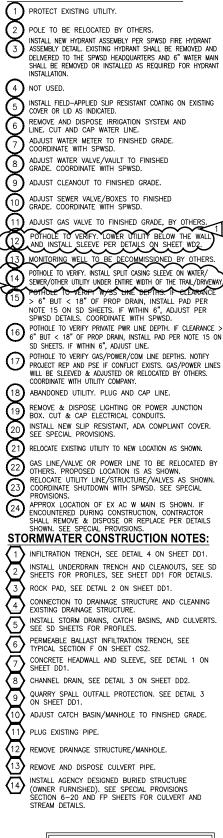

UTILITY CONSTRUCTION NOTES:

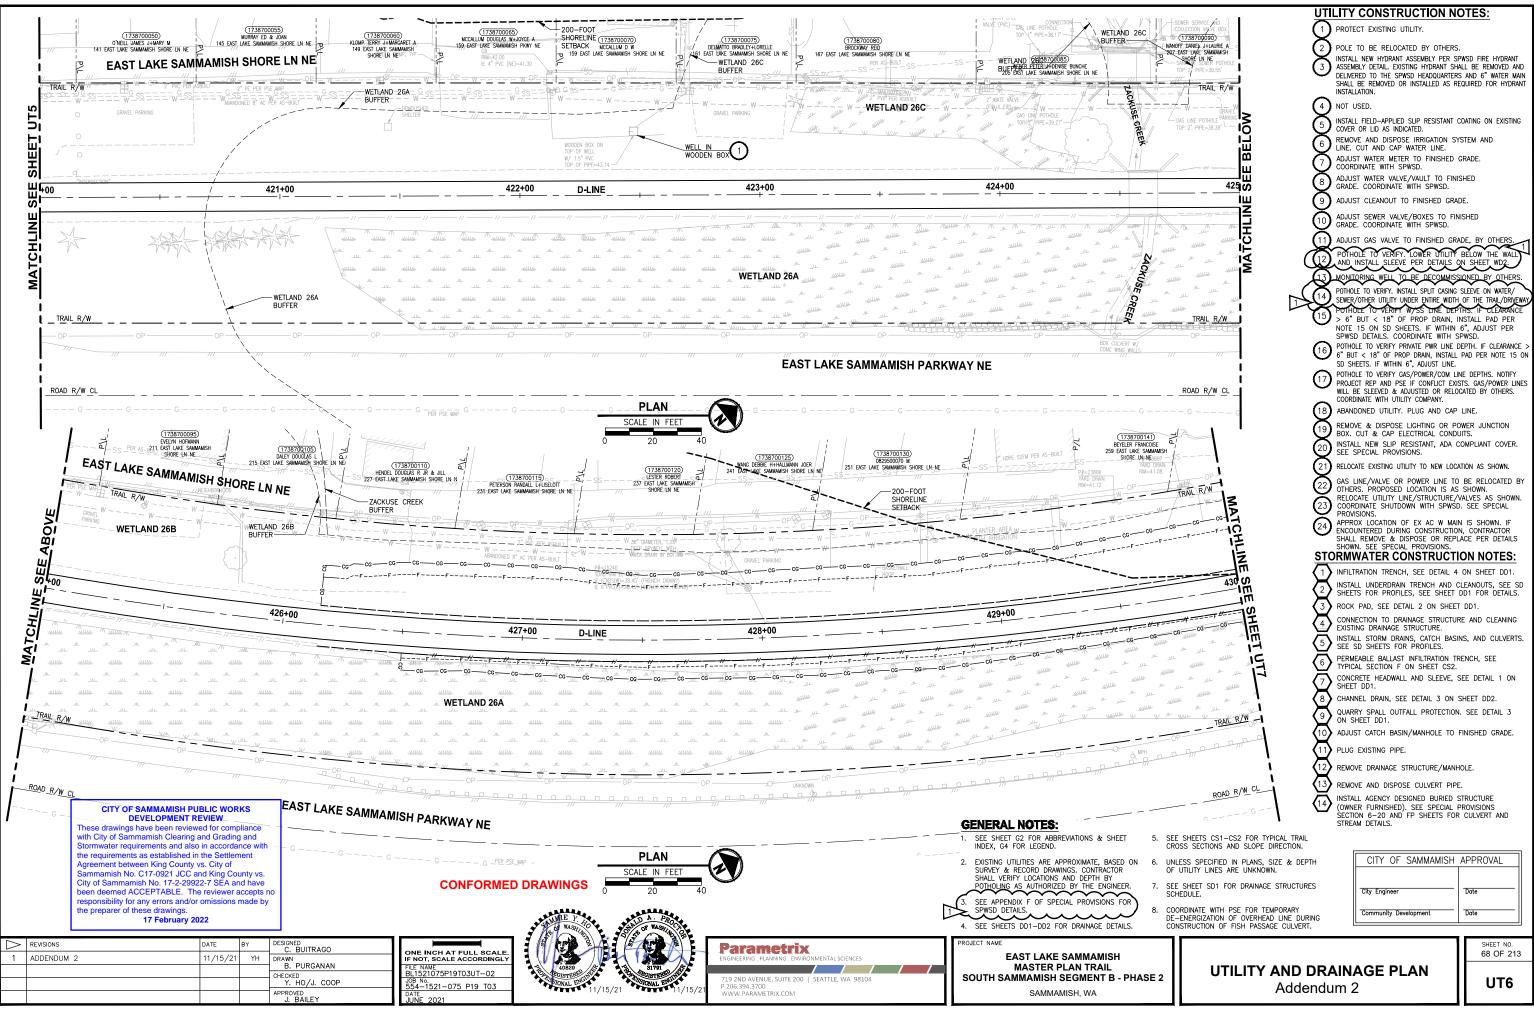

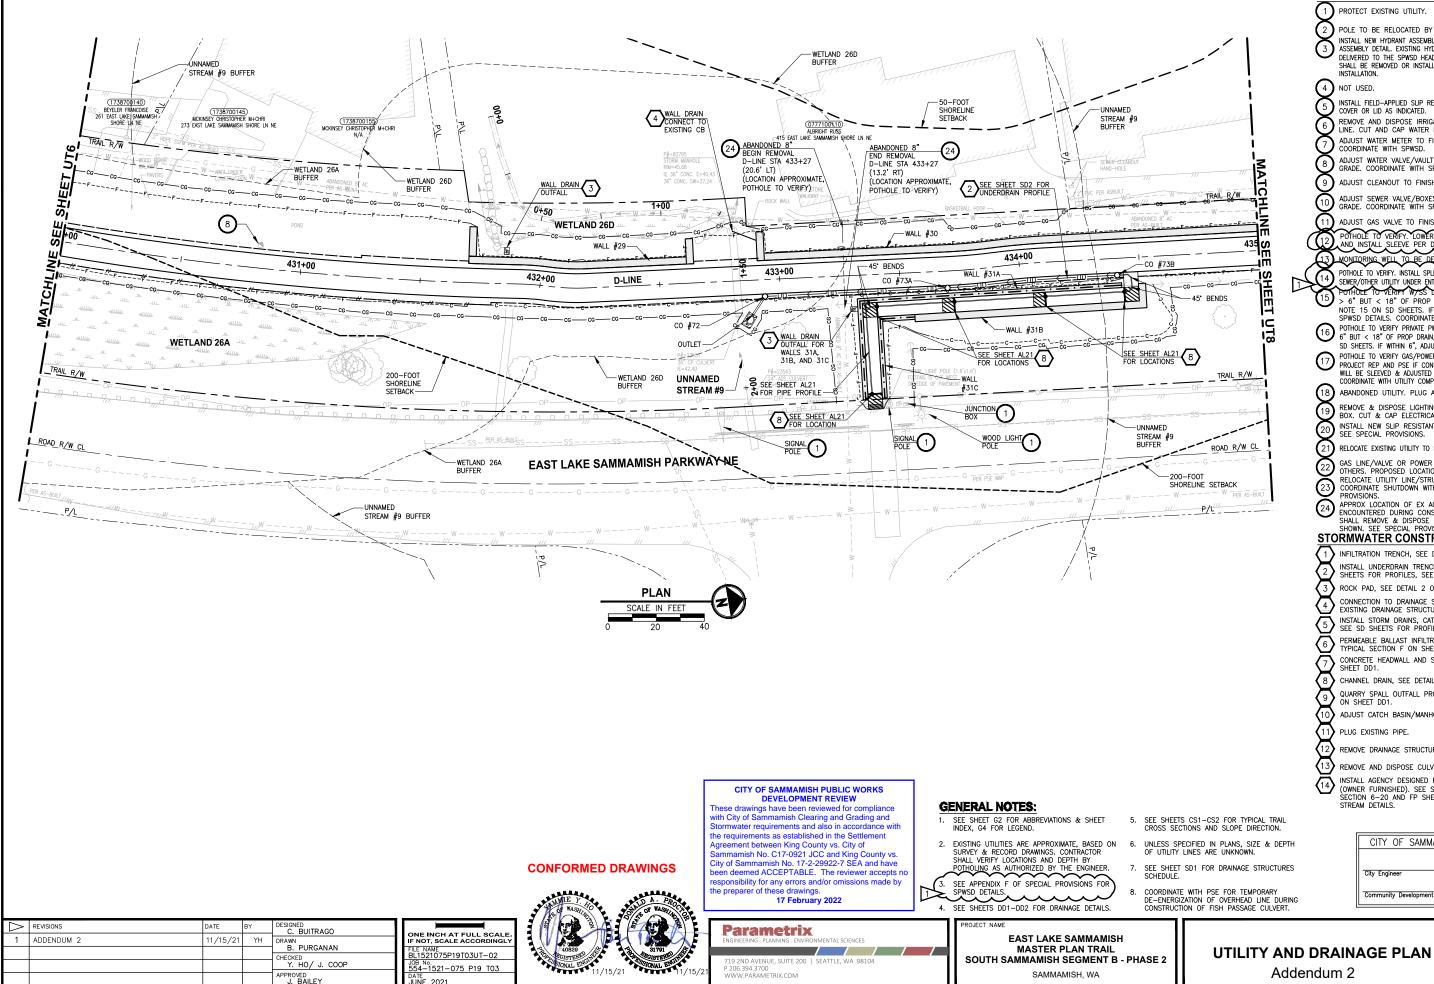

SAMMAMISH, WA

		CON	SIR	UCTION	N N	OTES:
(1)	PROTE	ECT EXIST	ing u	TILITY.		
\tilde{a}	POLE	TO BE R	ELOCA	TED BY OT	HERS	i.
3	ASSEN DELIVE SHALL	ibly detail Red to th	L. EXIS HE SPW	ting hydran /Sd headqu/	NT SH ARTER	PWSD FIRE HYDRANT ALL BE REMOVED AND S AND 6" WATER MAIN EQUIRED FOR HYDRANT
(4)	NOT I	JSED.				
(5)		L FIELD-A			ant (COATING ON EXISTING
- Č	REMO	VE AND D	ISPOS	E IRRIGATIO		YSTEM AND
X	ADJUS	ST WATER	METE	WATER LINE R TO FINIS		GRADE.
X		DINATE WI ST WATER		PWSD. E/VAULT_TC	FIN	SHED
l 🖉	GRADI	E. COORD	INATE	WITH SPWS	D.	
୍ର) FINISHED		
				E/BOXES T WITH SPWS		NSHED
	\sim	$\sim \sim \sim$	\sim	\sim	\sim	ADE, BY OTHERS.
	POTH	olë to v Install s	'ERIFY. SLEEVE	LOWER UT	TILITŸ JILS (BELOW THE WALL
Ð	MONI	ORING WE		BE DECO		SIONED BY OTHERS.
\sim (14)	POTHO	LE TO VERI	FY. INS	TALL SPLIT C	ASING	SLEEVE ON WATER/
	POTH	DEE TO V	ERIFT	W/SS LINE	DEP	OF THE TRAIL/DRIVEWA
0	NOTE SPWS	15 ON S D DETAILS	SD SHI	EETS. IF WI ORDINATE W	thin Ith s	
(16)	6"BU SD S⊦	T < 18" (HEETS. IF W	of Pro Nithin	P DRAIN, IN 6", ADJUST	stall Line.	DEPTH. IF CLEARANCE PAD PER NOTE 15 OF
17	PROJE WILL I	ict rep an Be sleevei	ND PSE D & Al	IF CONFLIC	T EXI RELO	NE DEPTHS. NOTIFY STS. GAS/POWER LINES CATED BY OTHERS.
(18)				TY COMPANY PLUG AND		LINE.
(19)	REMO	VE & DIS	POSE	LIGHTING (ECTRICAL (R P	OWER JUNCTION
$\overbrace{20}$	INSTA	LL NEW S	SLIP R	ESISTANT, A		COMPLIANT COVER.
		SPECIAL F			1.00	ATION AS SHOWN.
) BE RELOCATED BY
X	RELO	CATE UTIL	ITY LI	LOCATION I	URE/	VALVES AS SHOWN.
(23)	PROV	ISIONS.				D. SEE SPECIAL
(24)	APPR ENCO	OX LOCAT	DURIN	F EX AC W	JCTIO	N IS SHOWN. IF N, CONTRACTOR _ACE PER DETAILS
070	SHOW	'N. SEE S	PECIAI	_ PROVISIOI	٧S.	
~						ON NOTES:
						ON SHEET DD1.
$\sum_{i=1}^{2}$	SHEE	TS FOR P	ROFILI	ES, SEE SH	IEET	DD1 FOR DETAILS.
$\langle 3 \rangle$				AIL 2 ON S		r dd1. RE AND CLEANING
4	EXIST	ING DRAIN	AGE S	STRUCTURE.		INS, AND CULVERTS.
<u>(5</u>)	SEE	SD SHEET	'S FOF	R PROFILES	•	
6	PERM TYPIC	EABLE BA	llast DN F	INFILTRATIO	ON TH CS2.	RENCH, SEE
$\overline{2}$		RETE HEA	DWALL	AND SLEE	VE,	SEE DETAIL 1 ON
(8)			N, SEE	E DETAIL 3	ON	SHEET DD2.
~ (⁵)		RY SPALL HEET DD1		ALL PROTE	CTION	N. SEE DETAIL 3
$\overline{\langle 10 \rangle}$				N/MANHOLE	TO	FINISHED GRADE.
$\langle 1 \rangle$	PLUG	EXISTING	PIPE.			
$\overline{12}$	REMO	VE DRAIN	AGE S	TRUCTURE/	MANH	HOLE.
$\overline{13}$	REMO	VE AND D	DISPOS	E CULVERT	PIPI	E.
$\overbrace{14}$				GIGNED BUR		
Ý	SECTI	ON 6-20	AND	. SEE SPEC FP SHEETS	S FOF	PROVISIONS CULVERT AND
	SIRE	AM DETAIL	.3.			
-	I		05	<u></u>		
PTH			OF	SAMMAM	ISH	APPROVAL
RES						

UTILITY CONSTRUCTION NOTES:


- COORDINATE WITH PSE FOR TEMPORARY DE-ENERGIZATION OF OVERHEAD LINE DURING CONSTRUCTION OF FISH PASSAGE CULVERT.

CITY OF SAMMAMISH APPROVAL				
City Engineer	Date			
Community Development	Date			

SHEET NO.				
69	OF	213		

Addendum 2

UT7

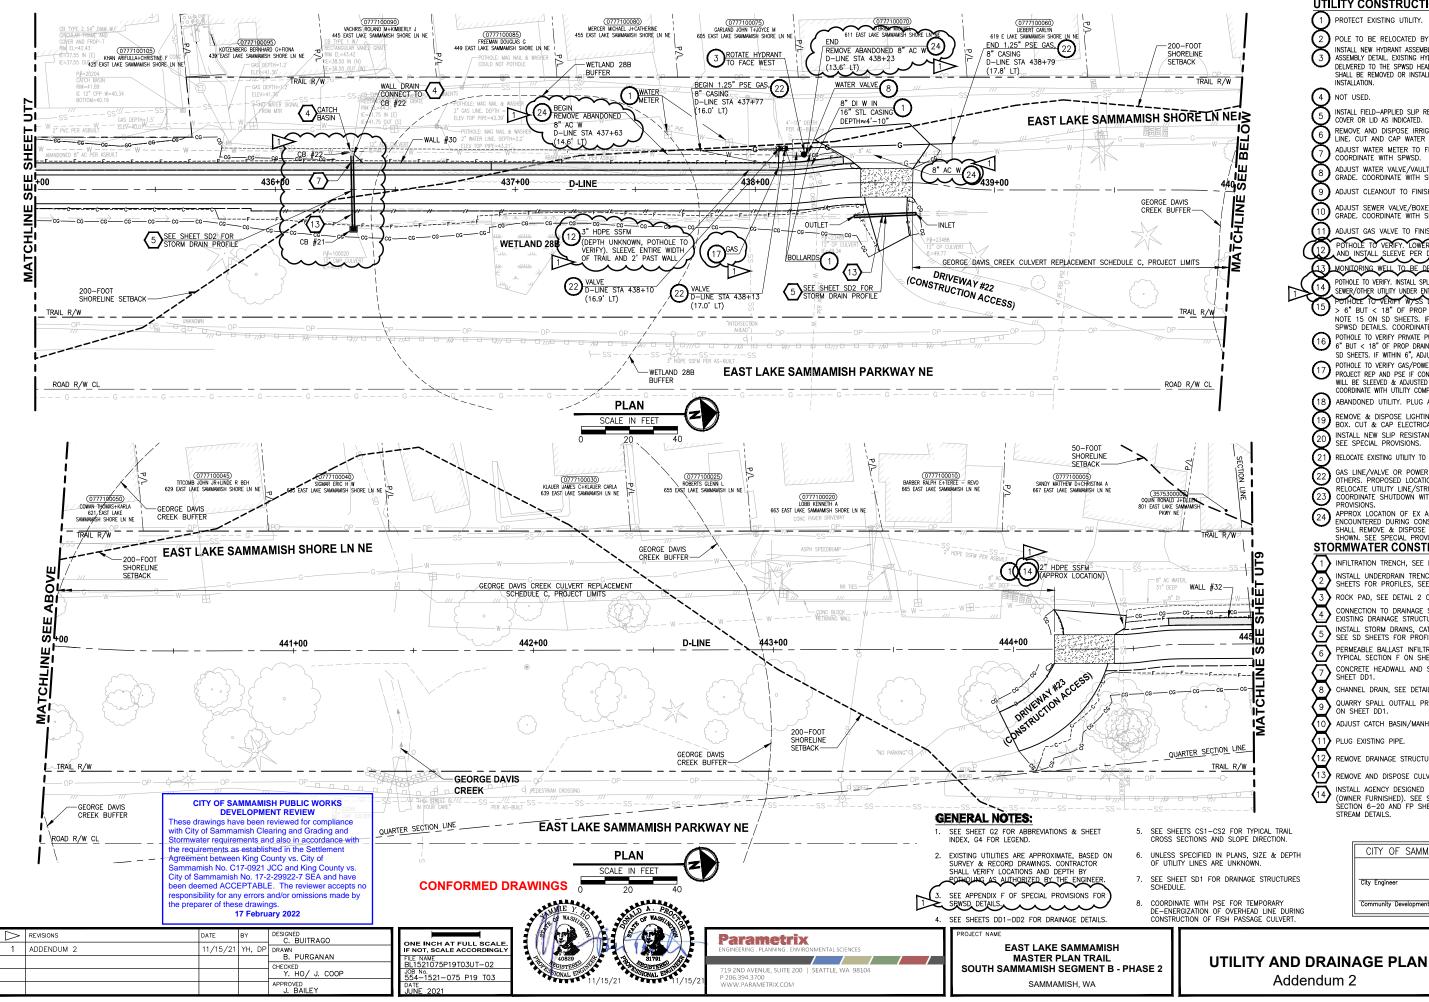

- CROSS SECTIONS AND SLOPE DIRECTION.


- COORDINATE WITH PSE FOR TEMPORARY DE-ENERGIZATION OF OVERHEAD LINE DURING CONSTRUCTION OF FISH PASSAGE CULVERT.
- UTILITY CONSTRUCTION NOTES: 1 PROTECT EXISTING UTILITY. 2 POLE TO BE RELOCATED BY OTHERS. INSTALL NEW HYDRANT ASSEMBLY PER SPWSD FIRE HYDRANT 3 ASSEMBLY DETAIL. EXISTING HYDRANT SHALL BE REMOVED AND DELIVERED TO THE SPWSD HEADQUARTERS AND 6" WATER MAIN SHALL BE REMOVED OR INSTALLED AS REQUIRED FOR HYDRAN INSTALLATION 4 NOT USED. INSTALL FIELD-APPLIED SLIP RESISTANT COATING ON EXISTING COVER OR LID AS INDICATED. (5) REMOVE AND DISPOSE IRRIGATION SYSTEM AND 6 LINE. CUT AND CAP WATER LINE. ADJUST WATER METER TO FINISHED GRADE. $\overline{7}$ COORDINATE WITH SPWSD. 8 ADJUST WATER VALVE/VAULT TO FINISHED GRADE. COORDINATE WITH SPWSD. (9) ADJUST CLEANOUT TO FINISHED GRADE. ADJUST SEWER VALVE/BOXES TO FINISHED (10) GRADE. COORDINATE WITH SPWSD. ADJUST GAS VALVE TO FINISHED GRADE, BY OTHER POTHOLE TO VERIFY. LOWER UTILITY BELOW THE WALL AND INSTALL SLEEVE PER DETAILS ON SHEET WD2. (12)13 MONITORING WELL TO BE DECOMMISSIONED BY OTHERS POTHOLE TO VERIFY. INSTALL SPLIT CASING SLEEVE ON WATER/ (14)SEWER/OTHER UTILITY UNDER ENTIRE WIDTH OF THE TRAIL/DR 15 > 6" BUT < 18" OF PROP DRAIN, INSTALL PAD PER NOTE 15 ON SD SHEETS. IF WITHIN 6", ADJUST PER SPWSD DETAILS. COORDINATE WITH SPWSD. POTHOLE TO VERIFY PRIVATE PWR LINE DEPTH. IF CLEARANCE (16) 6" BUT < 18" OF PROP DRAIN, INSTALL PAD PER NOTE 15 0 SD SHEETS. IF WITHIN 6", ADJUST LINE. POTHOLE TO VERIFY GAS/POWER/COM LINE DEPTHS. NOTIFY (17)PROJECT REP AND PSE IF CONFLICT EXISTS, GAS/POWER LINES WILL BE SLEEVED & ADJUSTED OR RELOCATED BY OTHERS. COORDINATE WITH UTILITY COMPANY. (18)ABANDONED UTILITY. PLUG AND CAP LINE. REMOVE & DISPOSE LIGHTING OR POWER JUNCTION (19) BOX. CUT & CAP ELECTRICAL CONDUITS. INSTALL NEW SLIP RESISTANT, ADA COMPLIANT COVER. SEE SPECIAL PROVISIONS. (20) (21) RELOCATE EXISTING UTILITY TO NEW LOCATION AS SHOWN. GAS LINE/VALVE OR POWER LINE TO BE RELOCATED BY (22) OTHERS. PROPOSED LOCATION IS AS SHOWN. RELOCATE UTILITY LINE/STRUCTURE/VALVES AS SHOWN (23) COORDINATE SHUTDOWN WITH SPWSD. SEE SPECIAL PROVISIONS (24) APPROX LOCATION OF EX AC W MAIN IS SHOWN. IF ENCOUNTERED DURING CONSTRUCTION, CONTRACTOR SHALL REMOVE & DISPOSE OR REPLACE PER DETAILS STORMWATER CONSTRUCTION NOTES: 1 INFILTRATION TRENCH, SEE DETAIL 4 ON SHEET DD1 $\sum_{i=1}^{n}$ INSTALL UNDERDRAIN TRENCH AND CLEANOUTS, SEE SD SHEETS FOR PROFILES, SEE SHEET DD1 FOR DETAILS. $\overline{3}$ ROCK PAD, SEE DETAIL 2 ON SHEET DD1. $\overline{4}$ CONNECTION TO DRAINAGE STRUCTURE AND CLEANING EXISTING DRAINAGE STRUCTURE. INSTALL STORM DRAINS, CATCH BASINS, AND CULVERTS. SEE SD SHEETS FOR PROFILES. $\langle 5 \rangle$ PERMEABLE BALLAST INFILTRATION TRENCH, SEE TYPICAL SECTION F ON SHEET CS2. (6) $\overline{7}$ CONCRETE HEADWALL AND SLEEVE, SEE DETAIL 1 ON SHEET DD1 ᢙ CHANNEL DRAIN, SEE DETAIL 3 ON SHEET DD2. 5 QUARRY SPALL OUTFALL PROTECTION. SEE DETAIL 3 ON SHEET DD1 ADJUST CATCH BASIN/MANHOLE TO FINISHED GRADE. (11) PLUG EXISTING PIPE. REMOVE DRAINAGE STRUCTURE/MANHOLE. REMOVE AND DISPOSE CULVERT PIPE. INSTALL AGENCY DESIGNED BURIED STRUCTURE $\left(14\right)$ (OWNER FURNISHED). SEE SPECIAL PROVISIONS SECTION 6-20 AND FP SHEETS FOR CULVERT AND STREAM DETAILS


CITY OF SAMMAMISH	APPROVAL
City Engineer	Date
Community Development	Date

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Addendum 2

UT8



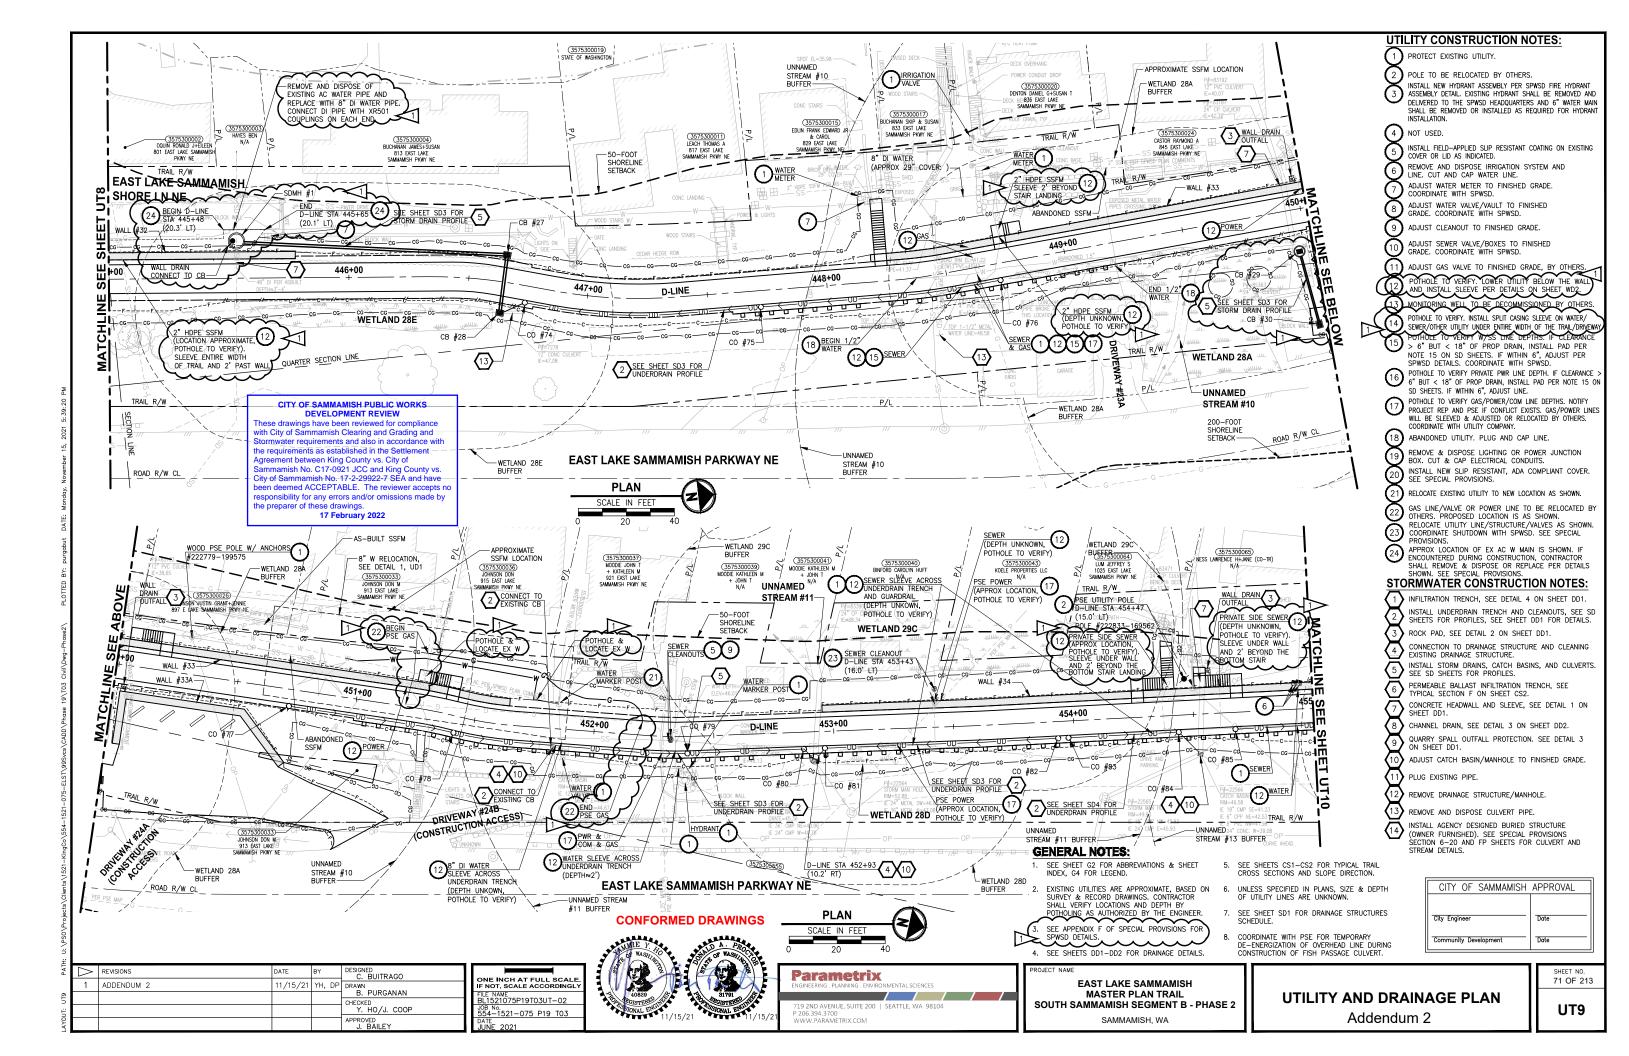

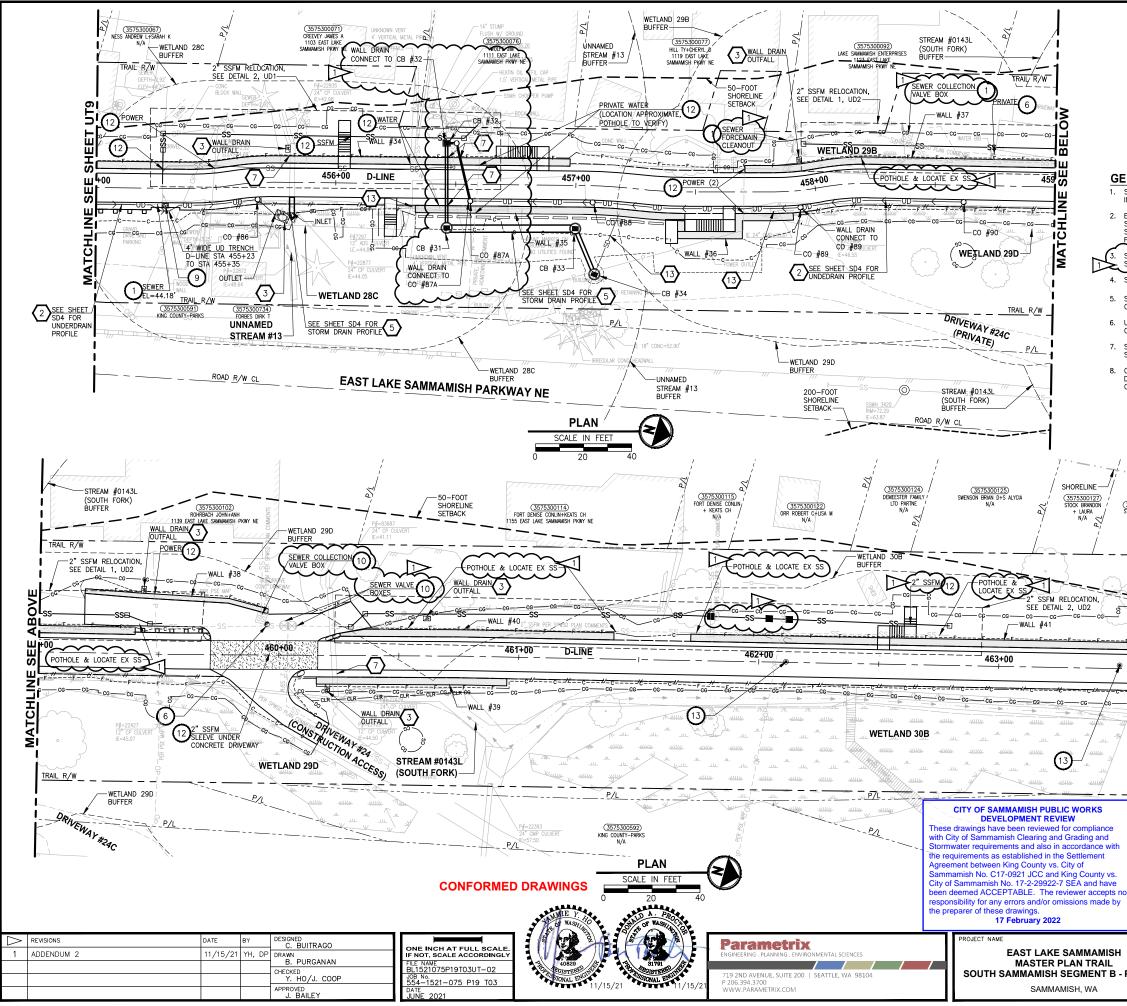SEE SHEET G2 FOR ABBREVIATIONS & SHEET	GRADE. COORDINATE WITH SPWSD.	
INDEX, G4 FOR LEGEND.	9 ADJUST CLEANOUT TO FINISHED GR	
EXISTING UTILITIES ARE APPROXIMATE, BASED ON SURVEY & RECORD DRAWINGS. CONTRACTOR SHALL VERIFY LOCATIONS AND DEPTH BY POTHOLING AS AUTHORIZED BY THE ENGINEER	10 ADJUST SEWER VALVE/BOXES TO F GRADE. COORDINATE WITH SPWSD. (11) ADJUST GAS VALVE TO FINISHED G	
POTHOLING AS AUTHORIZED BY THE ENGINEER. SEE APPENDIX F OF SPECIAL PROVISIONS FOR SPWSD DETAILS.	12 POTHOLE TO VERIFY. LOWER UTILIT AND INSTALL SLEEVE PER DETAILS	BELOW THE WALL
SEE SHEETS DD1-DD2 FOR DRAINAGE DETAILS.	13 MONITORING WELL TO BE DECOMMIS	$\sim \sim \sim \sim$
SEE SHEETS CS1-CS2 FOR TYPICAL TRAIL CROSS SECTIONS AND SLOPE DIRECTION.	14 POTHOLE TO VERIFY. INSTALL SPLIT CASIN SEWER/OTHER UTILITY UNDER ENTIRE WIDT 15 DOTHOLE TO VERIFY WYSS LINE DE 15 DOTHOLE TO VERIFY WYSS LINE DE DE DIT - 19" DE PODO	H OF THE TRAIL/DRIVEWAY
UNLESS SPECIFIED IN PLANS, SIZE & DEPTH OF UTILITY LINES ARE UNKNOWN.	> 6" BUT < 18" OF PROP DRAIN, NOTE 15 ON SD SHEETS. IF WITHIN SPWSD DETAILS. COORDINATE WITH	INSTALL PAD PER 6", ADJUST PER SPWSD.
SEE SHEET SD1 FOR DRAINAGE STRUCTURES SCHEDULE.	16 POTHOLE TO VERIFY PRIVATE PWR LINE 6" BUT < 18" OF PROP DRAIN, INSTAL SD SHEETS. IF WITHIN 6", ADJUST LINE	L PAD PER NOTE 15 ON
COORDINATE WITH PSE FOR TEMPORARY DE-ENERGIZATION OF OVERHEAD LINE DURING CONSTRUCTION OF FISH PASSAGE CULVERT.	POINTOLE TO VERIFY GAS/POWER/COM PROJECT REP AND PSE IF CONFLICT ED WILL BE SLEEVED & ADJUSTED OR REL COORDINATE WITH UTILITY COMPANY.	(ISTS. GAS/POWER LINES OCATED BY OTHERS.
	18 ABANDONED UTILITY. PLUG AND CAI	
	19 REMOVE & DISPOSE LIGHTING OR F BOX. CUT & CAP ELECTRICAL CONI	DUITS.
.	20 INSTALL NEW SLIP RESISTANT, ADA SEE SPECIAL PROVISIONS.	
	(21) RELOCATE EXISTING UTILITY TO NEW LO	
(3575300128) STOCK BRANDON / (3575300129) / ,	22 GAS LINE/VALVE OR POWER LINE T OTHERS. PROPOSED LOCATION IS A RELOCATE UTILITY LINE/STRUCTURE 23 COORDINATE SHUTDOWN WITH SPWS PROVISIONS.	S SHOWN. /VALVES AS SHOWN. 5D. SEE SPECIAL
+ LAURA STOCK BRANDON / M N/A a, + LAURA / / N/A a,	APPROX LOCATION OF EX AC W M/ ENCOUNTERED DURING CONSTRUCTI SHALL REMOVE & DISPOSE OR REF SHOWN. SEE SPECIAL PROVISIONS.	ON, CONTRACTOR
- $ /$ $ /$ $ /$ $/$ $-$		ION NOTES:
ALL REAL	2 INSTALL UNDERDRAIN TRENCH AND SHEETS FOR PROFILES, SEE SHEET	DD1 FOR DETAILS.
	3 ROCK PAD, SEE DETAIL 2 ON SHE	
	SEE SD SHEETS FOR PROFILES.	
	6 PERMEABLE BALLAST INFILTRATION TYPICAL SECTION F ON SHEET CS2	
ງທ	CONCRETE HEADWALL AND SLEEVE, SHEET DD1.	
	8 CHANNEL DRAIN, SEE DETAIL 3 ON QUARRY SPALL OUTFALL PROTECTIO	
	ON SHEET DD1.	
	ADJUST CATCH BASIN/MANHOLE TO	FINISHED GRADE.
	11 PLUG EXISTING PIPE.	
		_
(NORTH FORK) / 	13 REMOVE AND DISPOSE CULVERT PI	STRUCTURE
WETLAND 30B	(OWNER FURNISHED). SEE SPECIAL SECTION 6-20 AND FP SHEETS FO STREAM DETAILS.	PROVISIONS
/		
	CITY OF SAMMAMISH	APPROVAL
	City Engineer	Date
10		
	Community Development	Date
		SHEET NO. 72 OF 213
PHASE 2	ID DRAINAGE PLAN ddendum 2	UT10

UTILITY CONSTRUCTION NOTES:

INSTALL NEW HYDRANT ASSEMBLY PER SPWSD FIRE HYDRANT

DELIVERED TO THE SPWSD HEADQUARTERS AND 6" WATER MAIN SHALL BE REMOVED OR INSTALLED AS REQUIRED FOR HYDRANT

INSTALL FIELD-APPLIED SLIP RESISTANT COATING ON EXISTING COVER OR LID AS INDICATED.

REMOVE AND DISPOSE IRRIGATION SYSTEM AND LINE. CUT AND CAP WATER LINE.

ADJUST WATER METER TO FINISHED GRADE.

ADJUST WATER VALVE/VAULT TO FINISHED

3 INSIALL NEW HYDRANI ASSEMBLY PER SPWSD FIRE HYDRANI ASSEMBLY DETAIL. EXISTING HYDRANT SHALL BE REMOVED AND THE REPORT TO THE SPWED HERDINATES AND STATES AND STATES

2 POLE TO BE RELOCATED BY OTHERS.

1 PROTECT EXISTING UTILITY.


INSTALLATION.

4 NOT USED.

(5)

6

GENERAL NOTES:

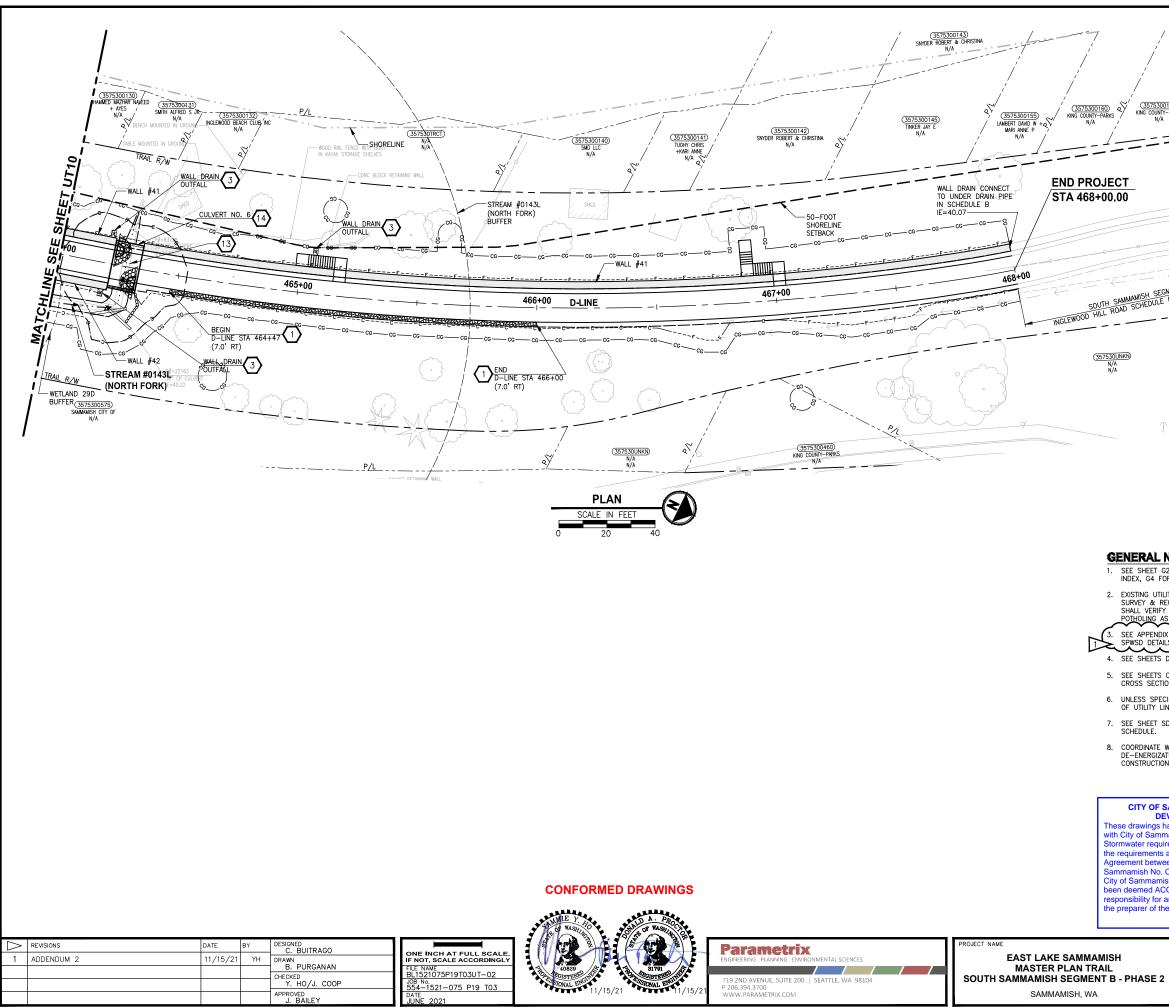

	1 <u>518" A</u>
(<u>3575300165</u>) KING COUNT-PARKS N/A	/ RAIL_R/W =
<u>)</u>	ц. IE IE
IMAMISH SEGMENT B O SCHEDULE B, PROJE	CT LIMITS



GENERAL NOTES:

1. SEE SHEET G2 FOR ABBREVIATIONS & SHEET INDEX, G4 FOR LEGEND.

2. EXISTING UTILITIES ARE APPROXIMATE, BASED ON SURVEY & RECORD DRAWINGS, CONTRACTOR SHALL VERIFY LOCATIONS AND DEPTH BY POTHOLING AS AUTHORIZED BY THE ENGINEER

~		\sim	\sim	~		\sim	~	\sim	\sim	\sim	
SEE	APPEI	NDIX	F	OF	SP	ECIA	LΡ	ROVIS	SIONS	FOR	١
SPWS	SD_DE	TAILS	S.							. /	

4. SEE SHEETS DD1-DD2 FOR DRAINAGE DETAILS.

5. SEE SHEETS CS1-CS2 FOR TYPICAL TRAIL CROSS SECTIONS AND SLOPE DIRECTION.

6. UNLESS SPECIFIED IN PLANS, SIZE & DEPTH OF UTILITY LINES ARE UNKNOWN.

7. SEE SHEET SD1 FOR DRAINAGE STRUCTURES SCHEDULE.


8. COORDINATE WITH PSE FOR TEMPORARY DE-ENERGIZATION OF OVERHEAD LINE DURING CONSTRUCTION OF FISH PASSAGE CULVERT.

CITY OF SAMMAMISH PUBLIC WORKS DEVELOPMENT REVIEW

ese drawings have been reviewed for compl with City of Sammamish Clearing and Grading and ormwater requirements and also in accordance with he requirements as established in the Settlement Agreement between King County vs. City of mamish No. C17-0921 JCC and King County vs. City of Sammamish No. 17-2-29922-7 SEA and have een deemed ACCEPTABLE. The reviewer accepts n sponsibility for any errors and/or omissions made by the preparer of these drawings 17 February 2022

UTILITY CONSTRUCTION NOTES: 1 PROTECT EXISTING UTILITY. 2 POLE TO BE RELOCATED BY OTHERS. INSTALL NEW HYDRANT ASSEMBLY PER SPWSD FIRE HYDRANT 3 ASSEMBLY DETAIL. EXISTING HYDRANT SHALL BE REMOVED AND DELIVERED TO THE SPWSD HEADQUARTERS AND 6" WATER MAIN SHALL BE REMOVED OR INSTALLED AS REQUIRED FOR HYDRAN INSTALLATION. 4 NOT USED. INSTALL FIELD-APPLIED SLIP RESISTANT COATING ON EXISTING COVER OR LID AS INDICATED. (5) REMOVE AND DISPOSE IRRIGATION SYSTEM AND 6 LINE. CUT AND CAP WATER LINE. ADJUST WATER METER TO FINISHED GRADE. $\overline{7}$ COORDINATE WITH SPWSD. ADJUST WATER VALVE/VAULT TO FINISHED GRADE. COORDINATE WITH SPWSD. 9 ADJUST CLEANOUT TO FINISHED GRADE. ADJUST SEWER VALVE/BOXES TO FINISHED GRADE. COORDINATE WITH SPWSD. (10) (11) ADJUST GAS VALVE TO FINISHED GRADE, BY OTHER POTHOLE TO VERIFY. LOWER UTILITY BELOW THE WALL AND INSTALL SLEEVE PER DETAILS ON SHEET WD2. (12)13 MONITORING WELL TO BE DECOMMISSIONED BY OTHERS POTHOLE TO VERIFY. INSTALL SPLIT CASING SLEEVE ON WATER/ (14)SUBER/OTHER UTILITY UNDER ENTRE WIDTH OF THE TRAL/DRIVE POTHOLE TO VERIET W/SS LINE DEPTHS. IF CLEARANCE > 6" BUT < 18" OF PROP DRAIN, INSTALL PAD PER 15 NOTE 15 ON SD SHEETS. IF WITHIN 6", ADJUST PER SPWSD DETAILS. COORDINATE WITH SPWSD. POTHOLE TO VERIFY PRIVATE PWR LINE DEPTH. IF CLEARANCE :
 6" BUT < 18" OF PROP DRAIN, INSTALL PAD PER NOTE 15 ON SD SHEETS. IF WITHIN 6", ADJUST LINE. 17 POTHOLE TO VERIFY GAS/POWER/COM LINE DEPTHS. NOTIFY PROJECT REP AND PSE IF CONFLICT EVENTS ON CONTENT PROJECT REP AND PSE IF CONFLICT EXISTS. GAS/POWER LINES WILL BE SLEEVED & ADJUSTED OR RELOCATED BY OTHERS. COORDINATE WITH UTILITY COMPANY. (18) ABANDONED UTILITY. PLUG AND CAP LINE. REMOVE & DISPOSE LIGHTING OR POWER JUNCTION **(**19) BOX. CUT & CAP ELECTRICAL CONDUITS. INSTALL NEW SLIP RESISTANT, ADA COMPLIANT COVER. SEE SPECIAL PROVISIONS. (20) (21) RELOCATE EXISTING UTILITY TO NEW LOCATION AS SHOWN. GAS LINE/VALVE OR POWER LINE TO BE RELOCATED BY (22) OTHERS, PROPOSED LOCATION IS AS SHOWN. RELOCATE UTILITY LINE/STRUCTURE/VALVES AS SHOWN. COORDINATE SHUTDOWN WITH SPWSD. SEE SPECIAL (23) PROVISIONS APPROX LOCATION OF EX AC W MAIN IS SHOWN, IF ENCOUNTERED DURING CONSTRUCTION, CONTRACTOR SHALL REMOVE & DISPOSE OR REPLACE PER DETAILS SHOWN, SEE SPECIAL PROVISIONS. (24)STORMWATER CONSTRUCTION NOTES:
 1
 INFILTRATION TRENCH, SEE DETAIL 4 ON SHEET DD1.


 2
 INSTALL UNDERDRAIN TRENCH AND CLEANOUTS, SEE SHEETS FOR PROFILES, SEE SHEET DD1 FOR DETAILS
 INSTALL UNDERDRAIN TRENCH AND CLEANOUTS, SEE SD SHEETS FOR PROFILES, SEE SHEET DD1 FOR DETAILS. SHELLS FOR PROFILES, SEE SHEET DD1 FC
 ROCK PAD, SEE DETAIL 2 ON SHEET DD1.
 CONNECTION TO DRAINAGE STRUCTURE AND
 EXISTING DRAINAGE STRUCTURE. CONNECTION TO DRAINAGE STRUCTURE AND CLEANING EXISTING DRAINAGE STRUCTURE. $\overline{5}$ install storm drains, catch basins, and culverts. See SD sheets for profiles. 6 PERMEABLE BALLAST INFILTRATION TRENCH, SEE TYPICAL SECTION F ON SHEET CS2. 7 SHEET DD1. 9 ON SHEET DD1. QUARRY SPALL OUTFALL PROTECTION. SEE DETAIL 3 ON SHEET DD1. $\overline{(10)}$ ADJUST CATCH BASIN/MANHOLE TO FINISHED GRADE. (11) PLUG EXISTING PIPE. (12)REMOVE DRAINAGE STRUCTURE/MANHOLE. REMOVE AND DISPOSE CULVERT PIPE. INSTALL AGENCY DESIGNED BURIED STRUCTURE $\left(14\right)$ (OWNER FURNISHED). SEE SPECIAL PROVISIONS SECTION 6-20 AND FP SHEETS FOR CULVERT AND STREAM DETAILS CITY OF SAMMAMISH APPROVAL City Engineer Date Community Developme Date

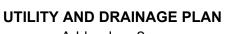


SHEET N 73 OF 213

Addendum 2

UT11

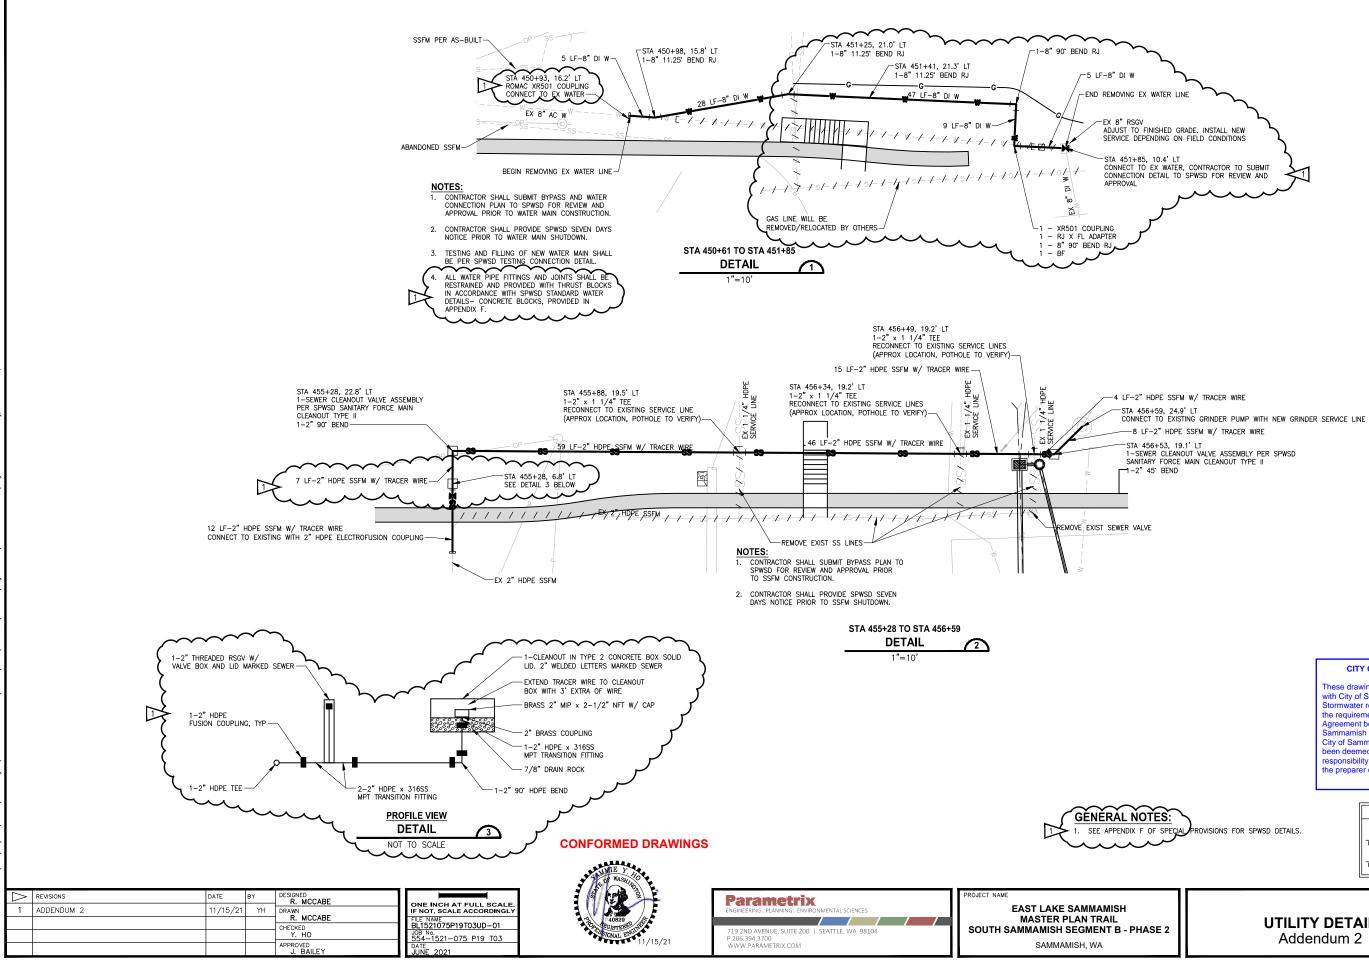


		These draw with City of Stormwater the requirer Agreement Sammamisi City of Sam been deem responsibili	OF SAMMAMISH PUBLIC DEVELOPMENT REVIEW ings have been reviewed for Sammamish Clearing and Gt requirements and also in acc ments as established in the S between King County vs. City h No. C17-0921 JCC and Kin mamish No. 17-2-29922-7 SI ed ACCEPTABLE. The revie ty for any errors and/or omiss r of these drawings. 17 February 2022	V compliance rading and sordance with ettlement y of g County vs. EA and have wer accepts no
NOTES: IX F OF SPECIAL	Provisions for spwsd details.		CITY OF SAMMAMISH City Engineer Community Development	APPROVAL Date Date
PHASE 2	UTILITY Adder	DETA ndum 2		SHEET NO. 74 OF 213

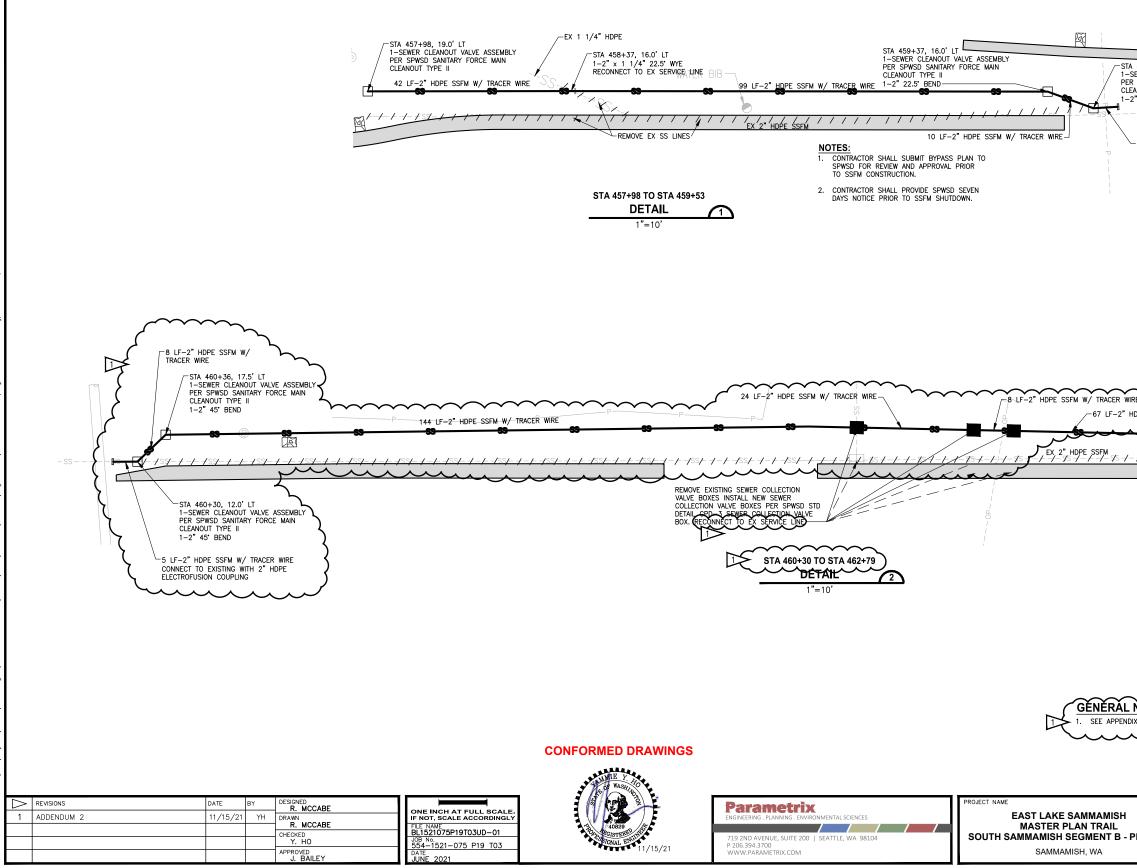

IRE HDPE SSFM W/		STA 462+79, 16.5' LT STA 462+79, 16.5' LT 1-SEWER CLEANOUT VALVE PER SPWSD SANITARY FORCI CLEANOUT TYPE II	
	SPWSD FOR REVIEW TO SSFM CONSTRU 2. CONTRACTOR SHALI	L SUBMIT BYPASS PLAN TO W AND APPROVAL PRIOR	
NOTES: IX F OF SPECIA	Provisions for spwsd details.	CITY OF SAMMAMISH PUBLIC DEVELOPMENT REVIEW These drawings have been reviewed for with City of Sammamish Clearing and G Stormwater requirements and also in ac the requirements as established in the S Agreement between King County vs. Cit Sammamish No. C17-0921 JCC and Kir City of Sammamish No. 17-2-29922.7 S been deemed ACCEPTABLE. The revie responsibility for any errors and/or omist the preparer of these drawings. 17 February 2022	V compliance rading and cordance with ettlement y of Ig County vs. EA and have awer accepts no sions made by
PHASE 2		1 DETAILS ndum 2	SHEET NO. 75 OF 213

5 LF−2" HDPE SSFM W/ TRACER WIRE CONNECT TO EXISTING WITH 2" HDPE ELECTROFUSION COUPLING

TA 459+46, 12.6' LT -SEWER CLEANOUT VALVE ASSEMBLY PER SPWSD SANITARY FORCE MAIN CLEANOUT TYPE II 1-2" 22.5' BEND

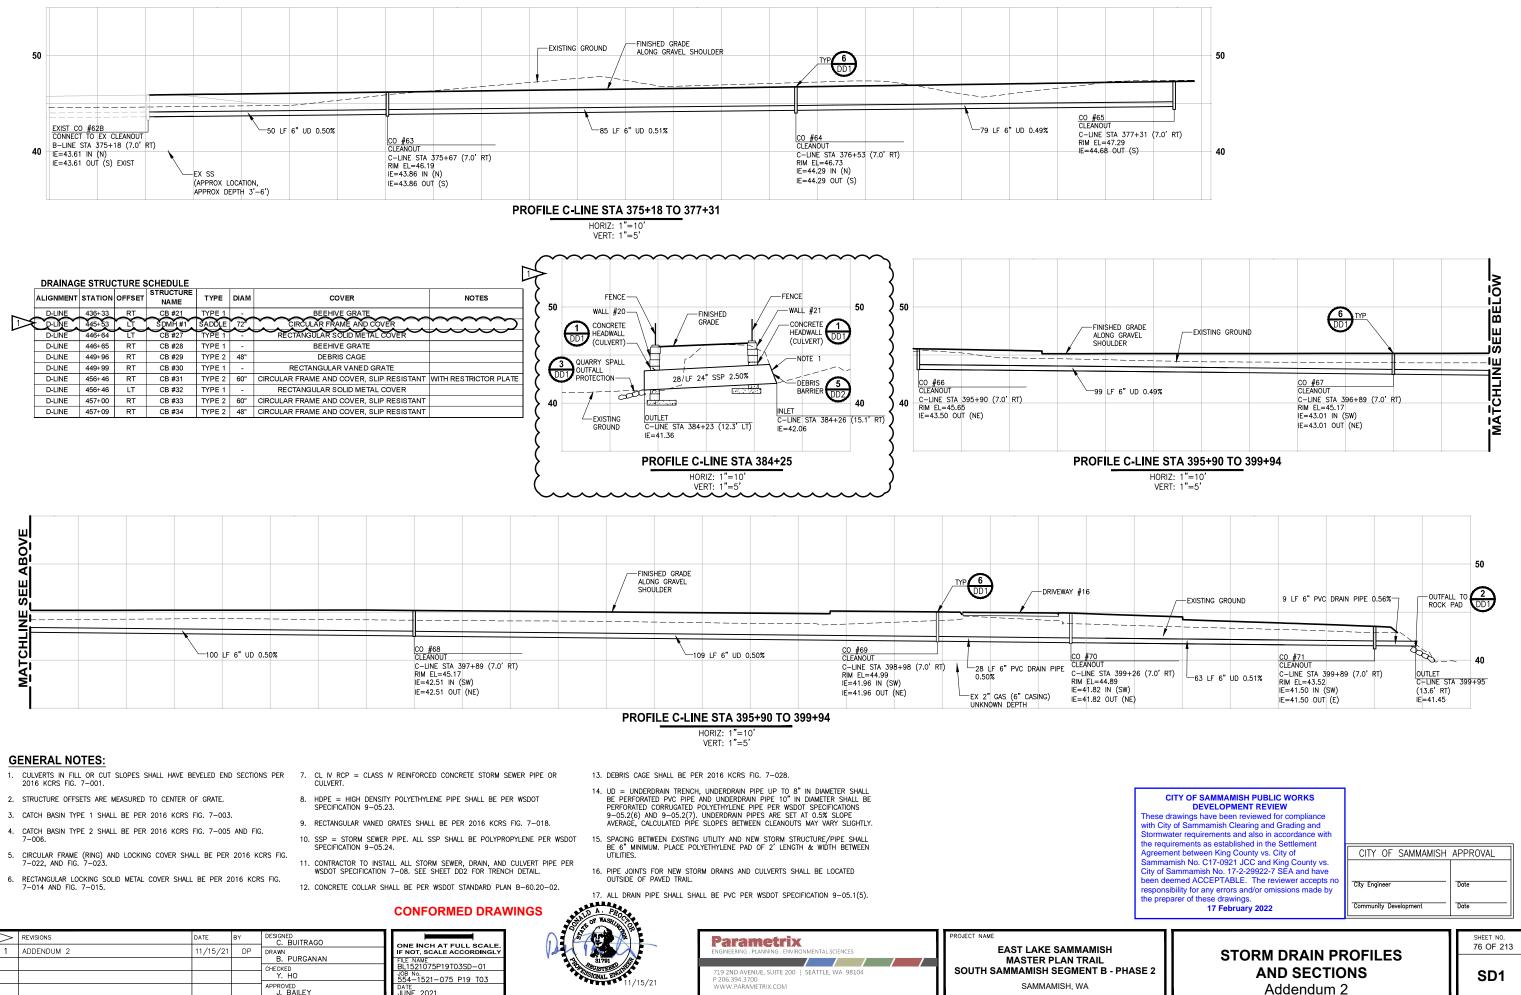





50


40

CO #73B

IE=46.61 OUT (S)

C-LINE \$TA 434+41 (7.0' RT) RIM EL=48.83 IE=46.61 IN (N)

-71 LF 6" UD 1.60%

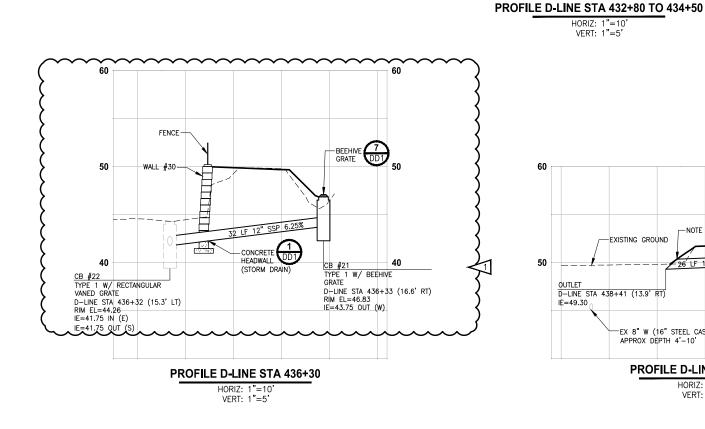

OUTFALL TO 2 ROCK PAD DD1

Ø

50

D-LINE STA 432+88 (14.7' RT)

40

10 LF 8" PVC DRAIN PIPE 0.90%-

OUTLET


IE=44.00

C-LINE STA 432+94 (7.0' RT) RIM EL=47.63

CO #72 CLEANOUT

IE=44.26 IN (N)

IE=44.09 OUT (SE)

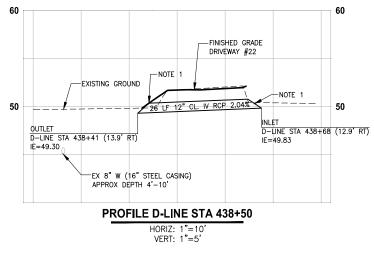

CONFORMED DRAWINGS

-FINISHED GRADE ____EXISTING GROUND

76 LF 6" UD 1.61%

CO #73A CLEANOUT

HORIZ: 1"=10' VERT: 1"=5'

IE=45.48 OUT (S)

C-LINE STA 433+70 (7.0' RT) RIM EL=47.89 IE=45.48 N (N)

11/15/21

Parametrix Engineering, Planning, Environmental sciences
719 2ND AVENUE, SUITE 200 SEATTLE, WA 98104 P 206.394.3700 WWW.PARAMETRIX.COM



$ \land$	REVISIONS	DATE	BY	DESIGNED C. BUITRAGO	
1	ADDENDUM 2	11/15/21	DP	DRAWN	ONE INCH AT FULL SCALE. IF NOT, SCALE ACCORDINGLY
				B. PURGANAN CHECKED	FILE NAME BL1521075P19T03SD-02
				Ү. НО	JOB No. 554-1521-075 P19 T03
				APPROVED J. BAILEY	DATE JUNE 2021

GENERAL NOTES:

1. CULVERTS IN FILL OR CUT SLOPES SHALL HAVE BEVELED END SECTIONS PER 2016 KCRS FIG. 7-001. 2. STRUCTURE OFFSETS ARE MEASURED TO CENTER OF GRATE.

3. CATCH BASIN TYPE 1 SHALL BE PER 2016 KCRS FIG. 7-003.

4. CATCH BASIN TYPE 2 SHALL BE PER 2016 KCRS FIG. 7-005 AND FIG. 7-006.

CIRCULAR FRAME (RING) AND LOCKING COVER SHALL BE PER 2016 KCRS FIG. 7-022, AND FIG. 7-023.

6. RECTANGULAR LOCKING SOLID METAL COVER SHALL BE PER 2016 KCRS FIG. 7-014 AND FIG. 7-015. 7. CL IV RCP = CLASS IV REINFORCED CONCRETE STORM SEWER PIPE OR CULVERT.

8. HDPE = HIGH DENSITY POLYETHYLENE PIPE SHALL BE PER WSDOT SPECIFICATION 9-05.23.

9. RECTANGULAR VANED GRATES SHALL BE PER 2016 KCRS FIG. 7-018.

10. SSP = STORM SEWER PIPE. ALL SSP SHALL BE POLYPROPYLENE PER WSDOT SPECIFICATION 9-05.24.

11. CONTRACTOR TO INSTALL ALL STORM SEWER, DRAIN, AND CULVERT PIPE PER WSDOT SPECIFICATION 7-08. SEE SHEET DD2 FOR TRENCH DETAIL.

12. CONCRETE COLLAR SHALL BE PER WSDOT STANDARD PLAN B-60.20-02.


13. DEBRIS CAGE SHALL BE PER 2016 KCRS FIG. 7-028.

14. UD = UNDERDRAIN TRENCH, UNDERDRAIN PIPE UP TO 8" IN DIAMETER SHALL BE PERFORATED PVC PIPE AND UNDERDRAIN PIPE 10" IN DIAMETER SHALL BE PERFORATED CORRUGATED POLYETHYLENE PIPE PER WSDOT SPECIFICATIONS 9-05.2(6) AND 9-05.2(7). UNDERDRAIN PIPES ARE SET AT 0.5% SLOPE AVERAGE, CALCULATED PIPE SLOPES BETWEEN CLEANOUTS WAY VARY SLIGHTLY.


15. SPACING BETWEEN EXISTING UTILITY AND NEW STORM STRUCTURE/PIPE SHALL BE 6" MINIMUM. PLACE POLYETHYLENE PAD OF 2' LENGTH & WIDTH BETWEEN UTILITIES.

16. PIPE JOINTS FOR NEW STORM DRAINS AND CULVERTS SHALL BE LOCATED OUTSIDE OF PAVED TRAIL. 17. ALL DRAIN PIPE SHALL SHALL BE PVC PER WSDOT SPECIFICATION 9-05.1(5).

ASE 2 STORM DRAIN PR ASE 2 AND SECTIO Addendum		NS	SD2	
			SHEET NO. 77 OF 213	
City of been o respor	amish No. C17-0921 JCC and King County vs. Sammamish No. 17-2-29922-7 SEA and have eemed ACCEPTABLE. The reviewer accepts no sibility for any errors and/or omissions made by parer of these drawings. 17 February 2022	City Engineer	Date	
with C Storm the rec Agree	CITY OF SAMMAMISH PUBLIC WORKS DEVELOPMENT REVIEW drawings have been reviewed for compliance ty of Sammamish Clearing and Grading and vater requirements and also in accordance with uirements as established in the Settlement nent between King County vs. City of	CITY OF SAMMAMISH	APPROVAL	

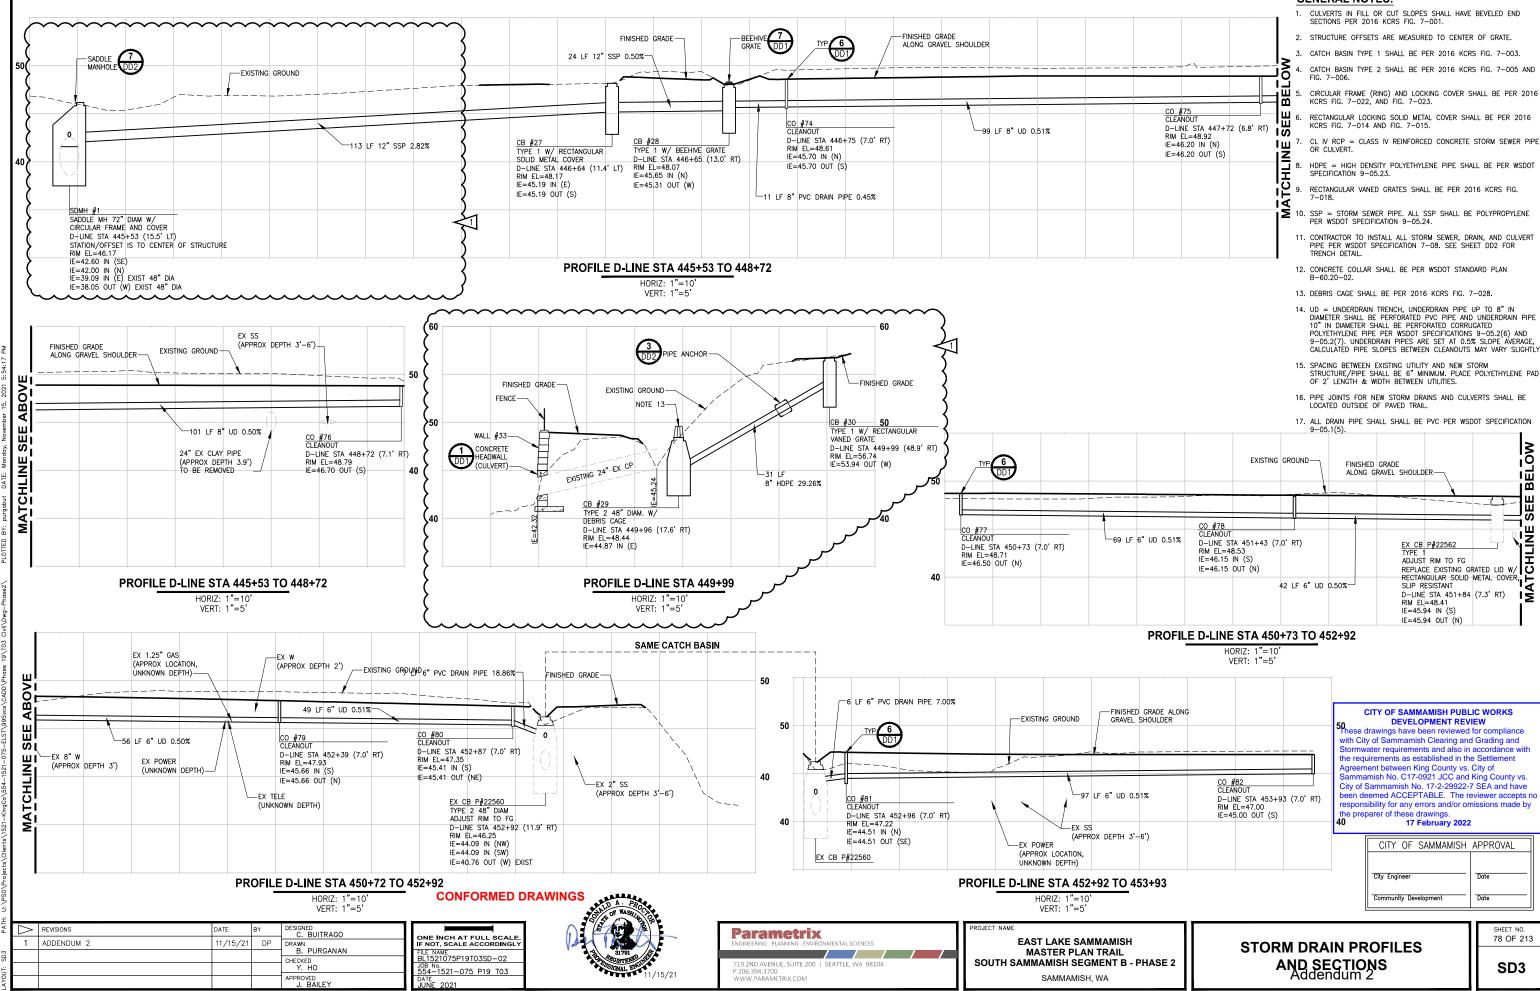


GENERAL NOTES:

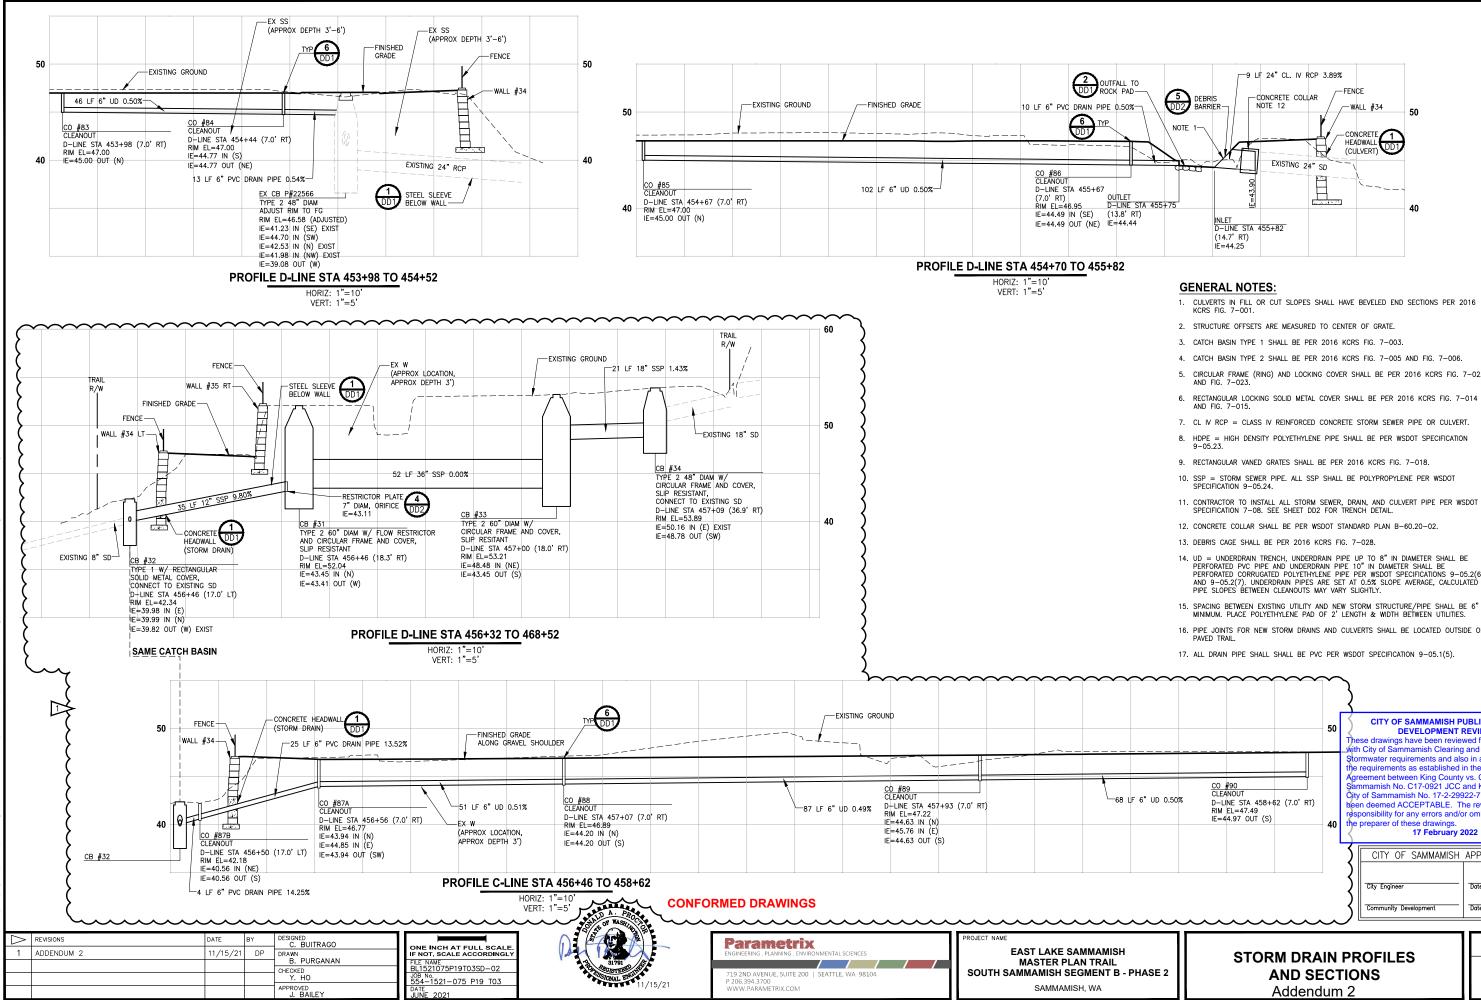



- 4. CATCH BASIN TYPE 2 SHALL BE PER 2016 KCRS FIG. 7-005 AND FIG. 7-006.
- 5. CIRCULAR FRAME (RING) AND LOCKING COVER SHALL BE PER 2016 KCRS FIG. 7-022,
- 6. RECTANGULAR LOCKING SOLID METAL COVER SHALL BE PER 2016 KCRS FIG. 7-014
- 8. HDPE = HIGH DENSITY POLYETHYLENE PIPE SHALL BE PER WSDOT SPECIFICATION
- SSP = STORM SEWER PIPE. ALL SSP SHALL BE POLYPROPYLENE PER WSDOT SPECIFICATION 9-05.24.
- 11. CONTRACTOR TO INSTALL ALL STORM SEWER, DRAIN, AND CULVERT PIPE PER WSDOT SPECIFICATION 7-08. SEE SHEET DD2 FOR TRENCH DETAIL.

- 14. UD = UNDERDRAIN TRENCH, UNDERDRAIN PIPE UP TO 8" IN DIAMETER SHALL BE PERFORATED PVC PIPE AND UNDERDRAIN PIPE 10" IN DIAMETER SHALL BE PERFORATED CORRUGATED POLYETHYLENE PIPE PER WSDOT SPECIFICATIONS 9-05.2(6) AND 9-05.2(7). UNDERDRAIN PIPES ARE SET AT 0.5% SLOPE AVERAGE, CALCULATED
- MINIMUM. PLACE POLYETHYLENE PAD OF 2' LENGTH & WIDTH BETWEEN UTILITIES.
- 16. PIPE JOINTS FOR NEW STORM DRAINS AND CULVERTS SHALL BE LOCATED OUTSIDE OF

RIM EL=47.97 OUT (S) 40 the prepared of these drawings.	IE=44.97 OUT (S)	 		17 February 2022 CITY_OF_SAMMAMISH_APPROVAL City_Engineer Community_Development Date
RIM EL=47.49 IE=44.97 OUT (S) 40 the preparer of these drawings. 17 February 2022	LF 6" UD 0.50% CO #90 CLEANOUT D-LINE STA 458+62 (7.0' RT) RIM EL=47.49 IE=44.97 OUT (S) Stormwater requirements and also in accordance with the requirements as established in the Settlement Agreement between King County vs. City of Sammamish No. C17-0921 JCC and King County vs. Oty of Sammamish No. 17-0921 JCC and King County vs. Oty of Sammamish No. 17-29922-7 SEA and have been deemed ACCEPTABLE. The reviewer accepts no responsibility for any errors and/or omissions made by the preparer of these drawings. 17 February 2022)
	Stormwater requirements and also in accordance with the requirements as established in the Settlement Agreement between King County vs. City of Sammamish No. C17-0921 JCC and King County vs. CiteANOUT C0 #90 CLEANOUT County cou	RIM EL=47.49	40	responsibility for any errors and/or omissions made by the preparer of these drawings. 17 February 2022

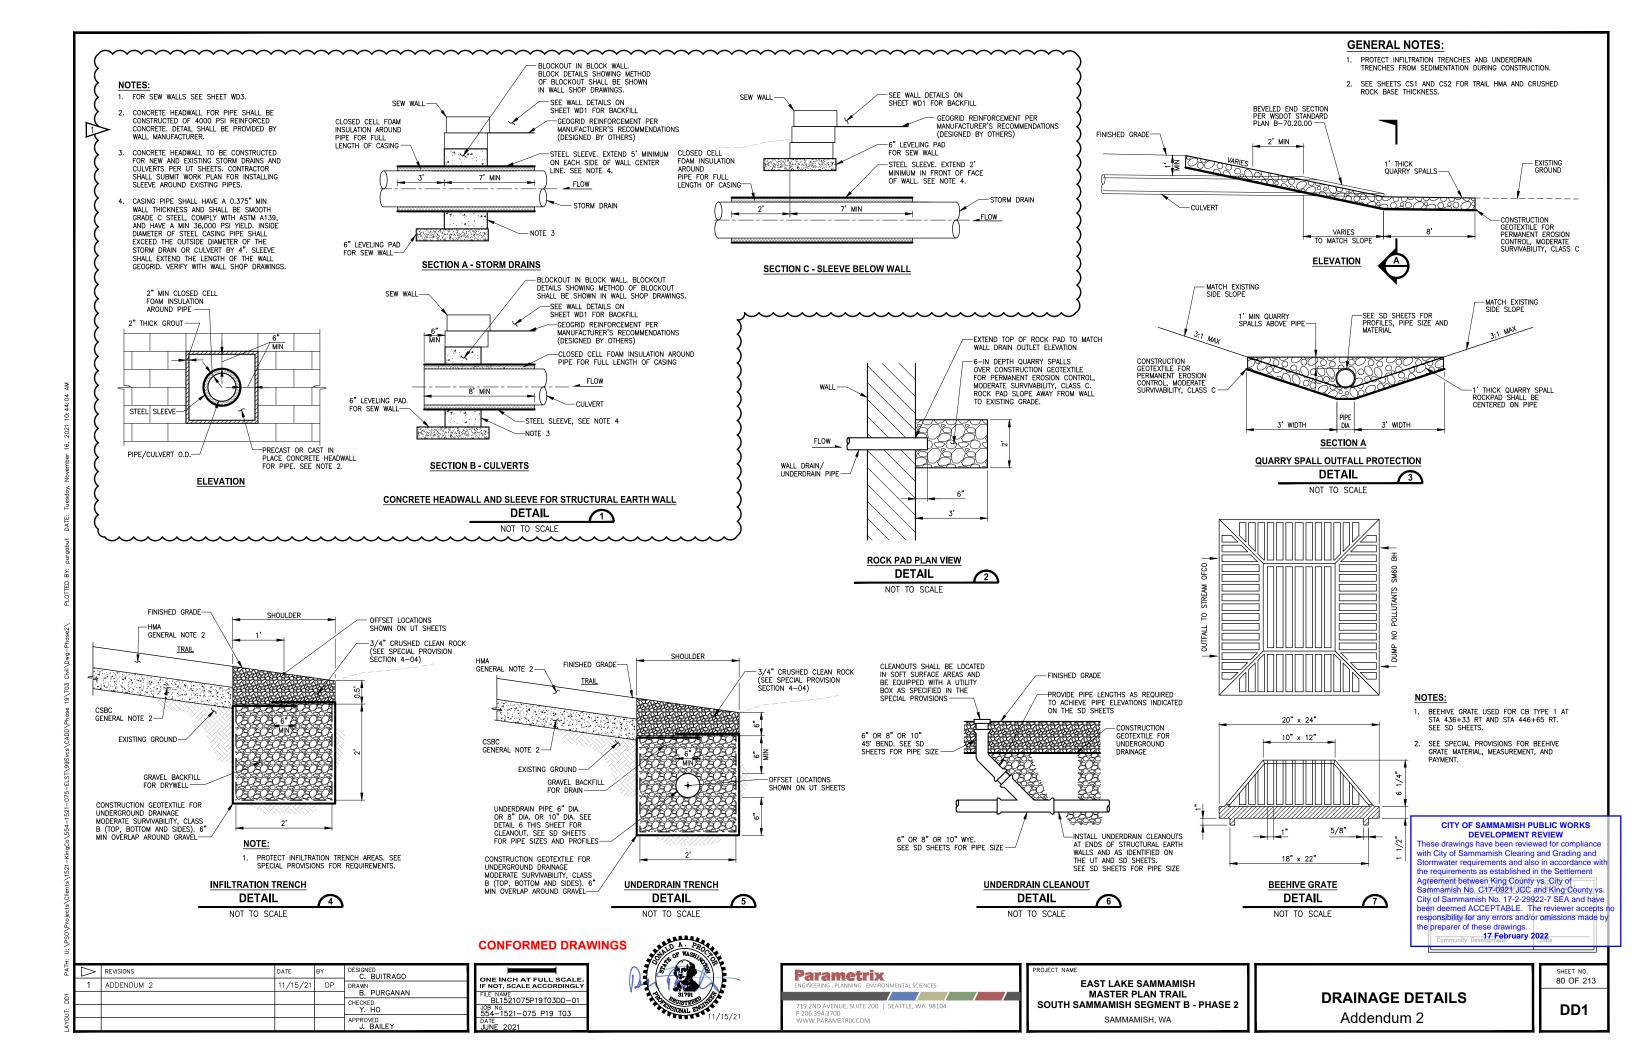

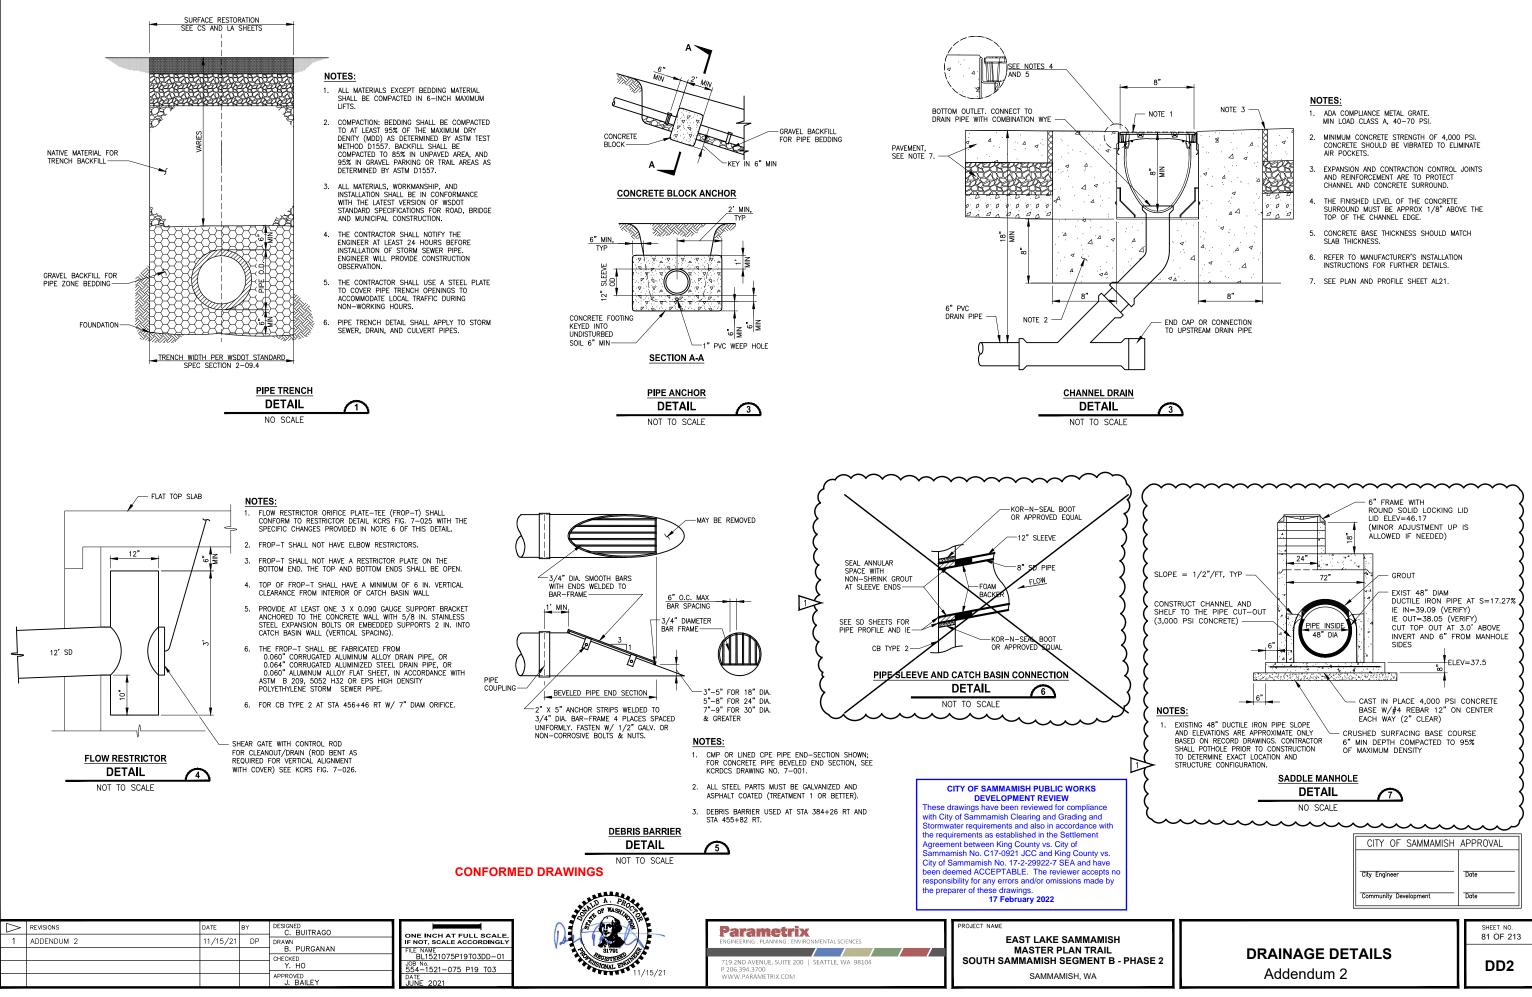

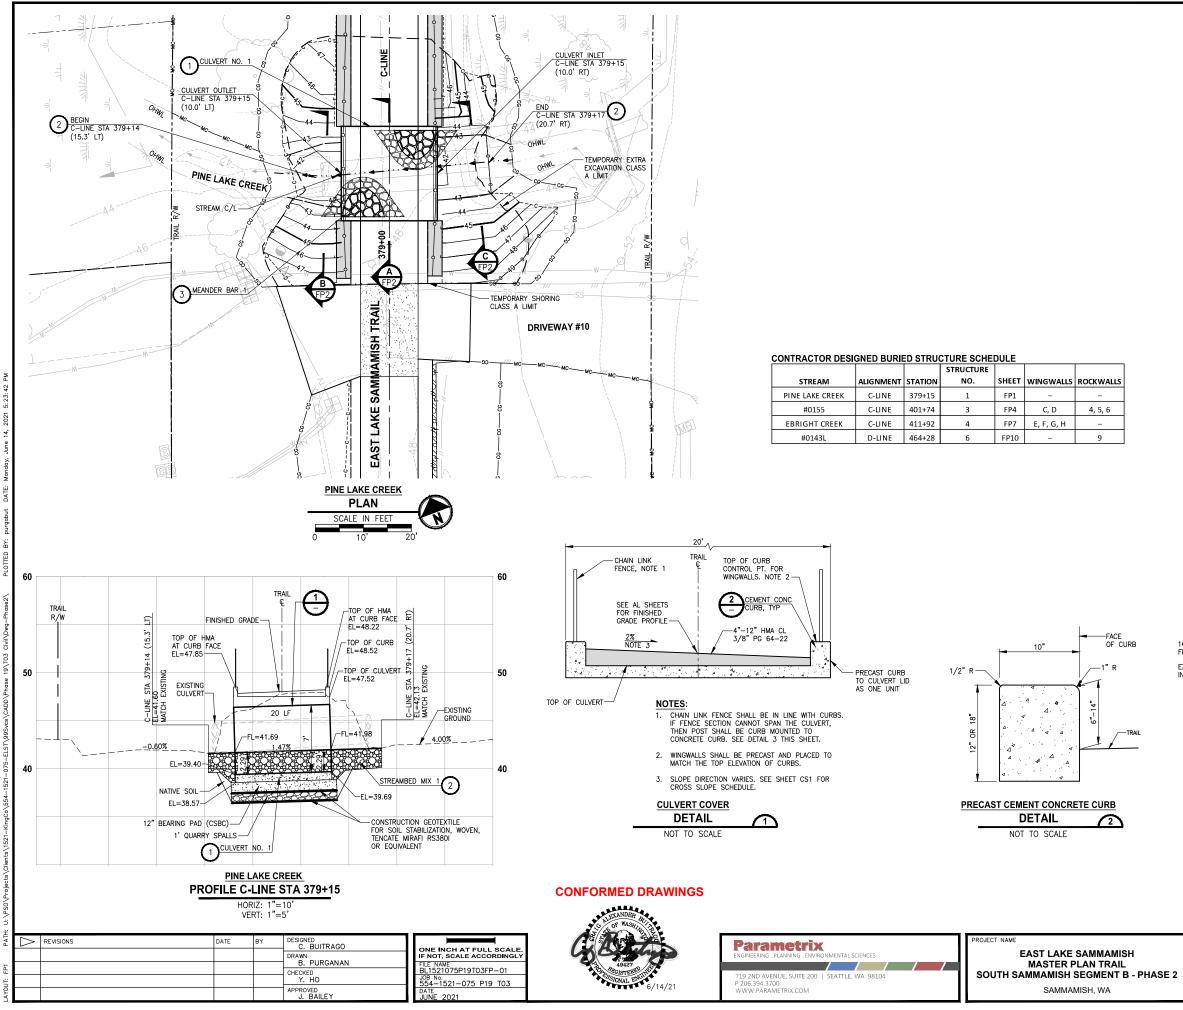

SAMMAMISH. WA

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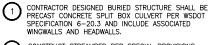
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9

-FACE

OF CURB

STREAM CONSTRUCTION NOTES:





CONSTRUCT STREAMBED PER SPECIAL PROVISIONS SECTION 8-32. SEE SHEET FP2 FOR STREAMBED MIX AND CHANNEL SECTION DETAILS.


(3) MEANDER BAR, PER SPECIAL PROVISIONS SECTION 8-32. SEE SHEET FP3 FOR DETAILS.


GENERAL NOTES:


- 1. CONSTRUCTION ACTIVITY FOR CULVERTS SHALL NOT OCCUR UNTIL AFTER STRUCTURAL ENGINEERING APPROVAL IS OBTAINED.
- BOX CULVERTS AND STREAM WORK BELOW ORDINARY HIGH WATER LINE SHALL ONLY OCCUR BETWEEN JULY 1 AND SEPTEMBER 30 PER HPA APPROVAL CONDITIONS IN APPENDIX A OF THE SPECIAL PROVISIONS

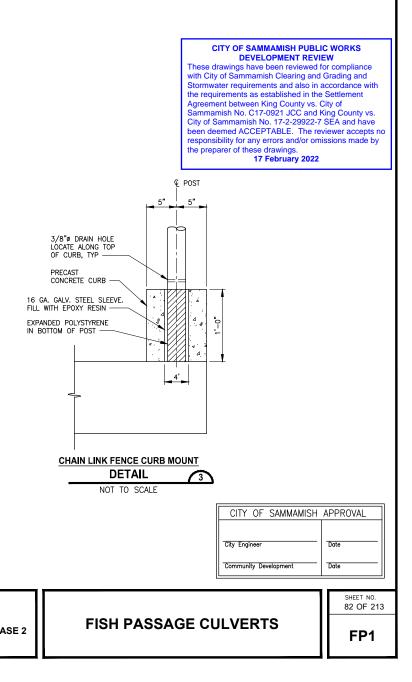


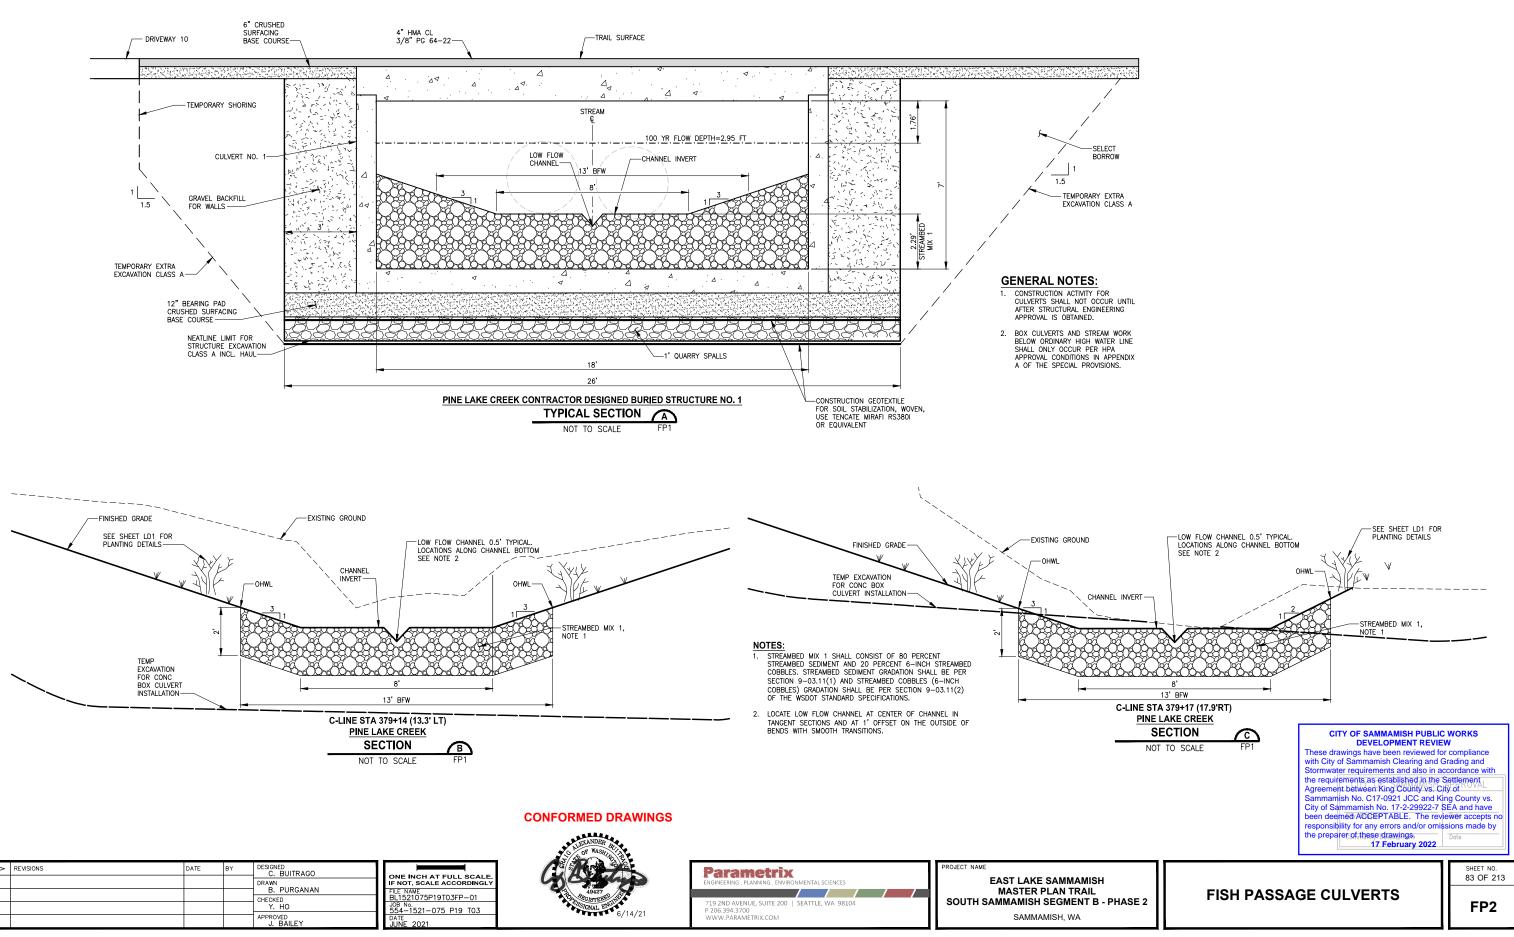


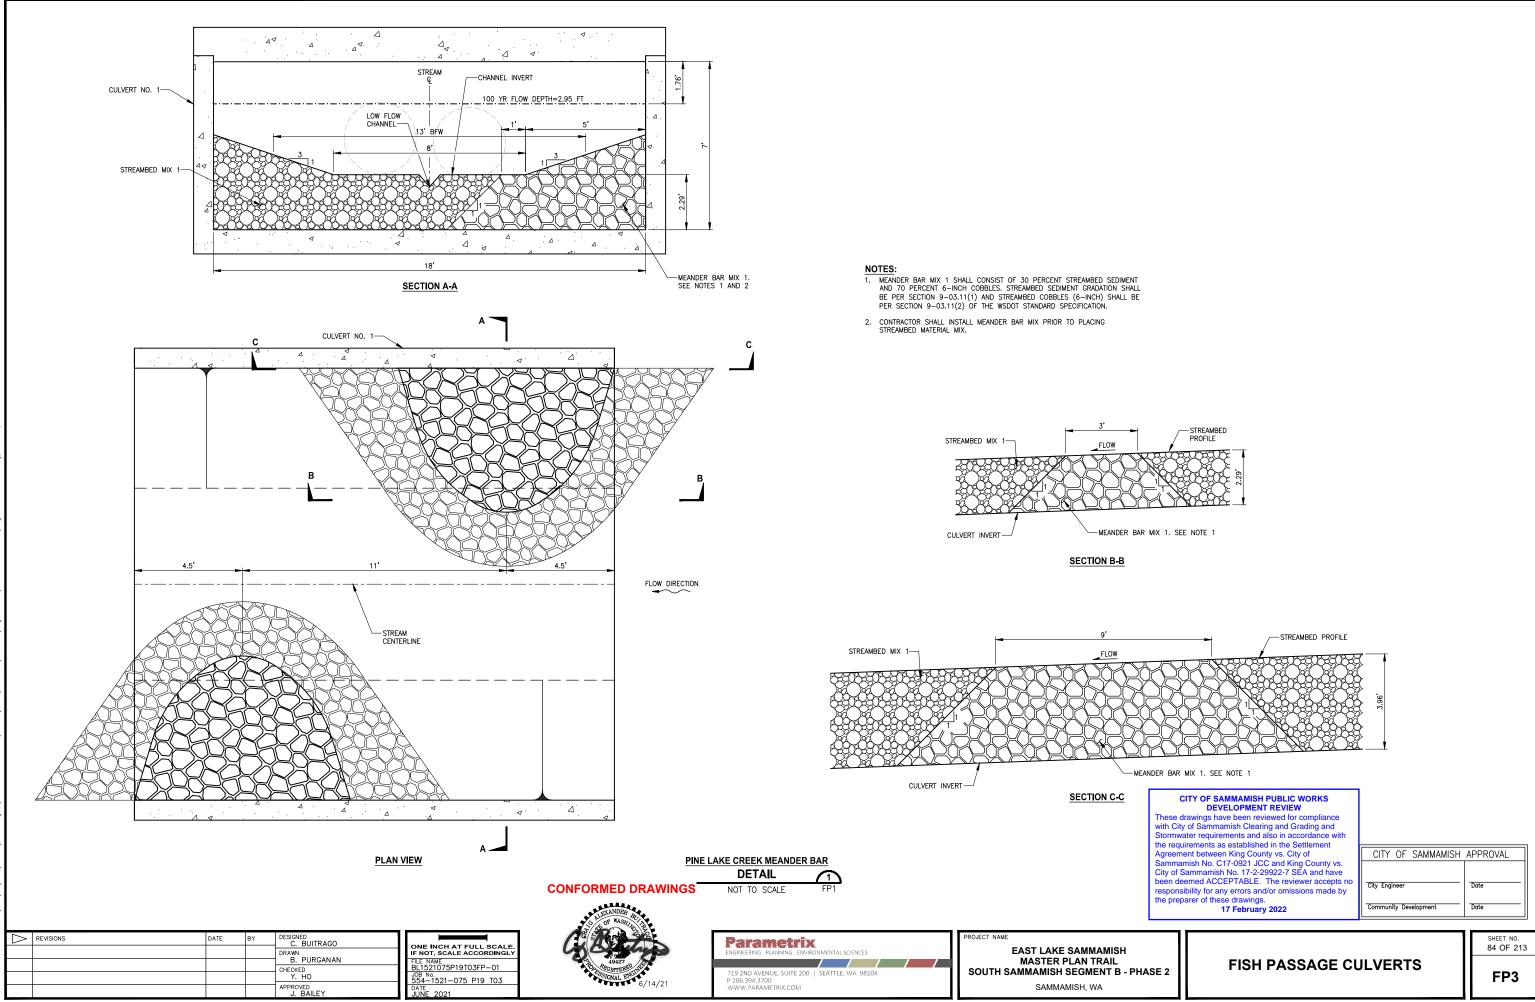

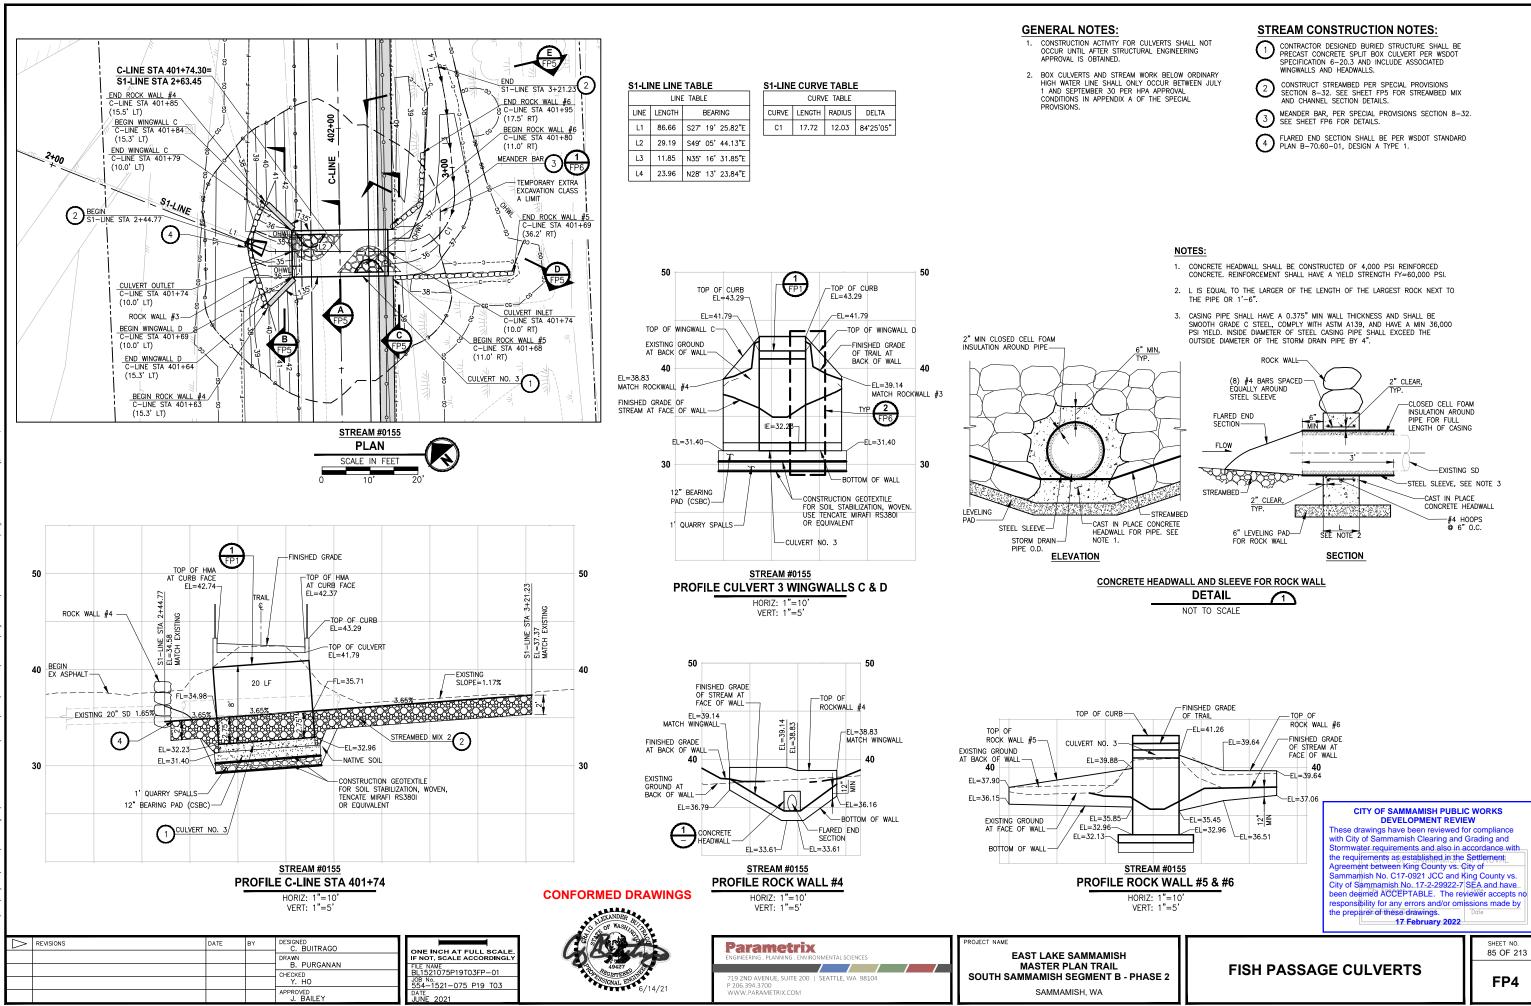


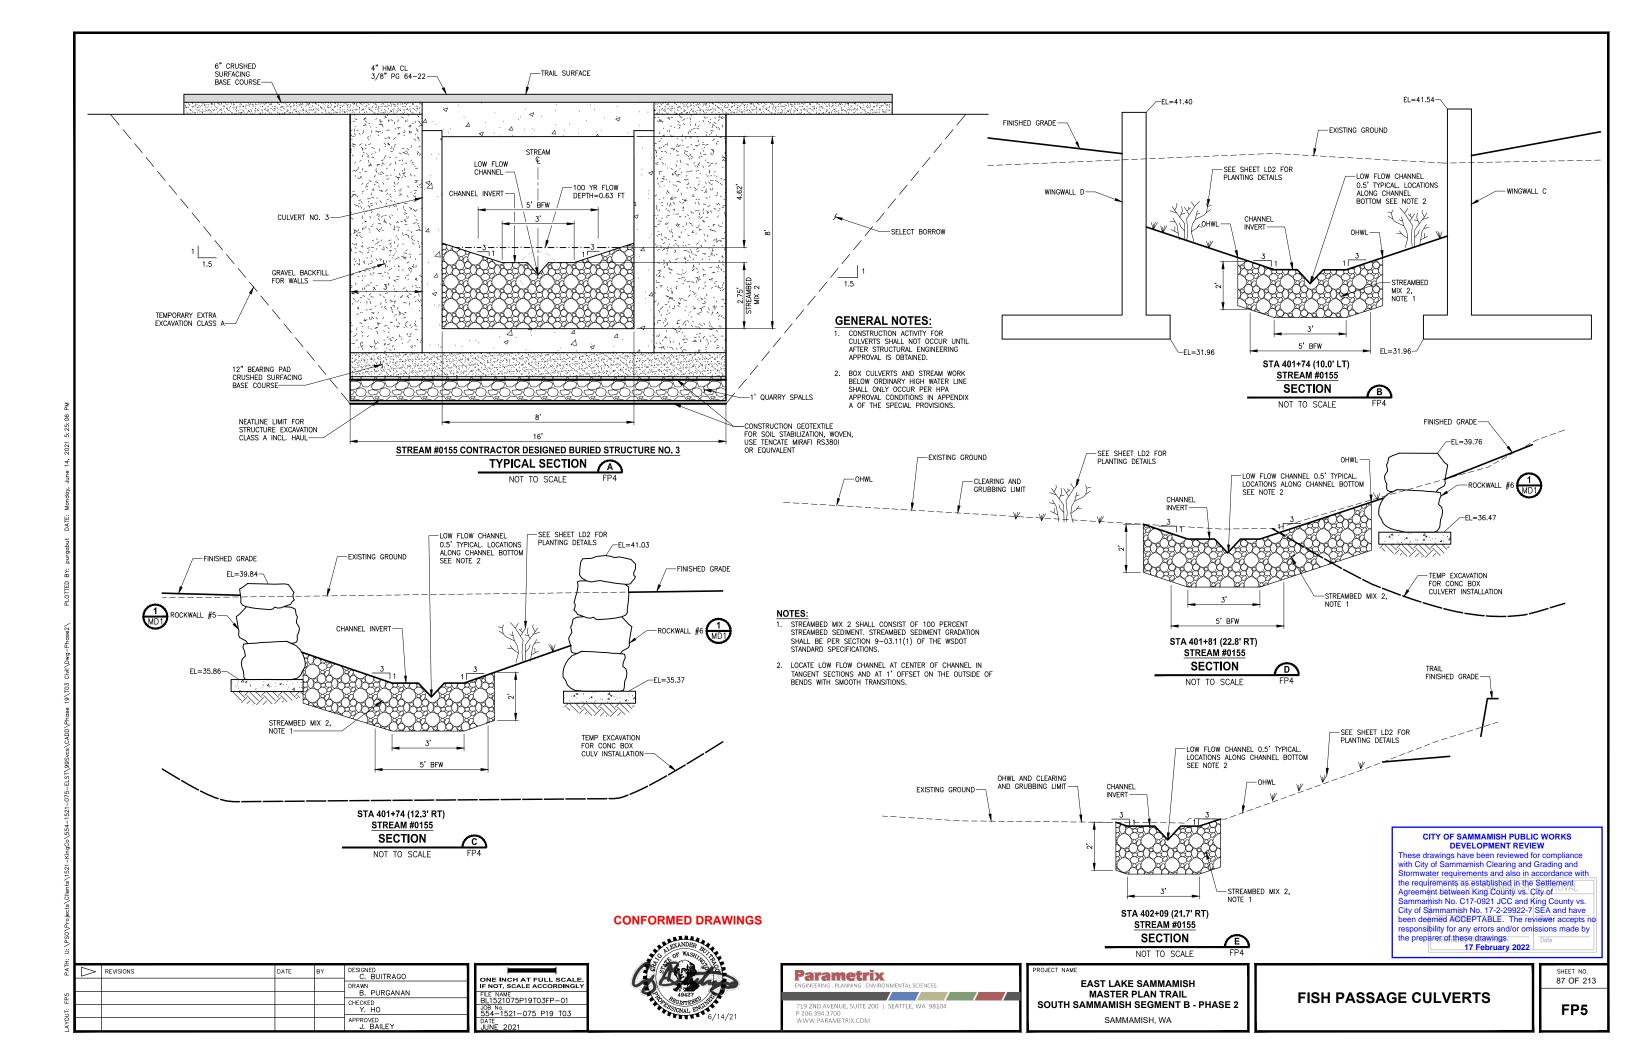


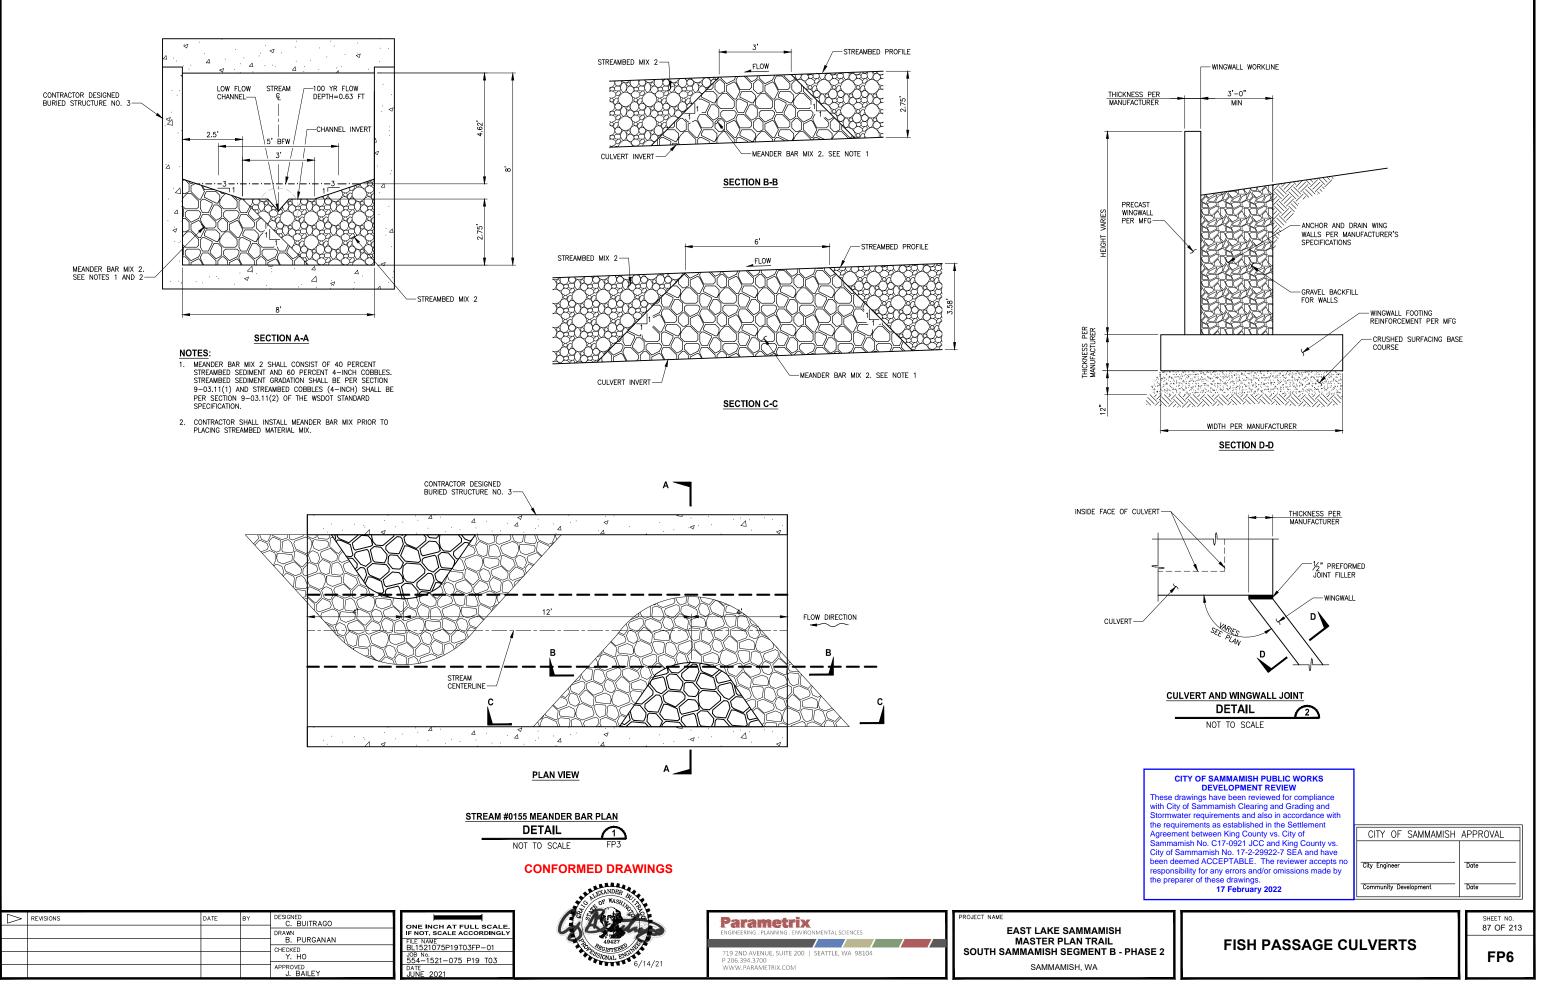

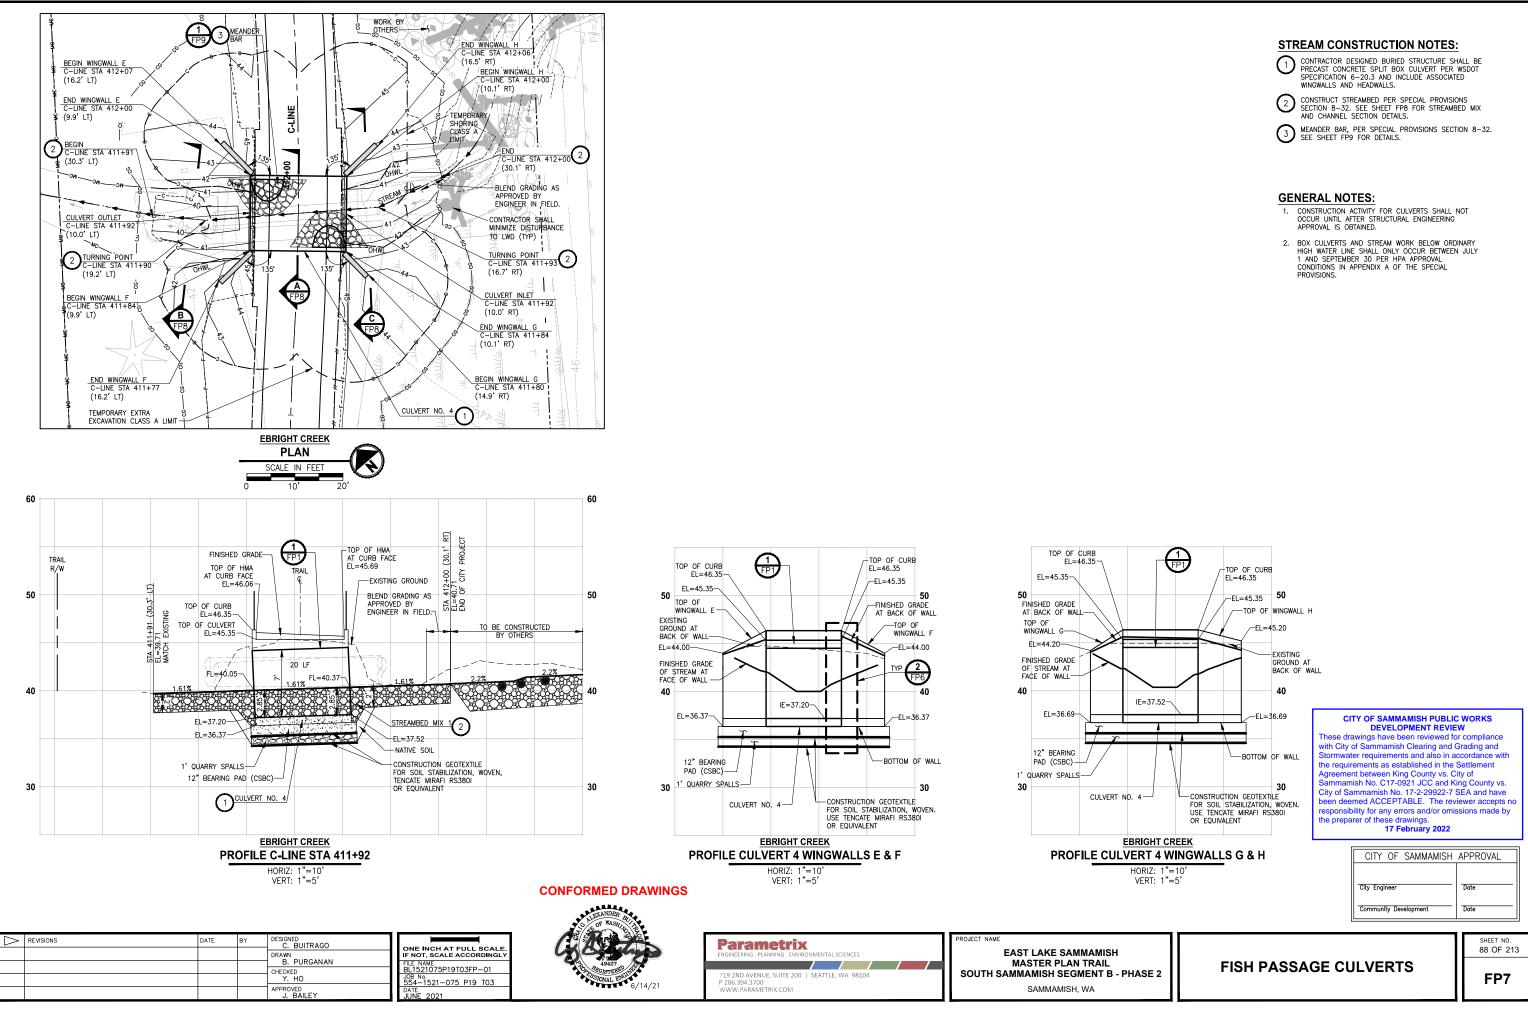


1	CONTRACTOR DESIGNED BURIED STRUCTURE SHALL BE PRECAST CONCRETE SPLIT BOX CULVERT PER WSDOT SPECIFICATION 6-20.3 AND INCLUDE ASSOCIATED WINGWALLS AND HEADWALLS.

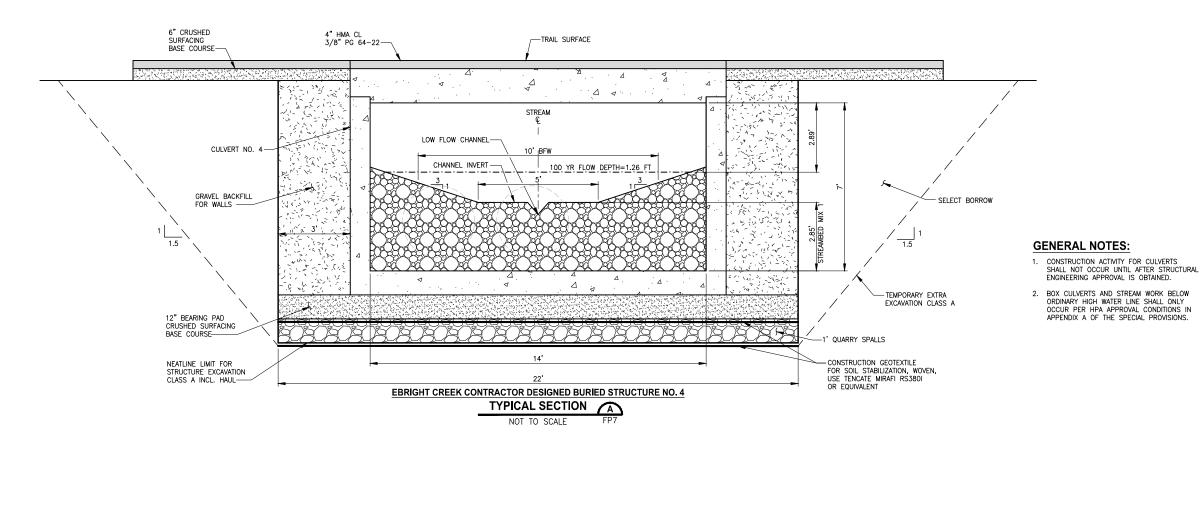


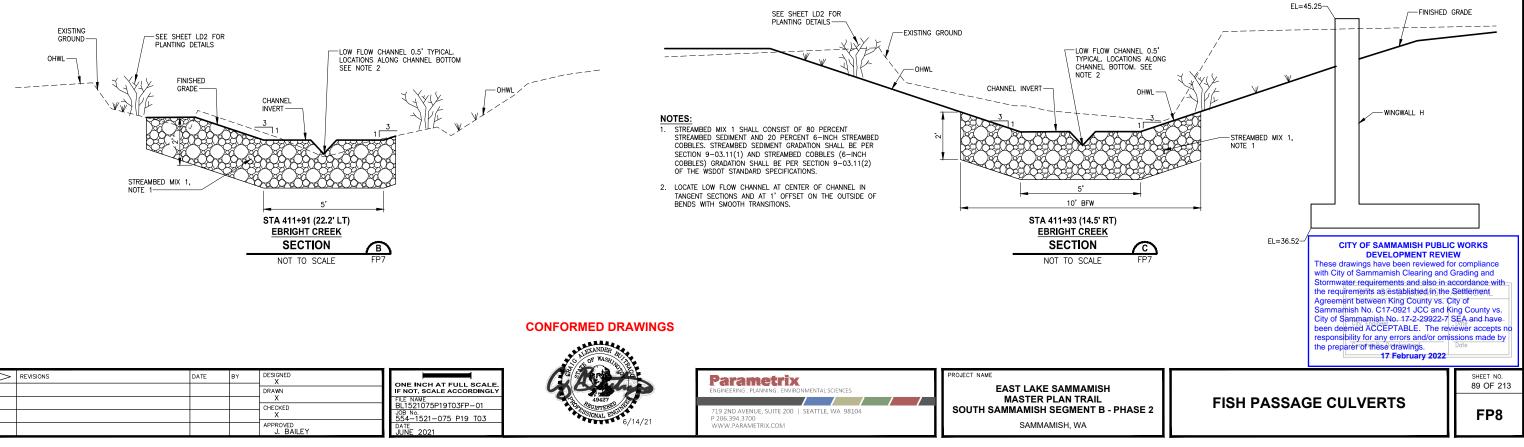

ΡΑΤ	\supset	REVISIONS	DATE	BY	DESIGNED X	
					DRAWN	ONE INCH AT FULL SCALE. IF NOT, SCALE ACCORDINGLY
FP8					X CHECKED	FILE NAME BL1521075P19T03FP-01
OUT:					Х	JOB No. 554-1521-075 P19 T03
LΑYO					APPROVED J. BAILEY	DATE JUNE 2021

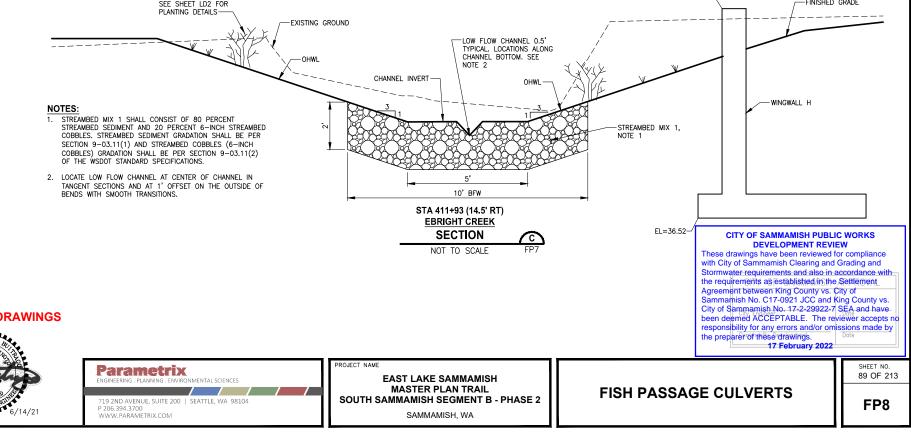

ORDINARY HIGH WATER LINE SHALL ONLY OCCUR PER HPA APPROVAL CONDITIONS IN APPENDIX A OF THE SPECIAL PROVISIONS.

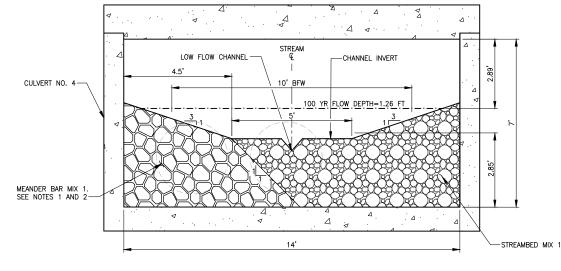


SECTION A-A



NOTES.

 MEANDER BAR MIX 1 SHALL CONSIST OF 30 PERCENT STREAMBED SEDIMENT AND 70 PERCENT 6-INCH COBBLES. STREAMBED SEDIMENT GRADATION SHALL BE PER SECTION 9-03.11(1) AND STREAMBED COBBLES (6-INCH) SHALL BE PER SECTION 9-03.11(2) OF THE WSDOT STANDARD SPECIFICATION.

2. CONTRACTOR SHALL INSTALL MEANDER BAR MIX PRIOR TO PLACING STREAMBED MATERIAL MIX.

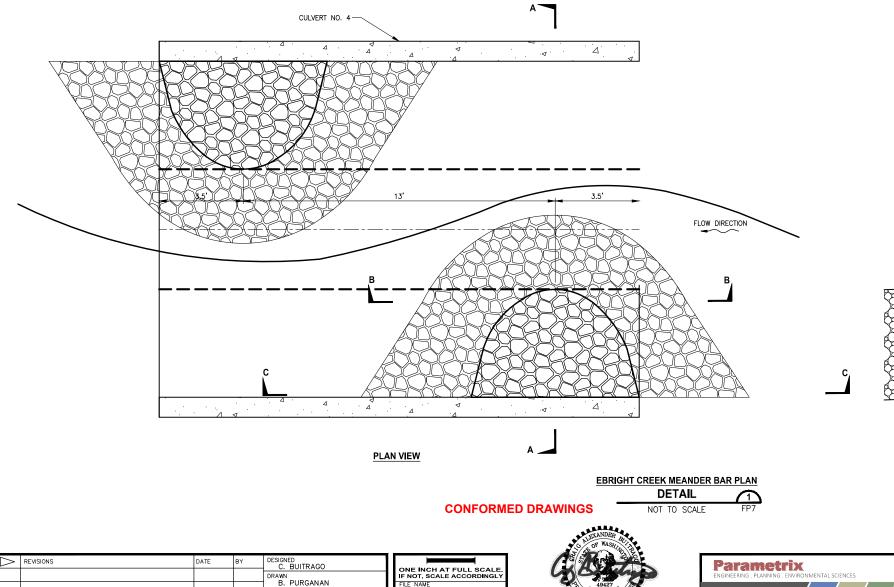


FILE NAME BL1521075P19T03FP-01 JOB No. 554-1521-075 P19 T03


2021

6/14/21


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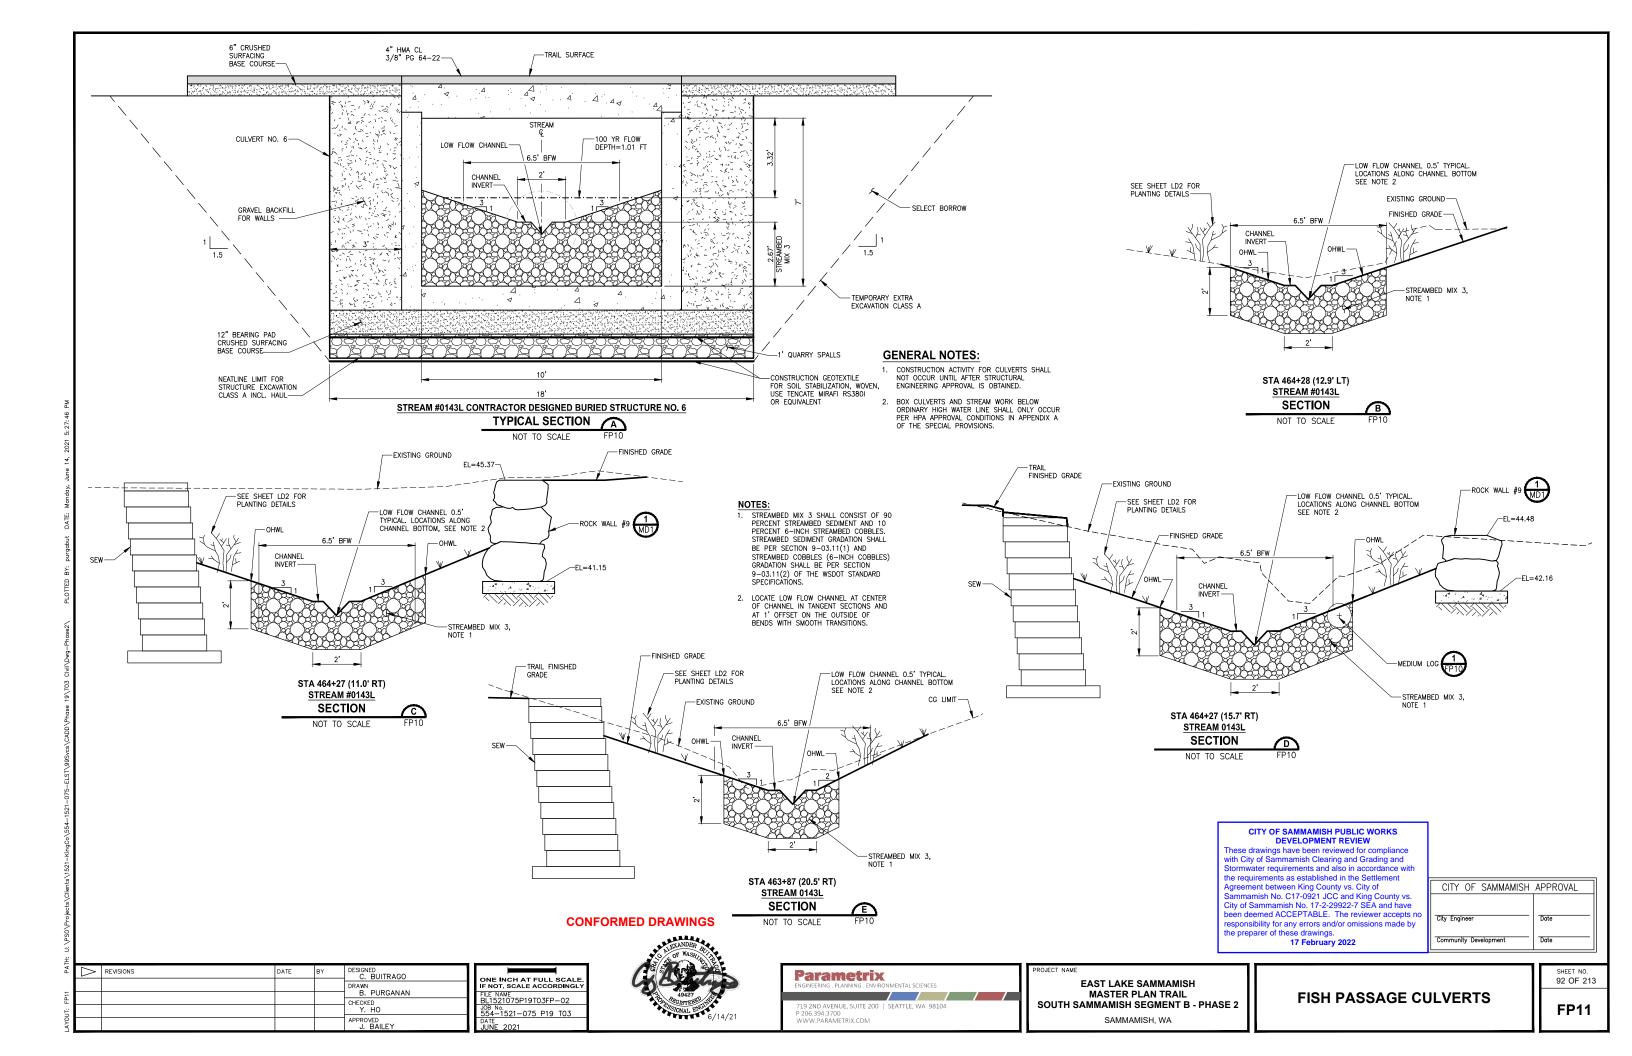
APPROVED




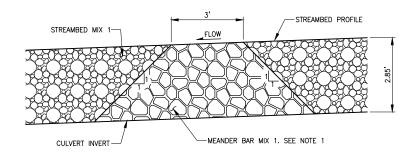


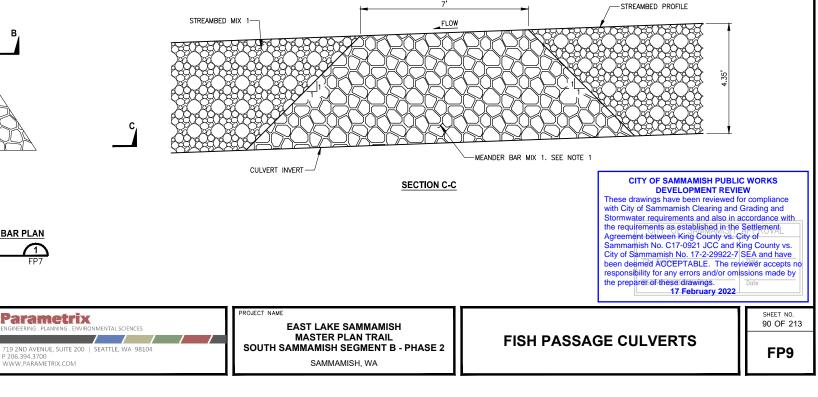SECTION B-B




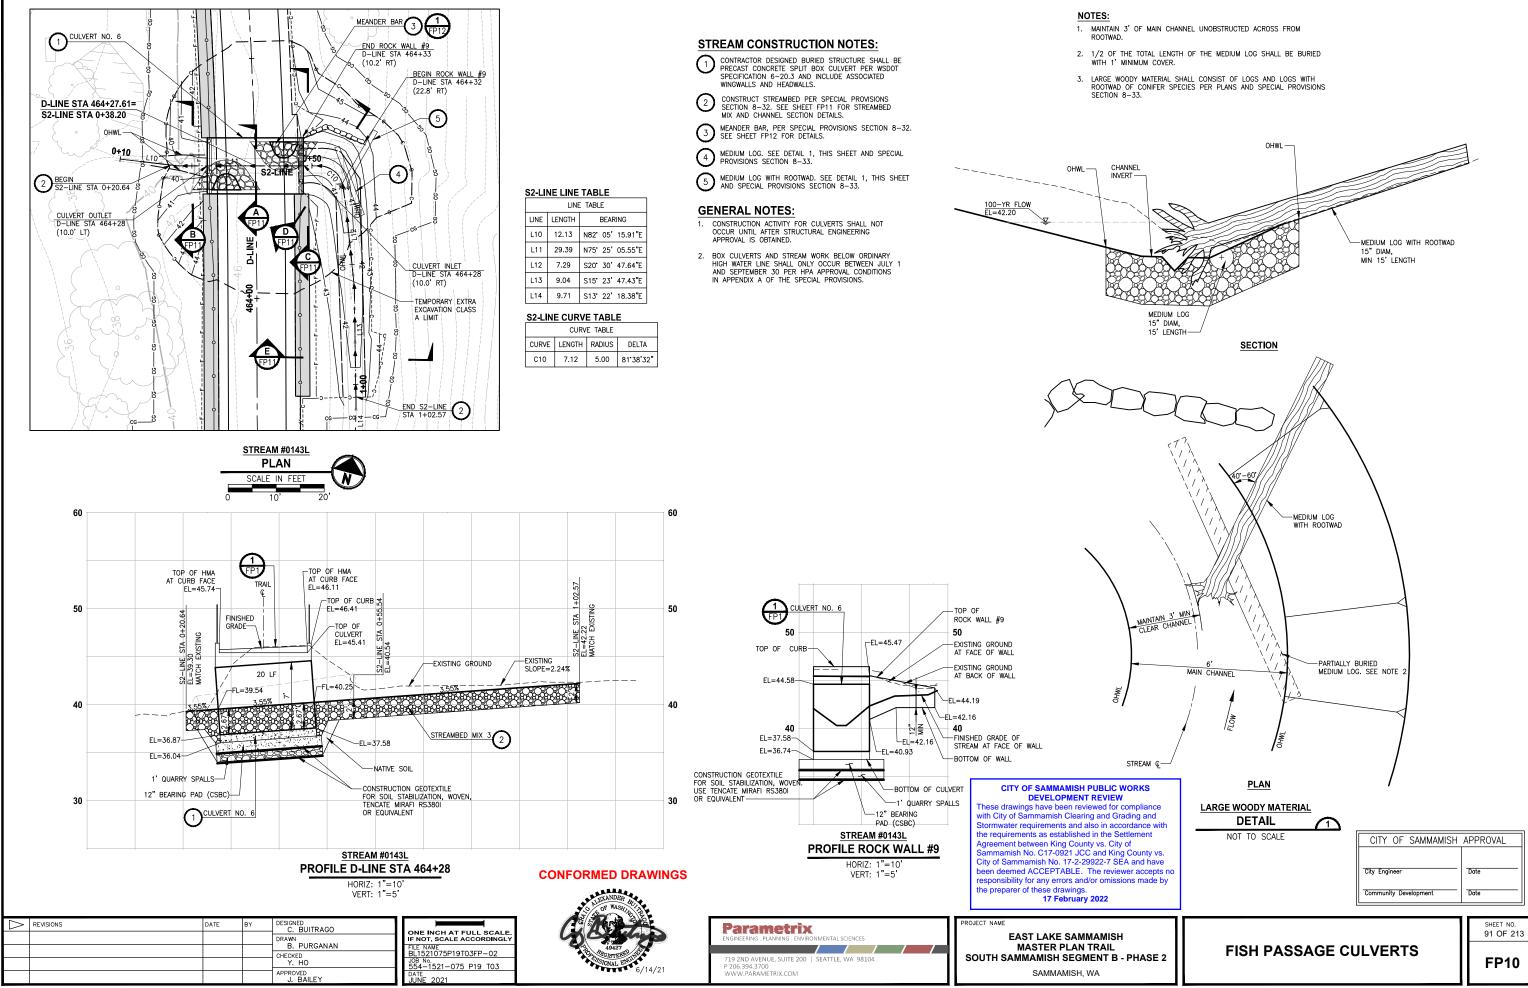


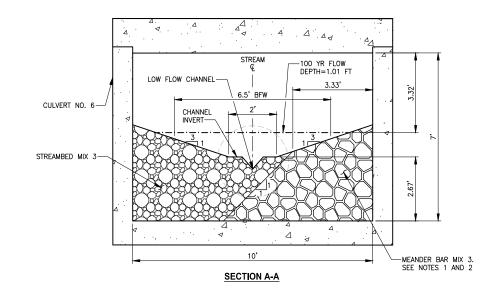

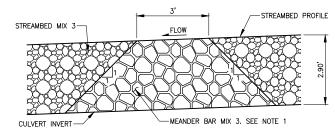

SECTION B-B

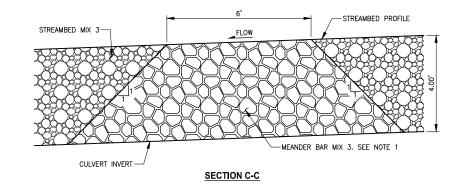

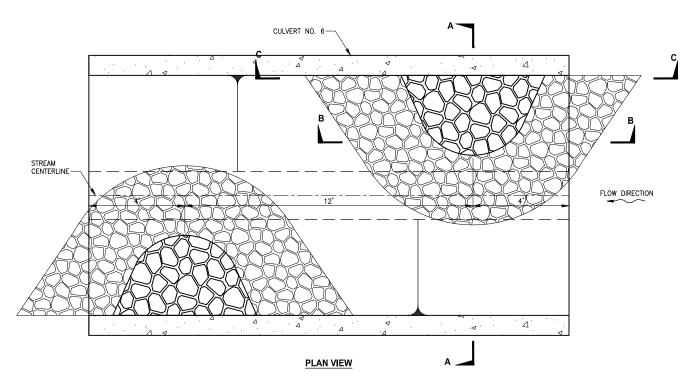

NOTES:

MEANDER BAR MIX 3 SHALL CONSIST OF 50 PERCENT STREAMBED SEDIMENT AND 50 PERCENT 6-INCH COBBLES. STREAMBED SEDIMENT GRADATION SHALL BE PER SECTION 9-03.11(1) AND STREAMBED COBBLES (6-INCH) SHALL BE PER SECTION 9-03.11(2) OF THE WSDOT STANDARD SPECIFICATION.

2. CONTRACTOR SHALL INSTALL MEANDER BAR MIX PRIOR TO PLACING STREAMBED MATERIAL MIX.

STREAM #0143L MEANDER BAR PLAN DETAIL \frown NOT TO SCALE FP10

CONFORMED DRAWINGS

ANADER ANADER
6/14/21

	PROJECT
719 2ND AVENUE, SUITE 200 SEATTLE, WA 98104 P 206.394.3700 WWW.PARAMETRIX.COM	SOU

CT NAME EAST LAKE SAMMAMISH MASTER PLAN TRAIL DUTH SAMMAMISH SEGMENT B - PI SAMMAMISH, WA

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>	REVISIONS	DATE	BY	DESIGNED C. BUITRAGO	
				DRAWN	ONE INCH AT FULL SCALE. IF NOT, SCALE ACCORDINGLY
				B. PURGANAN CHECKED	FILE NAME BL1521075P19T03FP-02
				Y. HO	JOB No. 554-1521-075 P19 T03
				APPROVED J. BAILEY	DATE JUNE 2021

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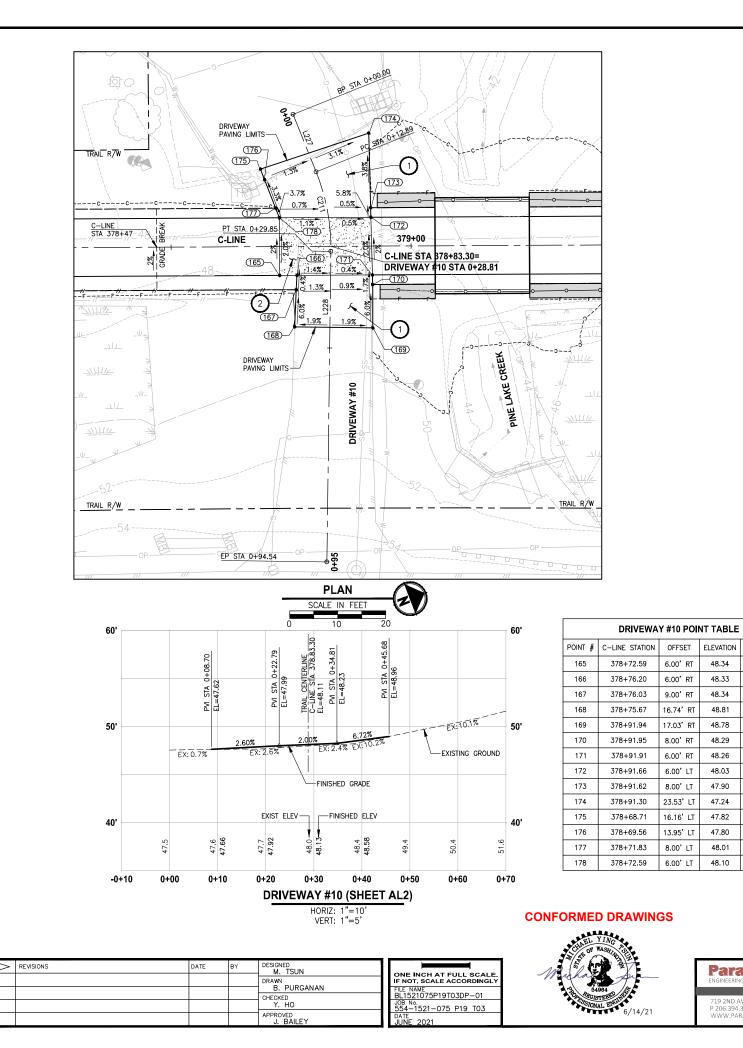
SHEET NO. 93 OF 213

FISH PASSAGE CULVERTS

City Engineer	Date
Community Development	Date

CITY OF SAMMAMISH APPROVAL

CITY OF SAMMAMISH PUBLIC WORKS DEVELOPMENT REVIEW These drawings have been reviewed for compliance with City of Sammamish Clearing and Grading and Stormwater requirements and also in accordance with the requirements as established in the Settlement Agreement between King County vs. City of Sammamish No. C17-0921 JCC and King County vs. City of Sammamish No. 17-229922-7 SEA and have been deemed ACCEPTABLE. The reviewer accepts no responsibility for any errors and/or omissions made by the preparer of these drawings. 17 February 2022



48.33	CONC-ASPH											
48.34	GRADE BREAK											
48.81	ME-ASPH											
48.78	ME-ASPH											
48.29	AP-ASPH											
48.26	CONC-ASPH					DRIV	'EWAY #1	0 LIN	IE TABLE			
48.03	CONC-ASPH	LINE	LENGTH	BEARIN	IG	BEGI	N EASTING	BEGI	N NORTHING	END	EASTING	E
47.90	GRADE BREAK	L227	12.89	N89°03'	24"E	133	32841.62	2	21649.67	133	2854.50	Γ
47.24	ASPH-GRAVEL	L228	64.69	S68 23'	38"E	133	32871.08	2	21646.86	133	2931.23	
47.82	ASPH-GRAVEL											_
47.80	GRADE BREAK					DR	VEWAY #	10 C	URVE TAB	LE		
48.01	GRADE BREAK	CURVE	LENGTH	RADIUS	DEI	TA	BEGIN EAS	STING	BEGIN NORT	HING	END EAS	STI

ELEVATION DESCRIPTION

48.10 CONC-ASPH

Parametrix

719 2ND AVENUE, SUITE 200 | SEATTLE, WA 98104 P 206.394.3700 WWW.PARAMETRIX.COM

CONC-ASPH

48.34

PROJECT NAM EAST LAKE SAMMAMISH MASTER PLAN TRAIL SOUTH SAMMAMISH SEGMENT B - P SAMMAMISH, WA

PHASE	2
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DRIVEWAY PLAN AND PROFILE

DP1

CITY OF SAMMAMISH PUBLIC WORKS DEVELOPMENT REVIEW These drawings have been reviewed for compliance with City of Sammamish Clearing and Grading and

with City of Sammamish Clearing and Grading and Stormwater requirements and also in accordance with the requirements as established in the Settlement. Agreement between King County vs. City of Sammamish No. C17-0921 JCC and King County vs.

City of Sammanish No. 17-2-29922-7 SEA and have been deemed ACCEPTABLE. The reviewer accepts no

the preparer of these drawings! Dote 17 February 2022



HING END EASTING END NORTHING
 C211
 16.96
 43.10
 22'32'58"
 1332854.50
 221649.88
 1332871.08
 221646.86

1332931.23 221623.04

END EASTING END NORTHING 221649.88

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LEGEND:

GRAVEL DRIVEWAY






CONSTRUCTION NOTES:



PATTERNED CONCRETE DRIVEWAY

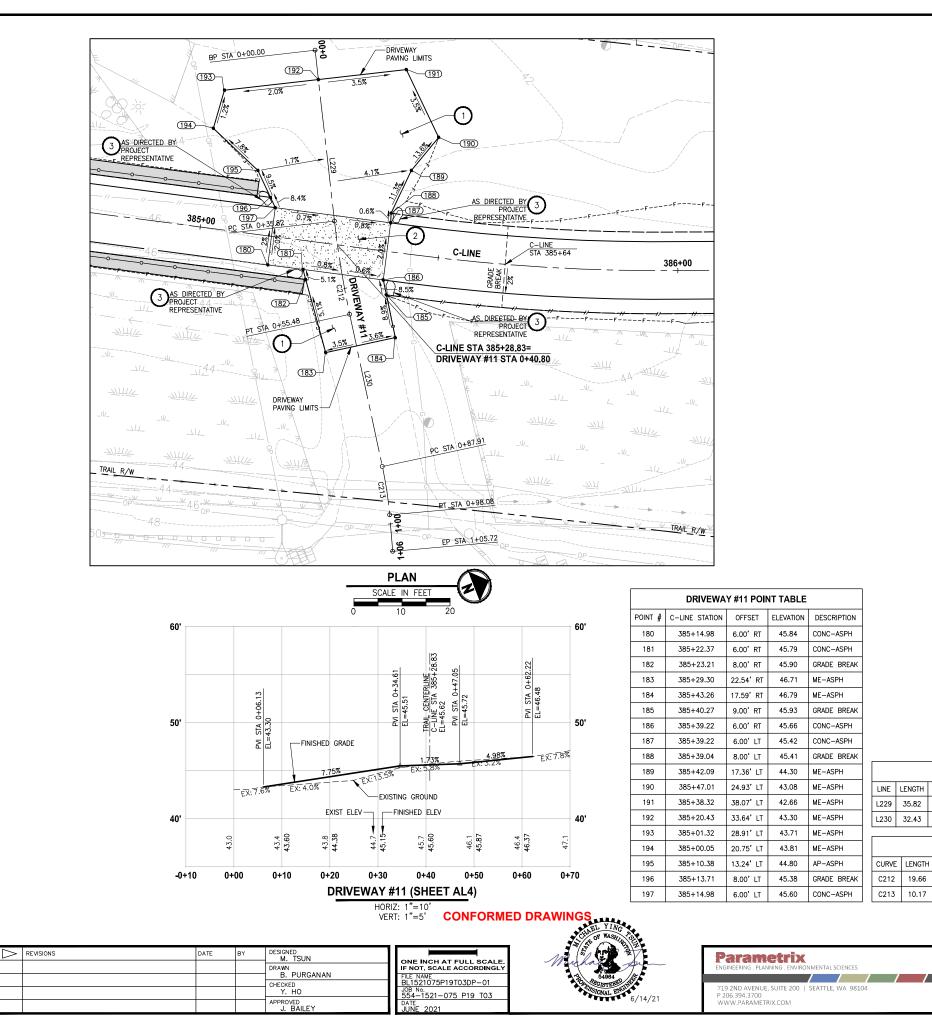

DRIVEWAY #11 LINE TABLE BEGIN EASTING BEGIN NORTHING END LINE LENGTH BEARING 1333092.82 133 L229 35.82 S75 09' 56"E 222246.69 L230 32.43 S80° 47' 57"E 1333146.68 222233.43 133 DRIVEWAY #11 CURVE TABLE CURVE LENGTH RADIUS DELTA BEGIN EASTING BEGIN NORTHING C212 19.66 200.00 5.38'01" 1333127.45 222237.52 C213 10.17 81.85 7'07'05" 1333178.69 222228.24

> PROJECT NAM EAST LAKE SAMMAMISH MASTER PLAN TRAIL SOUTH SAMMAMISH SEGMENT B - PHASE 2 SAMMAMISH, WA

DRIVEWAY PLAN AND PROFILE

SHEET NO. 95 OF 213

DP2

END EASTING	END NORTHING
1333146.68	222233.43
1333188.60	222226.00

END NORTHING
222237.52
222228.24

			NODT	
				,
3178.69	2	22228	3.24	
3127.45	2	22237	7.52	

3127.45	222237.52	
3178.69	222228.24	

			4
EASTING	END	NORTHING	

DEVELOPMENT REVIEW
These drawings have been reviewed for compliance
with City of Sammamish Clearing and Grading and
Stormwater requirements and also in accordance with
the requirements as established in the Settlement
Agreement between King County vs. City of
Sammamish No. C17-0921 JCC and King County vs.
City of Sammamish No. 17-2-29922-7 SEA and have
been deemed ACCEPTABLE. The reviewer accepts n
responsibility for any errors and/or omissions made by
the preparer of these drawings. Date
17 February 2022

CITY OF SAMMAMISH PUBLIC WORKS

CONSTRUCTION NOTES:

3 ROCK WALL, SEE

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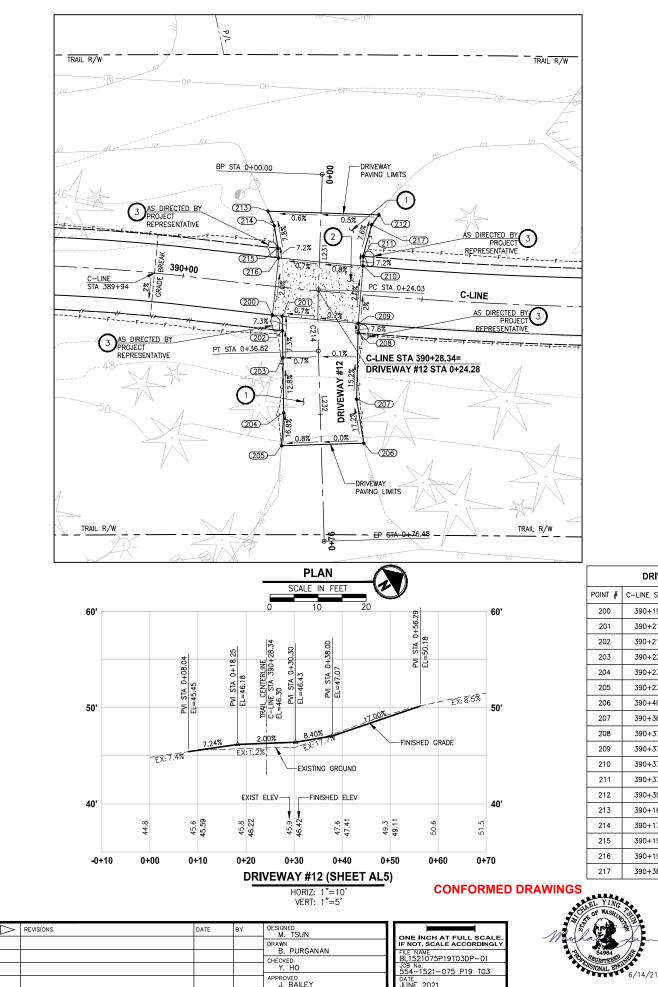
GRAVEL DRIVEWAY

LEGEND:

HMA DRIVEWAY PAVEMENT SECTION SHALL BE 4" HMA CL 1/2 PG 64-22 OVER 8" CRUSHED SURFACING BASE COURSE.

2 PATTERNED CONCRETE INTERSECTION, SEE

PATTERNED CONCRETE DRIVEWAY



DRIVEWAY #12 POINT TABLE								
POINT #	C-LINE STATION	OFFSET	ELEVATION	DESCRIPTION				
200	390+19.36	6.00' RT	46.36	CONC-ASPH				
201	390+21.39	6.00' RT	46.37	CONC-ASPH				
202	390+21.74	9.00' RT	46.59	GRADE BREAK				
203	390+22.39	14.60' RT	47.00	ASPH				
204	390+23.68	25.98' RT	48.95	AP-ASPH				
205	390+23.92	32.84' RT	50.10	ME-ASPH				
206	390+40.27	30.78' RT	50.19	ME-ASPH				
207	390+38.14	21.79' RT	48.60	AP-ASPH				
208	390+37.29	8.00'RT	46.64	GRADE BREAK				
209	390+37.17	6.00' RT	46.49	CONC-ASPH				
210	390+37.17	6.00' LT	46.25	CONC-ASPH		LINE	Τ	
211	390+37.00	8.00' LT	46.10	GRADE BREAK		L231	T	
212	390+39.63	16.87'LT	45.50	ME-ASPH		L232	T	
213	390+16.08	15.44' LT	45.38	ME-ASPH				
214	390+17.78	12.55' LT	45.62	AP-ASPH				
215	390+19.02	8.00' LT	45.99	AP-ASPH		CURV	E	
216	390+19.36	6.00'LT	46.15	CONC-ASPH		C214		
217	390+38.24	14.67'LT	45.58	GRADE BREAK				

	DRIVEWAY #12 LINE TABLE								
LENGTH	BEARING	BEGIN EASTING	BEGIN NORTHING	END EASTING	E				
24.03	S56 25' 04"E	1333357.95	222683.25	1333377.97					
39.65	S60° 04' 57"E	1333388.85	222663.23	1333423.22					

CURVE LENGTH RADIUS DELTA BEGIN EASTING BEGIN NORTHING END EASTIN	DRIVEWAY #12 CURVE TABLE							
	CURVE	LENGTH	RADIUS	DELTA	BEGIN EASTING	BEGIN NORTHING	END EASTIN	
C214 12.79 200.00 3'39'54" 1333377.97 222669.96 1333388.8	C214	12.79	200.00	3*39'54"	1333377.97	222669.96	1333388.85	



PROJECT NAM EAST LAKE SAMMAMISH MASTER PLAN TRAIL SOUTH SAMMAMISH SEGMENT B - PHASE 2 SAMMAMISH, WA



DRIVEWAY PLAN AND PROFILE

SHEET NO. 96 OF 213

DP3

CITY OF SAMMAMISH PUBLIC WORKS DEVELOPMENT REVIEW

These drawings have been reviewed for compliance with City of Sammamish Clearing and Grading and Stormwater requirements and also in accordance with

Agreements as established in the Settlement Agreement between King County vs. City of Sammarnish No. C17-0921 JCC and King County vs. City of Sammarnish No. 17-2-2922-7 SEA and have been deemed ACCEPTABLE. The reviewer accepts no

responsibility for any errors and/or omissions made by the preparer of these drawings. 17 February 2022














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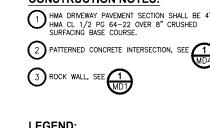
, 19 A

PATTERNED CONCRETE DRIVEWAY


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GRAVEL DRIVEWAY





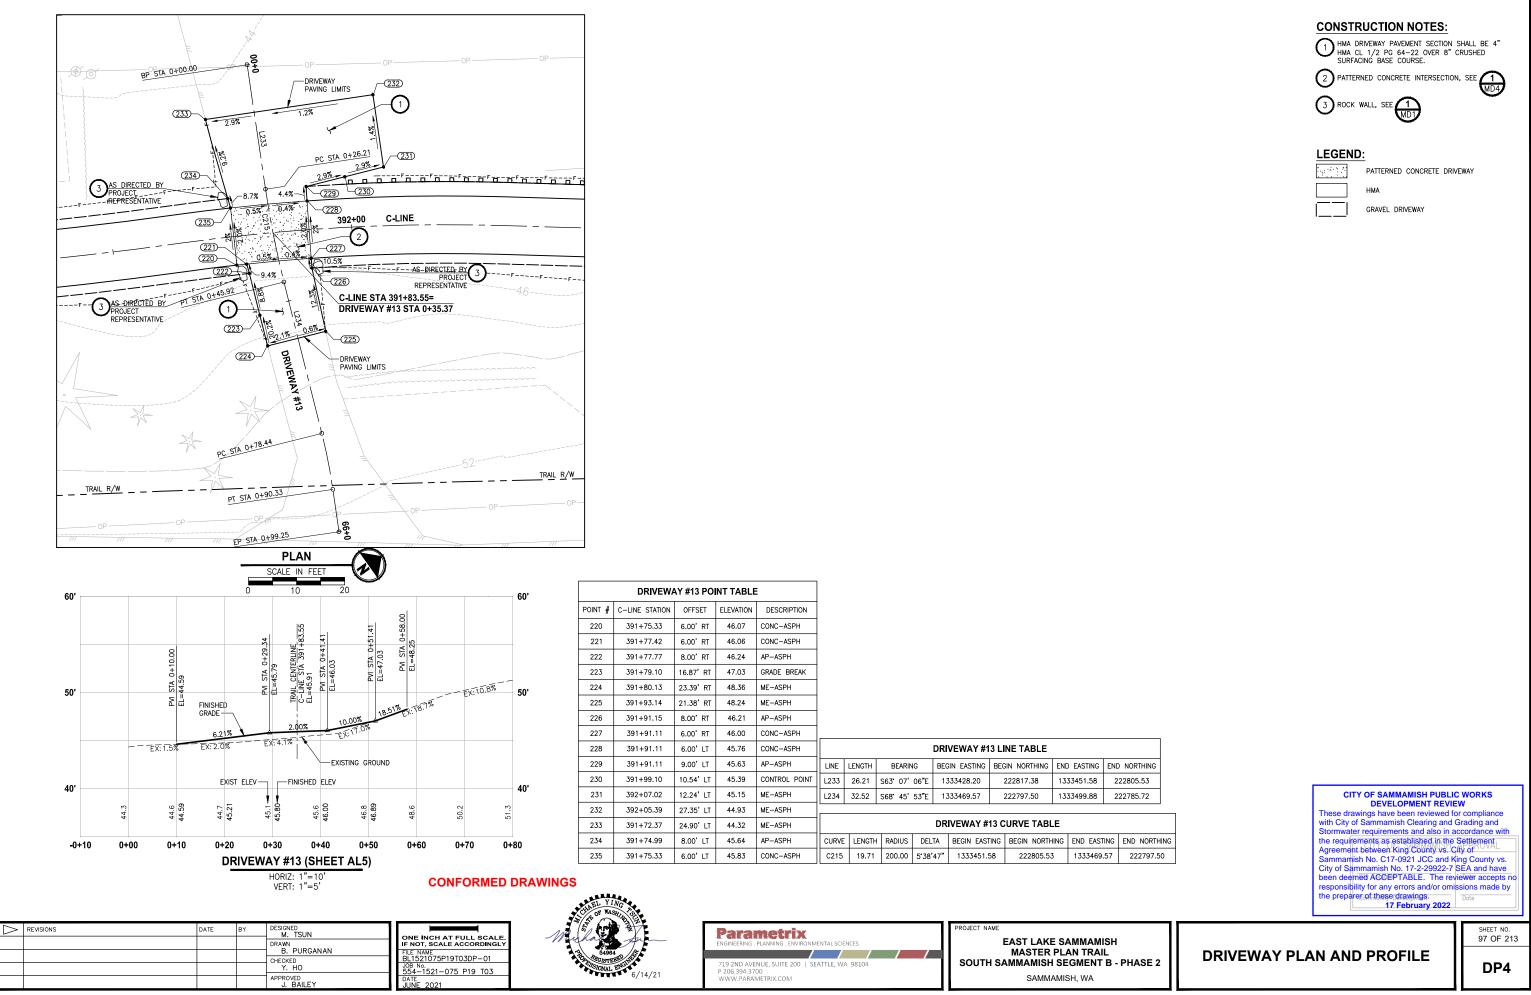

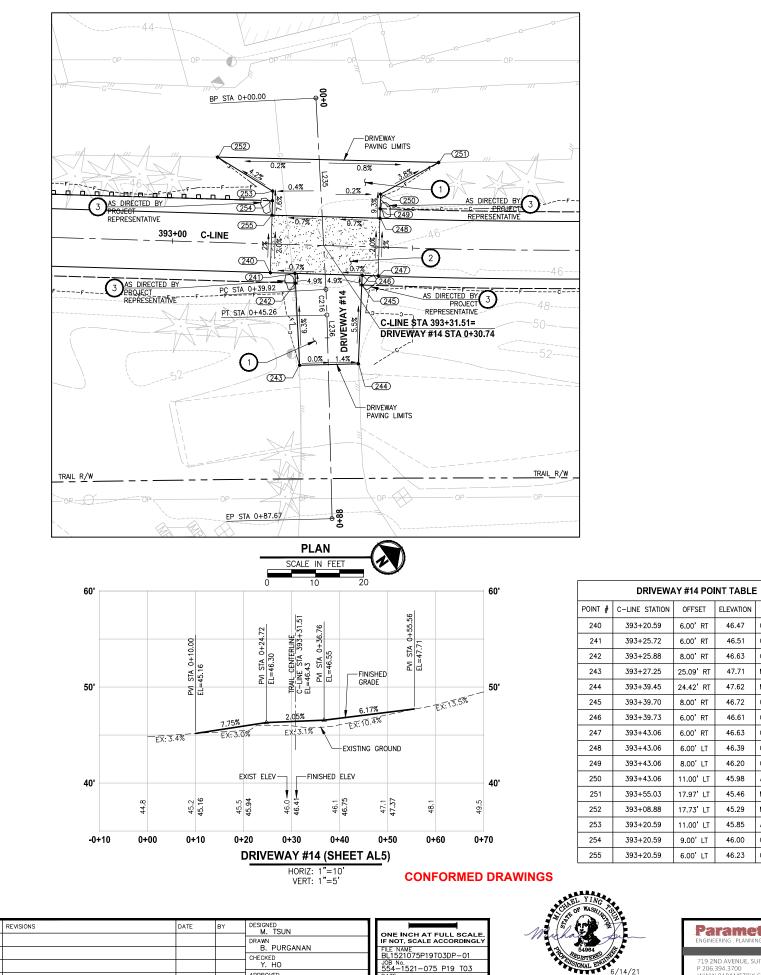

APPROVED J. BAILEY

- 2021

	DRIVEWAT #14 POINT TABLE											
POINT #	C-LINE STATION	OFFSET	ELEVATION	DESCRIPTION								
240	393+20.59	6.00' RT	46.47	CONC-ASPH								
241	393+25.72	6.00' RT	46.51	CONC-ASPH								
242	393+25.88	8.00' RT	46.63	GRADE BREAK								
243	393+27.25	25.09' RT	47.71	ME-ASPH								
244	393+39.45	24.42' RT	47.62	ME-ASPH								
245	393+39.70	8.00' RT	46.72	GRADE BREAK								
246	393+39.73	6.00' RT	46.61	CONC-ASPH								
247	393+43.06	6.00' RT	46.63	CONC-ASPH								
248	393+43.06	6.00'LT	46.39	CONC-ASPH				DR	IVEWAY #1	4 LINE TABLE		
249	393+43.06	8.00'LT	46.20	CONTROL POINT	LINE	LENGTH	BEARIN	IG BE	GIN EASTING	BEGIN NORTHING	END EASTING	G EN
250	393+43.06	11.00' LT	45.98	AP-ASPH	L235	39.92	S57° 42'	12"E 1	333520.47	222937.86	1333554.22	
251	393+55.03	17.97'LT	45.46	ME-ASPH	L236	42.41	S56 10'	28"E 1	333558.69	222913.62	1333593.92	
252	393+08.88	17.73' LT	45.29	ME-ASPH							•	
253	393+20.59	11.00' LT	45.85	AP-ASPH				DF	RIVEWAY #	14 CURVE TABI	-E	
254	393+20.59	9.00'LT	46.00	CONTROL POINT	CURVE	LENGTH	RADIUS	DELTA	BEGIN EAST	ING BEGIN NORTH	ING END EAS	STING
255	393+20.59	6.00'LT	46.23	CONC-ASPH	C216	5.34	200.00	1'31'44"	1333554.2	2 222916.53	3 133355	8.69

Parametrix

6/14/21

PROJECT NAM EAST LAKE SAMMAMISH MASTER PLAN TRAIL 719 2ND AVENUE, SUITE 200 | SEATTLE, WA 98104 P 206.394.3700 WWW.PARAMETRIX.COM SOUTH SAMMAMISH SEGMENT B - P SAMMAMISH, WA

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PHASE 2	2
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DRIVEWAY PLAN AND PROFILE

SHEET NO. 98 OF 213

DP5







CONSTRUCTION NOTES:

3 ROCK WALL, SEE MD1

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GRAVEL DRIVEWAY


LEGEND:

, 19 A

HMA DRIVEWAY PAVEMENT SECTION SHALL BE 4" HMA CL 1/2 PG 64-22 OVER 8" CRUSHED SURFACING BASE COURSE.

2 PATTERNED CONCRETE INTERSECTION, SEE

PATTERNED CONCRETE DRIVEWAY

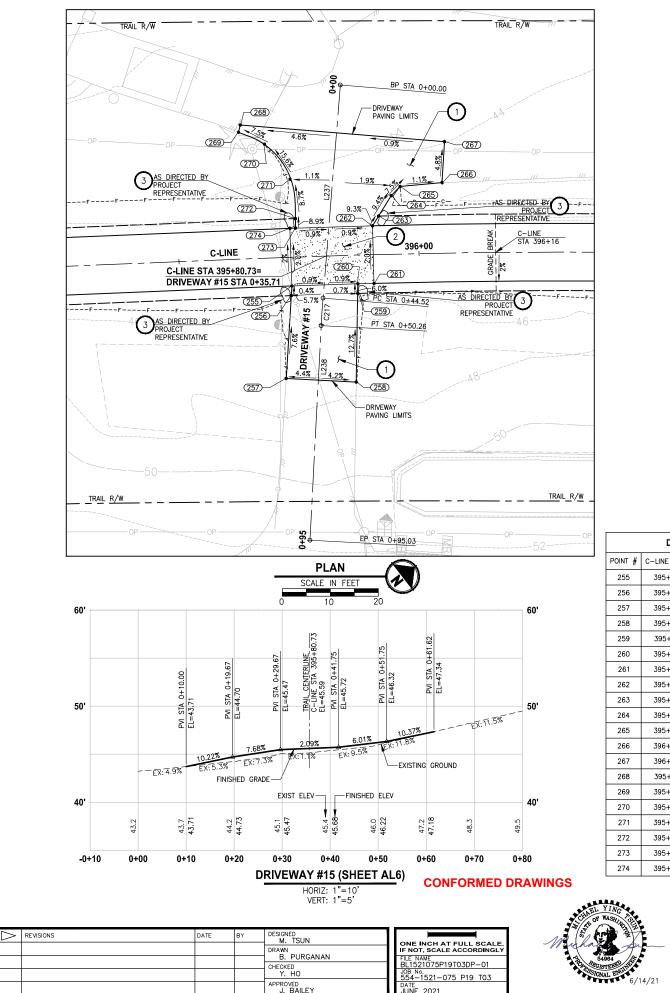

DRIVEWAY #15 POINT TABLE						
POINT #	C-LINE STATION	OFFSET	ELEVATION	DESCRIPTION		
255	395+73.32	6.00' RT	45.75	CONC-ASPH		
256	395+73.12	8.00'RT	45.87	ME-ASPH		
257	395+71.38	25.19'RT	47.05	ME-ASPH		
258	395+86.19	26.44' RT	47.67	ME-ASPH		
259	395+87.01	8.00'RT	45.78	ME-ASPH		
260	395+87.12	6.00' RT	45.66	CONC-ASPH		
261	395+90.48	6.00' RT	45.63	CONC-ASPH		
262	395+90.48	6.00'LT	45.39	CONC-ASPH		
263	395+91.78	8.00' LT	45.17	ME-ASPH		
264	395+94.50	12.18' LT	44.70	AP-ASPH		
265	395+96.38	14.06' LT	44.50	AP-ASPH		
266	396+05.04	14.67'LT	44.40	ME-ASPH		
267	396+05.69	23.20' LT	43.99	ME-ASPH		
268	395+63.91	27.90' LT	42.78	ME-ASPH		
269	395+63.48	26.41' LT	43.35	ME-ASPH		
270	395+68.73	23.73' LT	43.29	CURVE PT		
271	395+73.74	16.21'LT	44.61	CURVE MIDPOINT		
272	395+74.54	8.00' LT	45.34	CURVE PC		
273	395+74.50	6.00' LT	45.52	CONC-ASPH		
274	395+73.32	6.00'LT	45.51	CONC-ASPH		

Parametrix

719 2ND AVENUE, SUITE 200 | SEATTLE, WA 98104 P 206.394.3700 WWW.PARAMETRIX.COM

DRIVEWAY #15 LINE TABLE							
LINE	LENGTH	BEARIN	G	BEGIN EASTING	BEGIN NORTHING	END EASTING	END NORTHING
L237	44.52	S47 45'	46"E	1333664.69	223148.35	1333697.66	223118.42
L238	44.77	S49* 24'	26"E	1333701.96	223114.63	1333735.95	223085.50
DRIVEWAY #15 CURVE TABLE							
0.00	LIENOT		05174	05000 5107			

			DR	IVEWAY #15 C	URVE TABLE	
CURVE	LENGTH	RADIUS	DELTA	BEGIN EASTING	BEGIN NORTHING	EN
C217	5.74	200.00	1*38'40"	1333697.66	223118.42	13

iv	PROJECT NAME
WIRONMENTAL SCIENCES	EAST LAKE SAMMAMISH
	MASTER PLAN TRAIL
00 SEATTLE, WA 98104	SOUTH SAMMAMISH SEGMENT B - PHASE
	SAMMAMISH, WA




DRIVEWAY PLAN AND PROFILE

SHEET NO. 99 OF 213

DP6

ND EASTING	END NORTHING
1333701.96	223114.63
1333701.90	223114.03

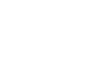



the preparer of these drawings. 17 February 2022

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LEGEND: PATTERNED CONCRETE DRIVEWAY $q \neq 1 \land 1$ НМА




GRAVEL DRIVEWAY



3 ROCK WALL, SEE

CONSTRUCTION NOTES:

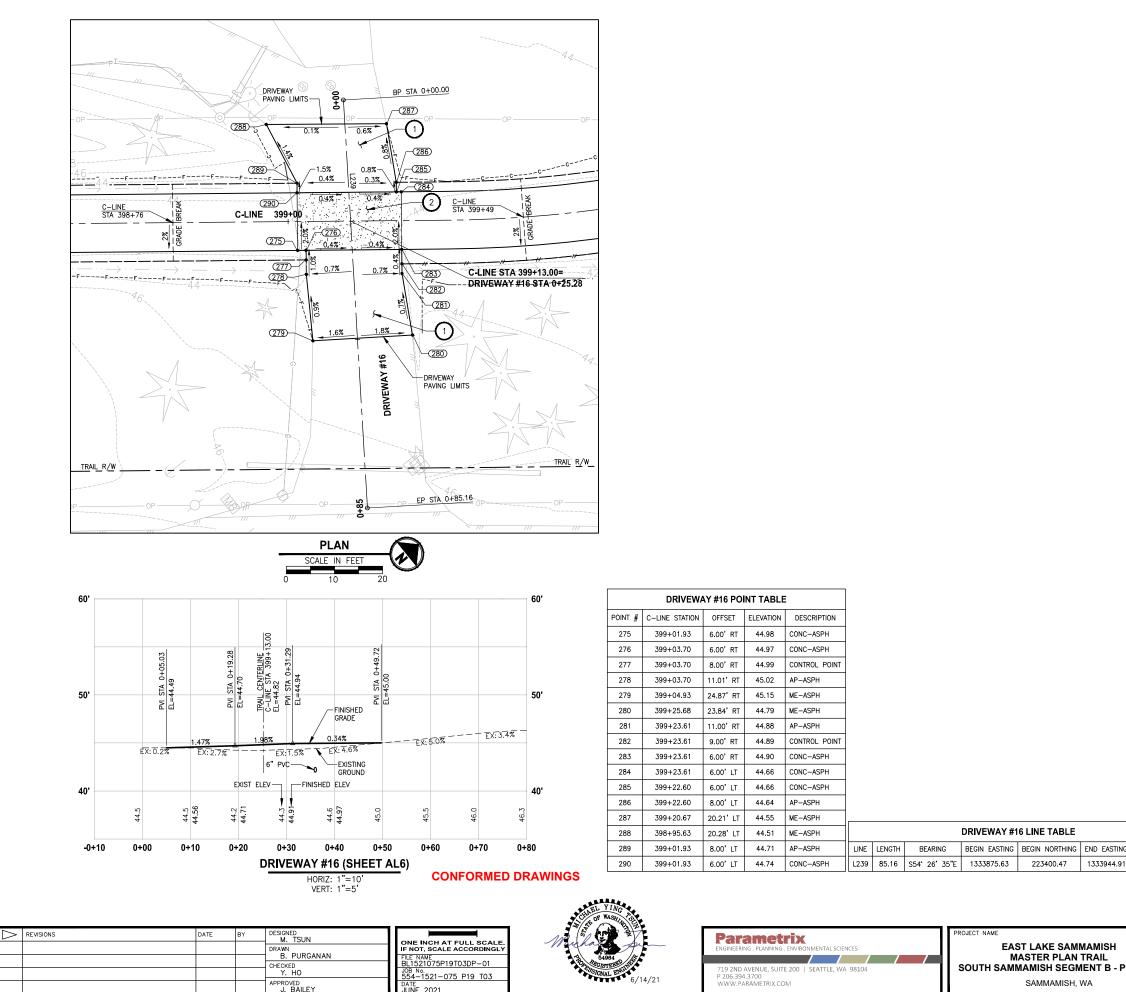

DRIVEWAY PLAN AND PROFILE

SHEET N 100 OF 213

DP7

NG	END N	ORTHING
91	223	350.95



CITY OF SAMMAMISH PUBLIC WORKS DEVELOPMENT REVIEW


LEGEND: PATTERNED CONCRETE DRIVEWAY нма

3 ROCK WALL, SEE

GRAVEL DRIVEWAY

CONSTRUCTION NOTES:



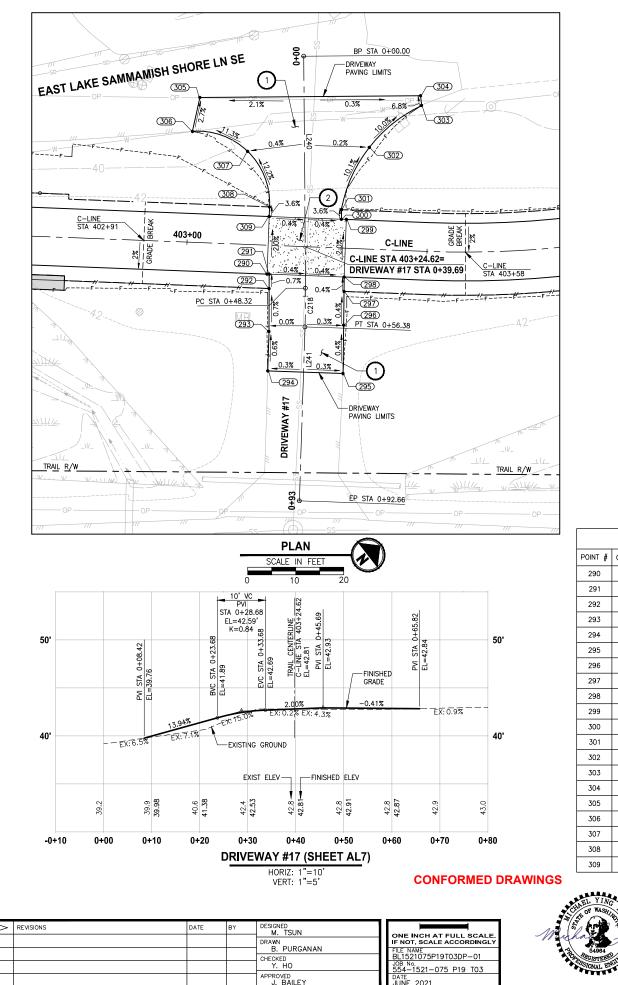

202

	DRIVEW	AY #17 PO	INT TABLE	E
POINT #	C-LINE STATION	OFFSET	ELEVATION	DESCRIPTION
290	403+16.90	6.00' RT	42.95	CONC-ASPH
291	403+17.35	6.00' RT	42.95	CONC-ASPH
292	403+17.45	9.00' RT	42.93	CONTROL POINT
293	403+17.76	17.93'RT	42.87	AP
294	403+17.83	26.16' RT	42.82	ME-ASPH
295	403+33.52	26.07' RT	42.82	ME-ASPH
296	403+33.24	16.04'RT	42.86	CONTROL POINT
297	403+33.05	9.00' RT	42.89	CONTROL POINT
298	403+32.97	6.00' RT	42.90	CONC-ASPH
299	403+32.97	6.00'LT	42.66	CONC-ASPH
300	403+31.94	6.00' LT	42.66	CONC-ASPH
301	403+31.87	8.00' LT	42.59	CURVE PT
302	403+37.16	21.18' LT	41.18	CURVE MIDPOINT
303	403+47.71	30.33' LT	39.79	CURVE PC
304	403+47.43	32.34' LT	39.67	ME-ASPH
305	403+01.49	30.22' LT	39.43	ME-ASPH
306	403+00.23	23.10' LT	39.62	ME-CURVE PC
307	403+11.89	19.37'LT	41.12	CURVE MIDPOINT
308	403+16.89	8.00' LT	42.64	CURVE PT
309	403+16.89	6.00' LT	42.71	CONC-ASPH

6/14/21

Parametrix

719 2ND AVENUE, SUITE 200 | SEATTLE, WA 98104 P 206.394.3700 WWW.PARAMETRIX.COM

			DRIVEWAY #1	7 LINE TABLE				
LINE	LENGTH	BEARING	BEGIN EASTING	BEGIN NORTHING	END EASTING	1		
L240	48.32	S52 30' 24"E	1334123.51	223729.52	1334161.84			
L241	36.27	S50°11'45"E	1334168.14	223695.07	1334196.01			
DRIVEWAY #17 CURVE TABLE								

			UR	IVEWAT #17 C	URVE TABLE	
CURVE	LENGTH	RADIUS	DELTA	BEGIN EASTING	BEGIN NORTHING	END EAST
C218	8.07	200.00	2•18'39"	1334161.84	223700.11	1334168.

PROJECT NAM


MASTER PLAN TRAIL SOUTH SAMMAMISH SEGMENT B - P

EAST LAKE SAMMAMISH

SAMMAMISH, WA

SHEET NO. 101 OF 213

DP8

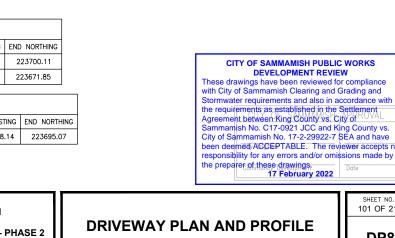


LEGEND: PATTERNED CONCRETE DRIVEWAY нма GRAVEL DRIVEWAY







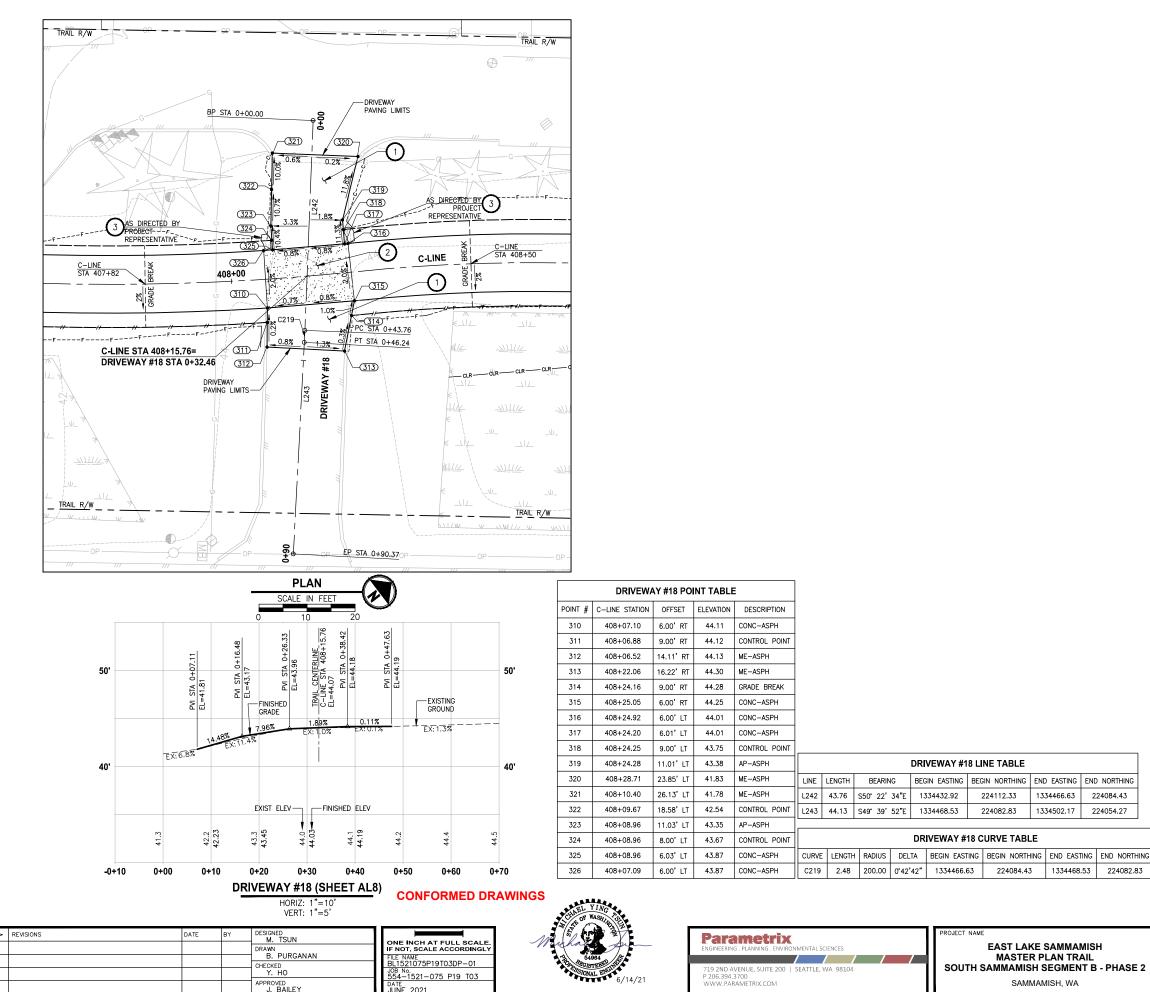

CONSTRUCTION NOTES:

HMA DRIVEWAY PAVEMENT SECTION SHALL BE 4" HMA CL 1/2 PG 64-22 OVER 8" CRUSHED SURFACING BASE COURSE.

2 PATTERNED CONCRETE INTERSECTION, SEE

3 ROCK WALL, SEE




LEGEND:

. 14 S. A PATTERNED CONCRETE DRIVEWAY нма

GRAVEL DRIVEWAY



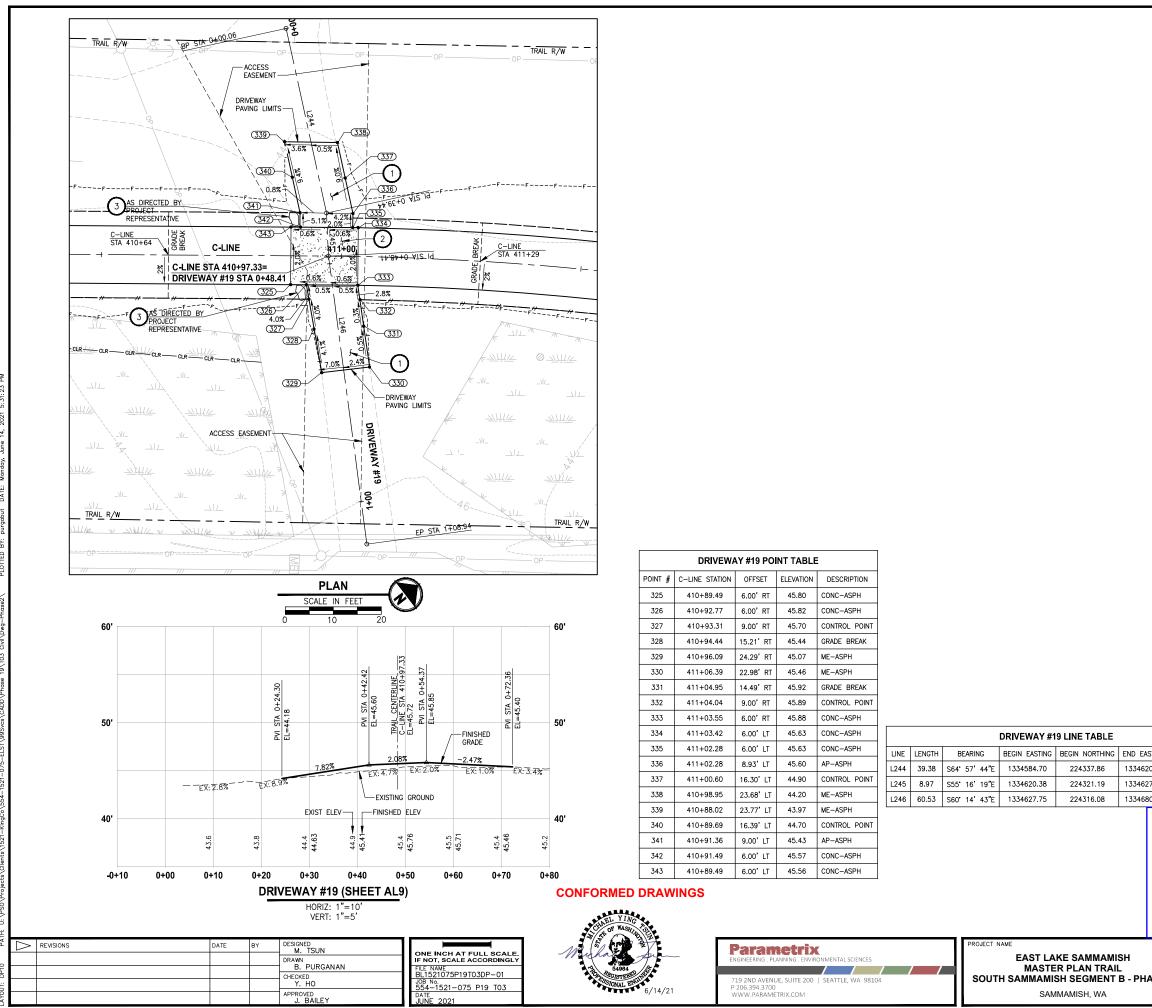

эп - В - РН,	ASE 2	2	D	RIVEWAY PLAN AI	N	D PROFILE		DP10
SH								SHEET NO. 103 OF 213
	with Storr the re Agre Same City of been response	e drav City o nwate equire emen mamis of Sar deen onsibil	DEVE wings have f Sammarr er requirem ements as of t between sh No. C17 mmamish N ned ACCE lity for any er of these	IMAMISH PUBLIC WORKS LOPMENT REVIEW a been reviewed for compliance hish Clearing and Grading and uents and also in accordance with established in the Settlement King County vs. City of 7-0921 JCC and King County vs. No. 17-2-29922-7 SEA and have PTABLE. The reviewer accepts no errors and/or omissions made by drawings. February 2022		CITY OF SAMMAMISH	г	PPROVAL Date
133468	80.29	22	4286.05					
133462	7.75	22	4316.08					
133462	20.38	22	4321.19					
END EA	STING	END	NORTHING					

3 ROCK WALL, SEE	
LEGEND:	






PATTERNED CONCRETE DRIVEWAY

2 PATTERNED CONCRETE INTERSECTION, SEE

нма

GRAVEL DRIVEWAY

CONSTRUCTION NOTES: HMA DRIVEWAY PAVEMENT SECTION SHALL BE 4" HMA CL 1/2 PG 64-22 OVER 8" CRUSHED SURFACING BASE COURSE.

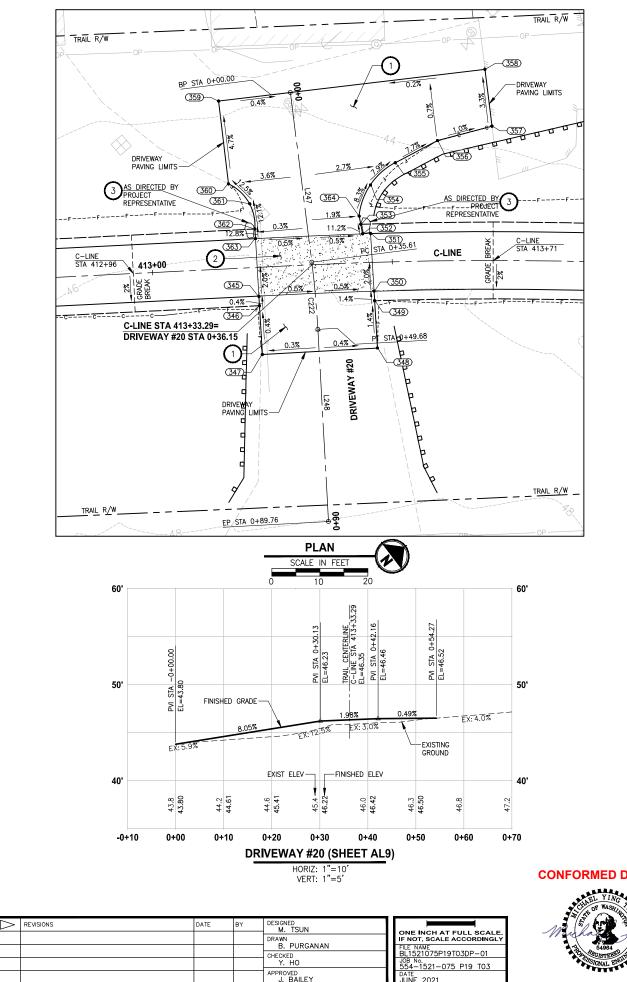

	DRIVEW	AY #20 PO	INT TABLE	E
POINT #	C-LINE STATION	OFFSET	ELEVATION	DESCRIPTION
345	413+21.89	6.05'RT	46.53	CONC-ASPH
346	413+21.91	8.00' RT	46.52	CONTROL POINT
347	413+22.01	18.17'RT	46.48	ME-ASPH
348	413+46.35	17.89'RT	46.57	ME-ASPH
349	413+46.06	8.00' RT	46.43	CONTROL POINT
350	413+46.01	6.00' RT	46.40	CONC-ASPH
351	413+45.67	6.00'LT	46.16	CONC-ASPH
352	413+44.00	6.00' LT	46.17	CONC-ASPH
353	413+43.70	8.00' LT	45.94	CONTROL POINT
354	413+45.97	16.12'LT	45.17	CURVE MIDPOINT
355	413+51.13	20.59' LT	44.60	CURVE PC
356	413+59.76	25.04' LT	43.85	AP-ASPH
357	413+70.79	27.95' LT	43.73	ME-ASPH
358	413+69.38	39.81'LT	43.34	ME-ASPH
359	413+15.54	35.00' LT	43.85	ME-ASPH
360	413+16.73	17.68' LT	44.66	CURVE PC
361	413+20.94	13.31'LT	45.38	CURVE MIDPOINT
362	413+21.76	8.00'LT	46.03	CURVE PT
363	413+21.78	6.00' LT	46.29	CONC-ASPH
364	413+43.44	9.71'LT	45.75	CURVE PT

			DF	RIVEWAY #2	0 LINE TABLE			
LINE	LENGTH	BEARIN	G BE	EGIN EASTING	BEGIN NORTHING	END EASTING	END	NORTHING
L247	35.61	S56°20'	22"E	1334748.31	224517.54	1334777.95	2	24497.80
L248	40.08	S52 18'	35"E	334789.37	224489.60	1334821.09	34821.09 224465.09	
			DI	RIVEWAY #	20 CURVE TABI	.E		
CURVE	LENGTH	RADIUS	DELTA	BEGIN EAST	TING BEGIN NORTH	ING END EASTING END NORT		END NORTH
C222	14.07	200.00	4 ° 01'47'	1334777.9	95 224497.80	224497.80 1334789.37 224489.		224489.6


CONFORMED DRAWINGS

6/14/21



PROJECT NAME	Parametrix
	ENGINEERING . PLANNING . ENVIRONMENTAL SCIENCES
SOUTH SA	719 2ND AVENUE, SUITE 200 SEATTLE, WA 98104
	P 206.394.3700 WWW.PARAMETRIX.COM

EAST LAKE SAMMAMISH MASTER PLAN TRAIL SAMMAMISH SEGMENT B - PHASE 2 SAMMAMISH, WA

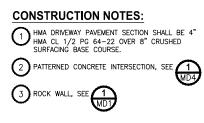

LEGEND:



PATTERNED CONCRETE DRIVEWAY

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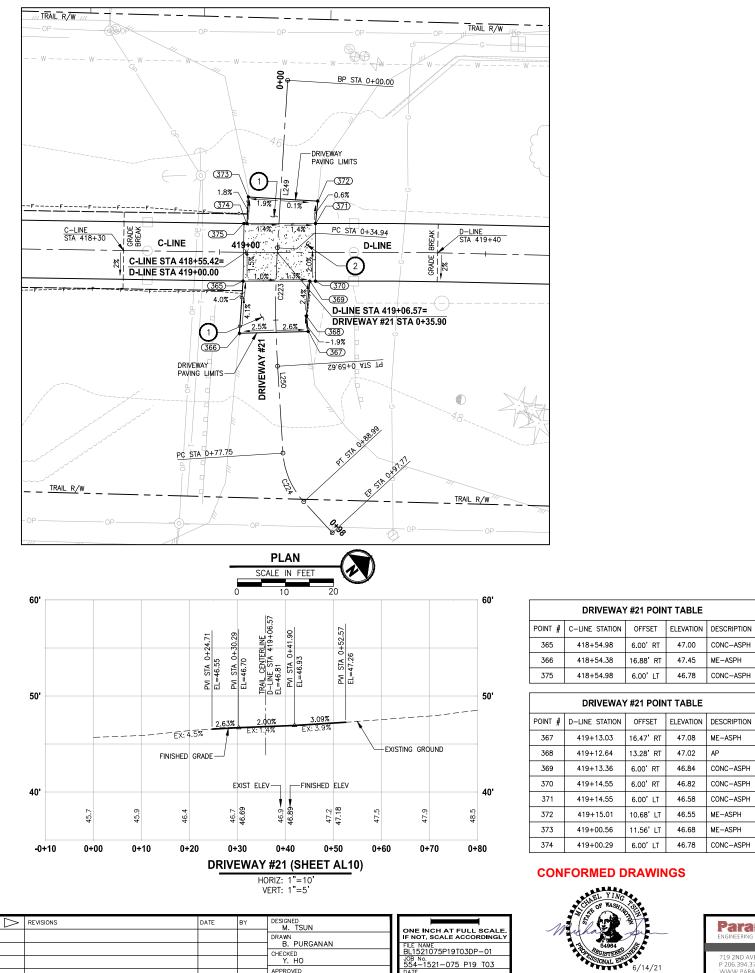
GRAVEL DRIVEWAY

CITY OF SAMMAMISH PUBLIC WORKS DEVELOPMENT REVIEW DEVELOPMENT REVIEW These drawings have been reviewed for compliance with City of Sammamish Clearing and Grading and Stormwater requirements and also in accordance with the requirements as established in the Settlement Agreement between King County vs. City of Sammamish No. C17-0921 JCC and King County vs. City of Sammamish No. 17-2-29922-7 SEA and have been deemed ACCEPTABLE. The reviewer accepts n responsibility for any corrars and (or empresions made but responsibility for any errors and/or omissions made by the preparer of these drawings. 17 February 2022

SHEET NO. 104 OF 213

DRIVEWAY PLAN AND PROFILE

DP11



APPROVED J. BAILEY

DATE IIINE <u>2021</u>

DRIVEWAY #21 POINT TABLE										
POINT #	C-LINE STATION	OFFSET	ELEVATION	DESCRIPTION						
365	418+54.98	6.00' RT	47.00	CONC-ASPH						
366	418+54.38	16.88'RT	47.45	ME-ASPH						
375	418+54.98	6.00'LT	46.78	CONC-ASPH						
DRIVEWAY #21 POINT TABLE										
POINT #	D-LINE STATION	OFFSET	ELEVATION	DESCRIPTION						
367	419+13.03	16.47'RT	47.08	ME-ASPH						
368	419+12.64	13.28' RT	47.02	AP						
369	419+13.36	6.00'RT	46.84	CONC-ASPH						
370	419+14.55	6.00' RT	46.82	CONC-ASPH						
371	419+14.55	6.00' LT	46.58	CONC-ASPH						
372	419+15.01	10.68'LT	46.55	ME-ASPH						
373	419+00.56	11.56'LT	46.68	ME-ASPH						

	DRIVEWAY #21 LINE TABLE											
LINE	LINE LENGTH BEARING BEGIN EASTING BEGIN NORTHING END EASTING END NORTHING											
L249	34.94	S49° 42' 50"E	1335078.29	224935.75	1335104.95	224913.16						
L250	18.13	S56 47' 04"E	1335124.71	224898.40	1335139.87	224888.47						

	DRIVEWAY #21 CURVE TABLE									
CURVE	LENGTH	RADIUS	DELTA	BEGIN EASTING	BEGIN NORTHING	END EASTING	END NORTHIN			
C223	24.68	200.00	7•04'14"	1335104.95	224913.16	1335124.71	224898.40			
C224	11.24	16.48	39 • 05'59"	1335139.87	224888.47	1335150.59	224885.87			

CONFORMED DRAWINGS







C	ON	IST	ΓRL	ION	I NO	TES:

HMA DRIVEWAY PAVEMENT SECTION SHALL BE 4" HMA CL 1/2 PG 64-22 OVER 8" CRUSHED SURFACING BASE COURSE.





LEGEND:




PATTERNED CONCRETE DRIVEWAY

HMA

GRAVEL DRIVEWAY

PHAS	SE 2	DRIVEWAY PLAN AN	D PROFILE	SHEET NO. 105 OF 213 DP12
G	These du with City Stormwa the requi Agreeme Sammar City of S been dea responsi	TY OF SAMMAMISH PUBLIC WORKS DEVELOPMENT REVIEW rawings have been reviewed for compliance of Sammamish Clearing and Grading and iter requirements and also in accordance with irrements as established in the Settlement ent between King County vs. City of mish No. C17-0921 JCC and King County vs. ammamish No. 17-2-29922-7 SEA and have emed ACCEPTABLE. The reviewer accepts no bility for any errors and/or omissions made by are of these drawings. 17 February 2022	CITY OF SAMMAMISH City Engineer Community Development	APPROVAL Date

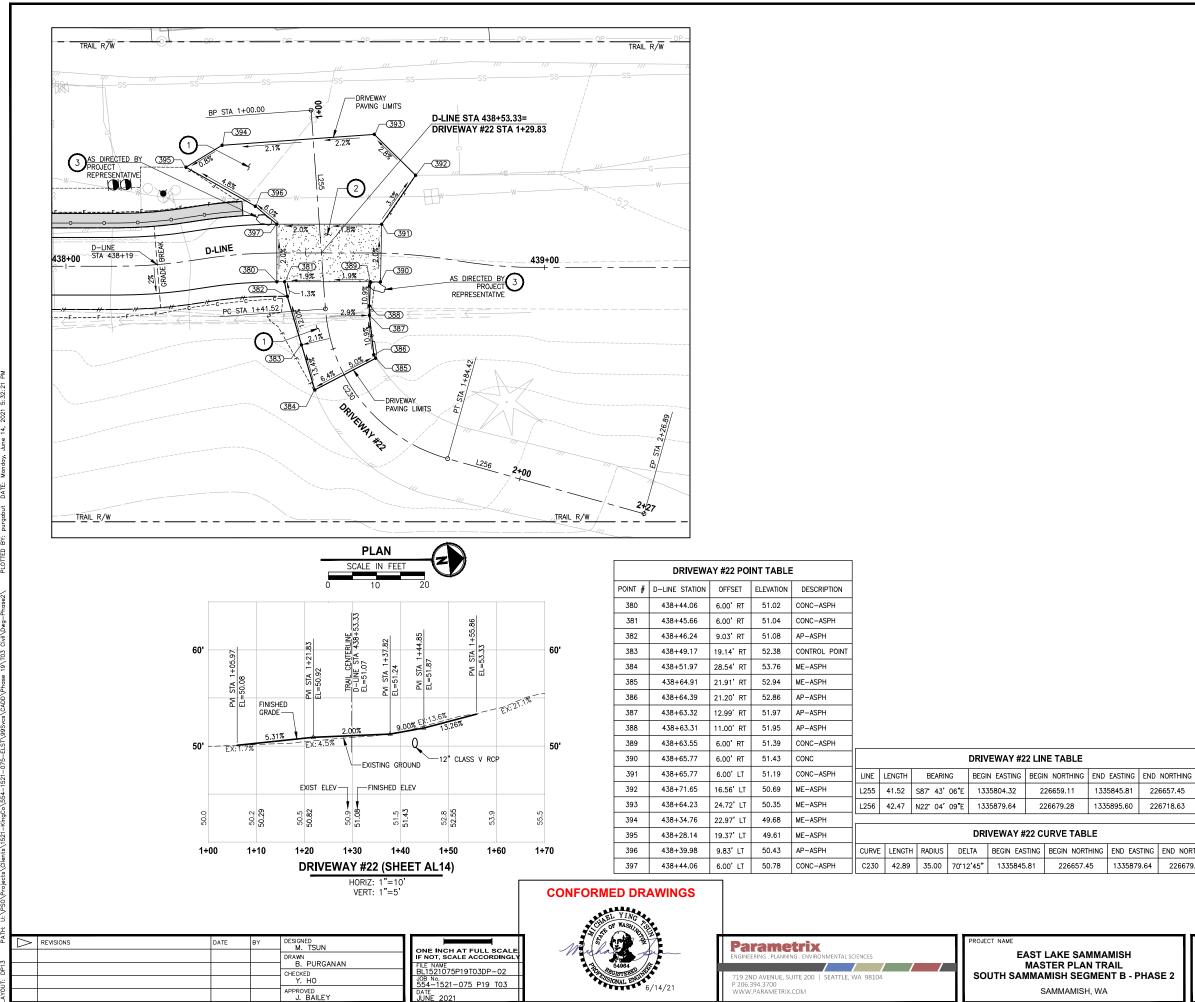

DRIVEWAY PLAN AND PROFILE

SHEET N 106 OF 213

END EASTING	END NORTHING
1335879.64	226679.28













These drawings have been reviewed for compliance with City of Sammamish Clearing and Grading and Stormwater requirements and also in accordance with the requirements as established in the Settlement Agreement between King County vs. City of Sammarish No. C17-0921 JCC and King County vs. City of Sammarish No. 17-2-29922-7 SEA and have been deemed ACCEPTABLE. The reviewer accepts esponsibility for any errors and/or omissions made by the preparer of these drawings. 17 February 2022

CITY OF SAMMAMISH PUBLIC WORKS DEVELOPMENT REVIEW

DP13

GRAVEL DRIVEWAY

PATTERNED CONCRETE DRIVEWAY






CONSTRUCTION NOTES:

LEGEND:

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ΡA	\supset	REVISIONS	DATE	BY	DESIGNED M. TSUN	
4					DRAWN	ONE INCH AT FULL SCALE IF NOT, SCALE ACCORDINGLY
DP12					B. PURGANAN CHECKED	FILE NAME BL1521075P19T03DP-02
OUT:					Ү. НО	JOB No. 554-1521-075 P19 T03
-ΑΥΟ					APPROVED J. BAILEY	DATE JUNE 2021

DESCRIPTION OFFSET ELEVATION 6.00'RT 51.37 ME-CONC-ASPH 19.11'RT 53.87 CURVE MIDPOINT 26.15' RT ME-CURVE PT 56.47 42.45' RT 56.76 ME-CURVE PT 54.03 CURVE MIDPOINT 28.89' RT 6.00'RT 51.12 CONC-ASPH 6.00'RT 51.08 CONC-ASPH 6.00'LT 50.84 CONC-ASPH 8.63'LT 50.72 AP-ASPH 50.28 ME-ASPH 13.83' LT ME-CURVE PC 16.43' LT 50.92 11.66' LT 50.98 CURVE MIDPOINT 6.00'LT 51.10 CURVE PT 6.00' LT 51.13 ME-CONC 9.00' RT 51.19 CONTROL POINT
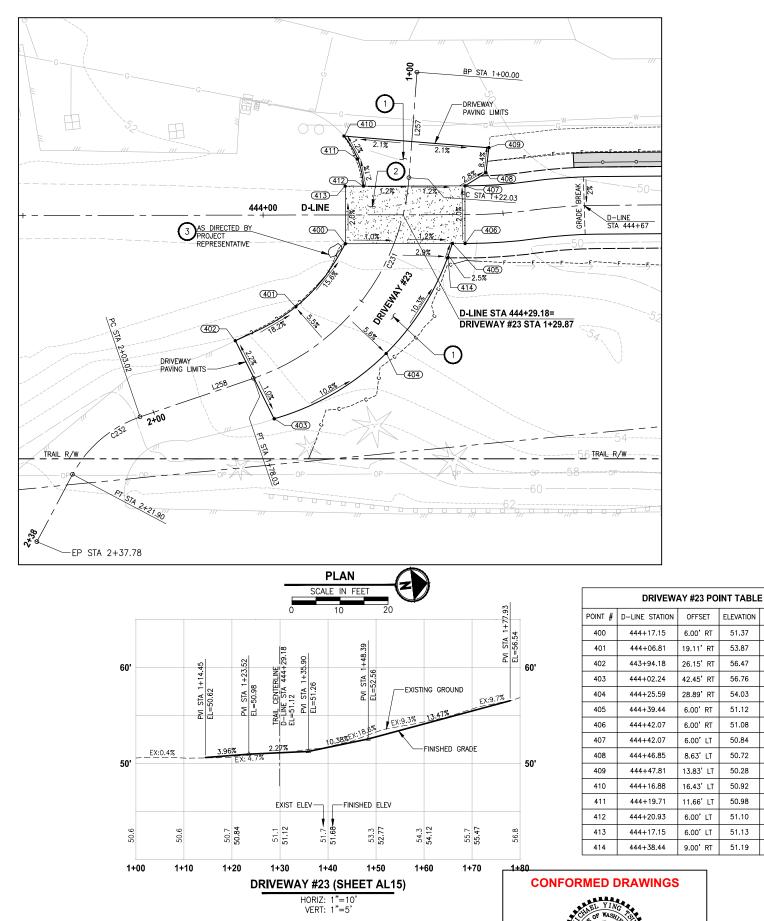
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6/14/21

	DRIVEWAY #23 LINE TABLE									
LINE	LENGTH	BEARING	BEGIN EASTING	BEGIN NORTHING	END EASTING	END NORTHING				
L257	22.03	S79 15' 26"E	1335874.25	227235.53	1335895.89	227231.43				
L258	24.98	S12 24' 07"E	1335933.82	227194.58	1335939.19	227170.18				
			DRIVEWAY #	23 CURVE TAB	LE					

			DR	VEWAY #23 C	URVE TABLE	
CURVE	LENGTH	RADIUS	DELTA	BEGIN EASTING	BEGIN NORTHING	END E
C231	56.01	48.00	66*51'19"	1335895.89	227231.43	13359
C232	18.88	25.00	43 ° 16'44"	1335939.19	227170.18	13359

PROJECT NAM Parametrix EAST LAKE SAMMAMISH MASTER PLAN TRAIL 719 2ND AVENUE, SUITE 200 | SEATTLE, WA 98104 P 206.394.3700 WWW.PARAMETRIX.COM SOUTH SAMMAMISH SEGMENT B - PHASE 2 SAMMAMISH, WA



DRIVEWAY PLAN AND PROFILE

SHEET NO. 107 OF 213

DP14

EASTING END NORTHING 933.82 227194.58 949.51 227154.90

DEVELOPMENT REVIEW These drawings have been reviewed for compliance with City of Sammamish Clearing and Grading and Stormwater requirements and also in accordance with the requirements as established in the Settlement Agreement between King County vs. City of VAL Sammamish No. C17-0921 JCC and King County vs. City of Sammamish No. 17-2-29922-7 SEA and have peen deemed ACCEPTABLE. The reviewer accepts n

CITY OF SAMMAMISH PUBLIC WORKS


2 PATTERNED CONCRETE INTERSECTION, SEE 3 ROCK WALL, SEE LEGEND:

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GRAVEL DRIVEWAY


. 14 S. A

CONSTRUCTION NOTES:



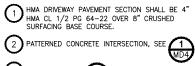

PATTERNED CONCRETE DRIVEWAY

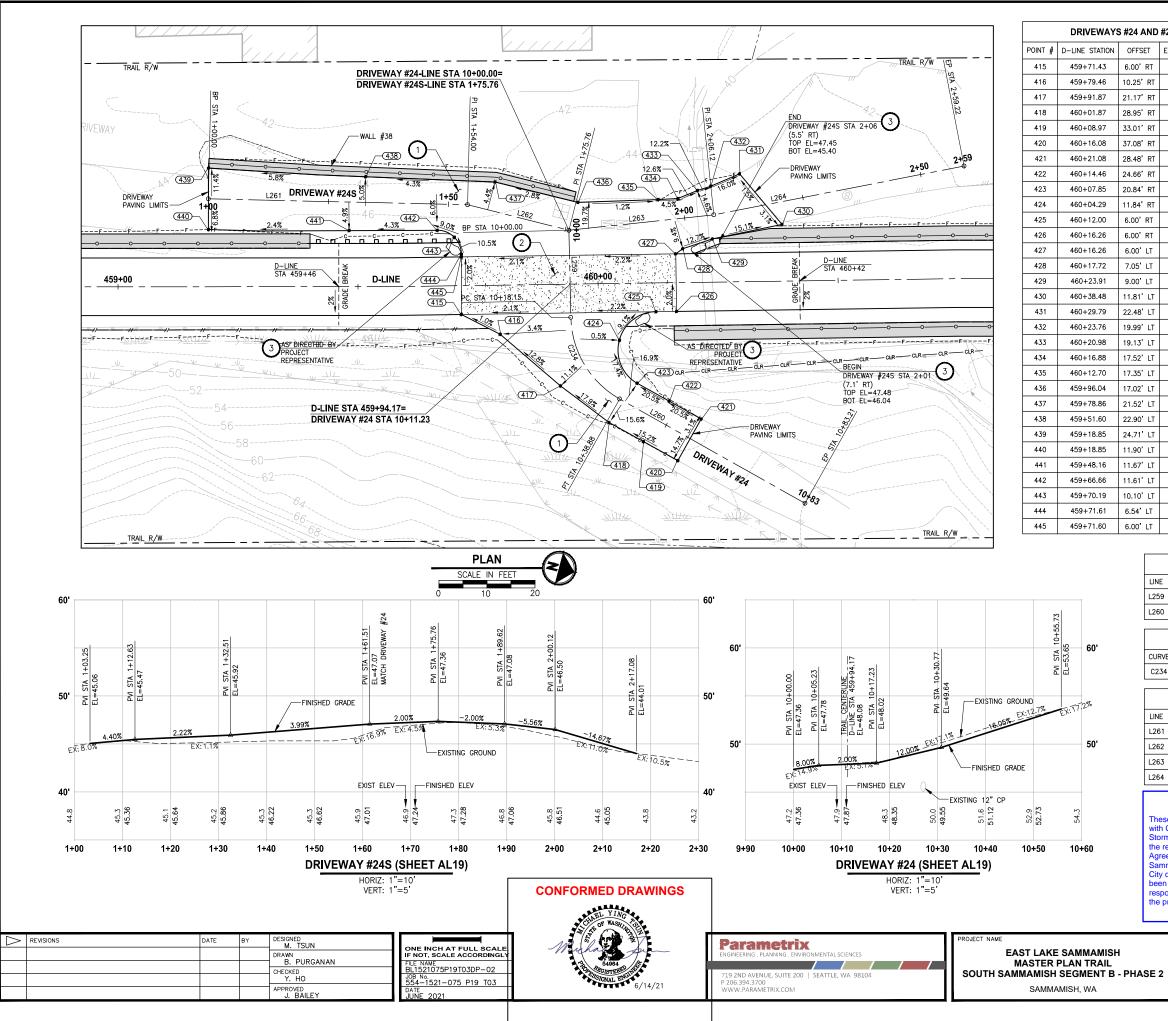

OFFSET ELEVATION DESCRIPTION 6.00' RT 47.90 CONC-ASPH 10.25' RT 47.99 AP 21.17' RT 50.10 AP 28.95' RT 51.92 AP 33.01' RT 53.16 CONTROL POINT 37.08' RT 54.42 ME-ASPH 28.46' RT 53.49 ME-ASPH	
10.25' RT 47.99 AP 21.17' RT 50.10 AP 28.95' RT 51.92 AP 33.01' RT 53.16 CONTROL POINT 37.08' RT 54.42 ME-ASPH	
21.17' RT 50.10 AP 28.95' RT 51.92 AP 33.01' RT 53.16 CONTROL POINT 37.08' RT 54.42 ME-ASPH	
28.95' RT 51.92 AP 33.01' RT 53.16 CONTROL POINT 37.08' RT 54.42 ME-ASPH	
33.01' RT 53.16 CONTROL POINT 37.08' RT 54.42 ME-ASPH	
37.08' RT 54.42 ME-ASPH	
28.48' RT 53.49 ME-ASPH	
24.66' RT 51.92 CONTROL POINT	
20.84' RT 50.35 CURVE PT	
11.84' RT 48.63 CURVE MIDPOINT	
6.00' RT 47.81 CURVE PC-CONC-A	SPH
6.00' RT 47.72 CONC-ASPH	
6.00' LT 47.48 CONC-ASPH	
7.05' LT 47.22 AP	
9.00' LT 46.40 AP	
11.81' LT 44.18 ME-ASPH	
22.48' LT 43.88 ME-ASPH	
19.99' LT 44.93 AP-ASPH	
19.13' LT 45.30 AP-ASPH	
17.52' LT 45.83 AP-ASPH	
17.35' LT 46.03 ME-GRADE BREAK	
17.02' LT 46.23 ME-AP	
21.52' LT 46.68 AP	
22.90' LT 45.68 CONTROL POINT	
24.71' LT 44.11 ME-ASPH	
11.90' LT 45.23 ME-ASPH	
11.67' LT 46.13 CONTROL POINT	
11.61' LT 46.83 CURVE PC	
10.10' LT 47.21 CURVE MIDPOINT	
6.54' LT 47.64 CURVE PT	
6.00' LT 47.66 CONC-ASPH	

CONSTRUCTION NOTES:

1 HMA DRIVEWAY PAVEMENT SECTION SHALL BE 4" HMA CL 1/2 PG 64-22 OVER 8" CRUSHED SURFACING BASE COURSE.

2 PATTERNED CONCRETE INTERSECTION, SEE



3 ROCK WALL, SEE MD1



LEGEND:



PATTERNED CONCRETE DRIVEWAY

GRAVEL DRIVEWAY

	DRIVEWAY #24 LINE TABLE										
LINE LENGTH BEARING BEGIN EASTING BEGIN NORTHING END EASTING END NORTHING											
L259	18.15	N74°03'56"E	1335702.75	228758.65	1335720.20	228763.63					
L260	44.33	N14 40' 13"E	1335734.06	228777.80	1335745.29	228820.68					

	DRIVEWAY #24 CURVE TABLE										
CURVE	LENGTH	RADIUS	DELTA	BEGIN EASTING	BEGIN NORTHING	END EASTING	END NORTHING				
C234	20.73	20.00	59 ° 23'42"	1335720.20	228763.63	1335734.06	228777.80				

DRIVEWAY #24S LINE TABLE								
LINE	LENGTH	BEARING	BEGIN EASTING	BEGIN NORTHING	END EASTING	END NORTHING		
L261	54.00	N13 25'14"W	1335715.50	228684.36	1335702.96	228736.89		
L262	21.76	NO 33' 34"W	1335702.96	228736.89	1335702.75	228758.65		
L263	30.36	N20° 46' 37"W	1335702.75	228758.65	1335691.98	228787.03		
L264	53.10	N25 45'13"W	1335691.98	228787.03	1335668.91	228834.86		

CITY OF SAMMAMISH PUBLIC WORKS DEVELOPMENT REVIEW These drawings have been reviewed for compliance with City of Sammamish Clearing and Grading and Stormwater requirements and also in accordance with the requirements as established in the Settlement greement between King County vs. City of Sammamish No. C17-0921 JCC and King County vs City of Sammamish No. 17-2-29922-7 SEA and have een deemed ACCEPTABLE. The reviewer accepts esponsibility for any errors and/or omissions made by

17 February 2022

the preparer of these drawings.

CITY OF SAMMAMISH APPROVAL

Community Developme

City Engineer


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Date

Date

DRIVEWAY PLAN AND PROFILE

108 OF 213 **DP15**

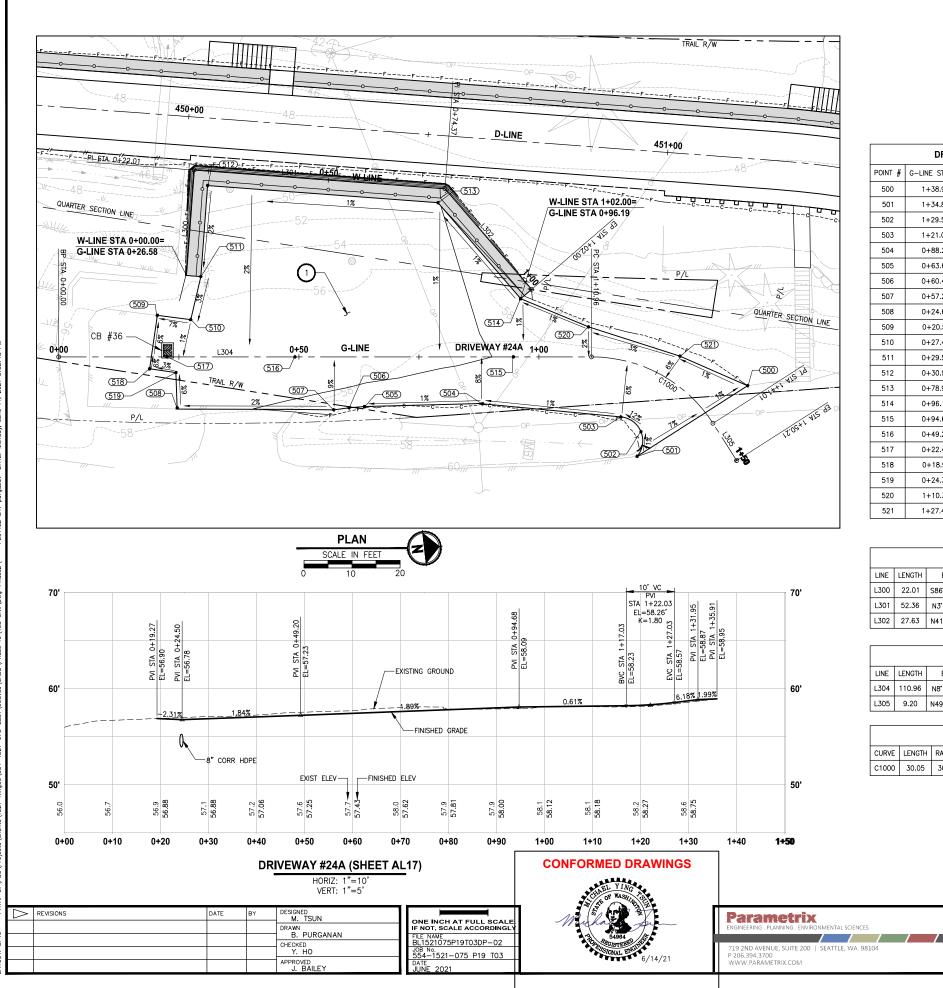

DRIVEWAY #24A POINT TABLE							
POINT #	POINT # G-LINE STATION OFFSET ELEVATION DESC						
500	1+38.99	10.40' LT	58.84	ME-ASPH			
501	1+34.82	16.73' RT	60.24	ME-ASPH-CURVE PC			
502	1+29.55	12.31'RT	59.65	CURVE MIDPOINT			
503	1+21.06	11.47'RT	58.94	CURVE PT			
504	0+88.20	9.79'RT	58.76	AP-ASPH			
505	0+63.65	10.35' RT	58.45	CURVE PC			
506	0+60.44	10.60' RT	58.40	CURVE MIDPOINT			
507	0+57.25	11.02' RT	58.36	ME-CURVE PT			
508	0+24.68	10.62' RT	57.66	ME-ASPH			
509	0+20.51	8.64'LT	56.35	ME-ASPH			
510	0+27.47	7.76'LT	56.85	AP-ASPH			
511	0+29.57	16.73'LT	57.10	AP-ASPH			
512	0+30.99	35.69' LT	57.48	AP-ASPH			
513	0+78.97	32.10' LT	57.99	AP-ASPH			
514	0+96.19	12.10' LT	58.25	AP-ASPH			
515	0+94.68	0.00'T	58.09	FL-CONTROL POINT			
516	0+49.20	0.00'T	57.23	FL-CONTROL POINT			
517	0+22.49	0.00'T	56.74	FL-LOW POINT			
518	0+18.91	2.49' RT	57.06	ME-ASPH			
519	0+24.39	3.27'RT	57.22	ME-ASPH			
520	1+10.31	6.24'LT	58.33	AP-ASPH			
521	1+27.40	5.32'LT	58.85	AP-ASPH			

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W-LINE LINE TABLE						
LINE	LENGTH	BEARING	BEGIN EASTING	BEGIN NORTHING	END EASTING	END NORTHING
L300	22.01	S86 05' 22"W	1335968.04	227800.72	1335946.09	227799.22
L301	52.36	N3° 54' 38"W	1335946.09	227799.22	1335942.51	227851.46
L302	27.63	N41 05 22"E	1335942.51	227851.46	1335960.67	227872.28

	DRIVEWAY #24A LINE TABLE								
LINE	LENGTH	BEARING	BEGIN EASTING	BEGIN NORTHING	END EASTING				
L304	110.96	N8 11'05"W	1335988.61	227776.83	1335972.81				
L305	9.20	N49 12' 30"E	1335982.91	227913.64	1335989.87				

	DRIVEWAY #24A CURVE TABLE								
CURVE	LENGTH	RADIUS	DELTA	BEGIN EASTING	BEGIN NORTHING	END			
C1000	30.05	30.00	57°23'35"	1335972.81	227886.66	1335			

G	BEGIN EASTING	BEGIN NORTHING	END EASTING	G END NOP	RTHING				
22"W	1335968.04	227800.72	1335946.09	22779	9.22				
58"W	1335946.09	227799.22	1335942.51	22785	1.46				
22"E	1335942.51	227851.46	1335960.67	22787	2.28				
			-						
0	DRIVEWAY #2	4A LINE TABLE							
G	BEGIN EASTING	BEGIN NORTHING	END EASTING	END NOF	RTHING				
)5 " W	1335988.61	227776.83	1335972.81	22788	6.66				
30"E	1335982.91	227913.64	1335989.87	227919	9.65				
	DRIVEWAY #2	24A CURVE TAE	BLE						
DEL	TA BEGIN EAS	STING BEGIN NORT	HING END EA	ASTING ENI	D NORTHING				
57 23	3'35" 1335972	2.81 227886.6	6 13359	82.91 2	227913.64				
				These dra with City of Stormwate the require Agreemen Sammami City of Sai been deer responsibi	DEVEL wings have of Sammami er requireme ements as e ht between k ish No. C17- mmamish N med ACCEP ility for any e rer of these	WAMISH PUBLIC V OPMENT REVIEW been reviewed for ds sh Clearing and Gr ents and also in acc stablished in the Se ting County vs. City 0921 JCC and King 0. 17-2-29922-7 SE 'TABLE. The review rrors and/or omissi drawings. February 2022	compliance ading and ordance with of of og county vs. A and have wer accepts no	CITY OF SAMMAMISH City Engineer Community Development	APPROVAL Date Date
	MAS UTH SAMMA	LAKE SAMMA STER PLAN TR MISH SEGME SAMMAMISH, WA	AIL NT B - PHA	SE 2	DF	RIVEWAY	PLAN AN	ND PROFILE	SHEET NO. 109 OF 213 DP16

STING	END NORTHING
6.09	227799.22

STING	END	NORTHING	

LEGEND: PATTERNED CONCRETE DRIVEWAY


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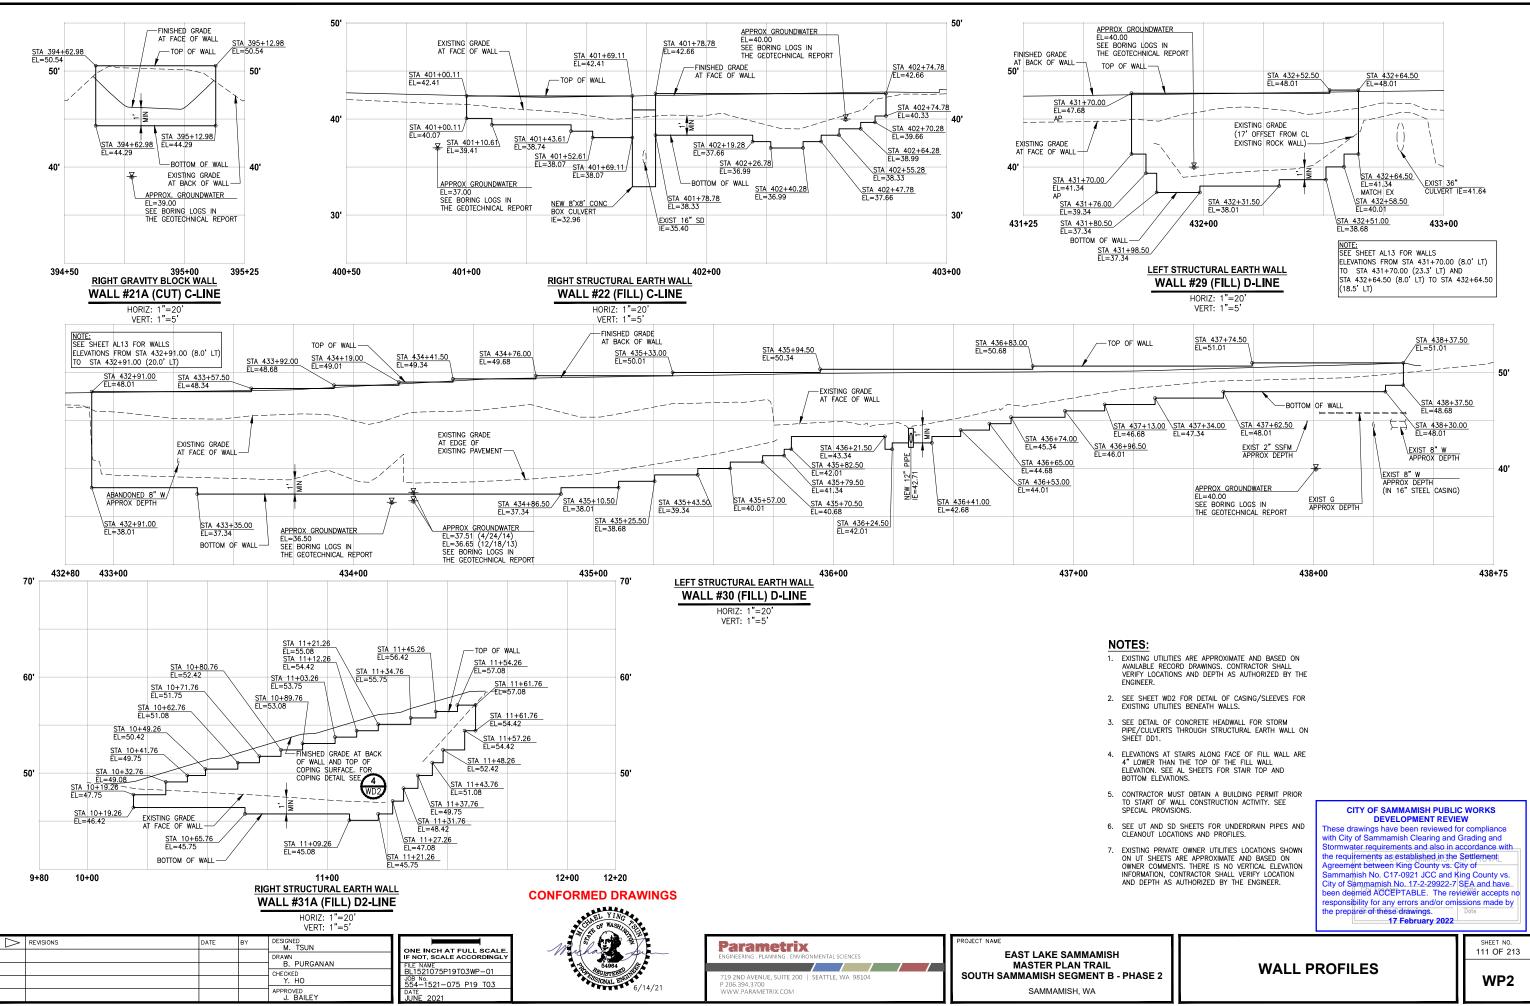
3 ROCK WALL, SEE


CONSTRUCTION NOTES:

GRAVEL DRIVEWAY





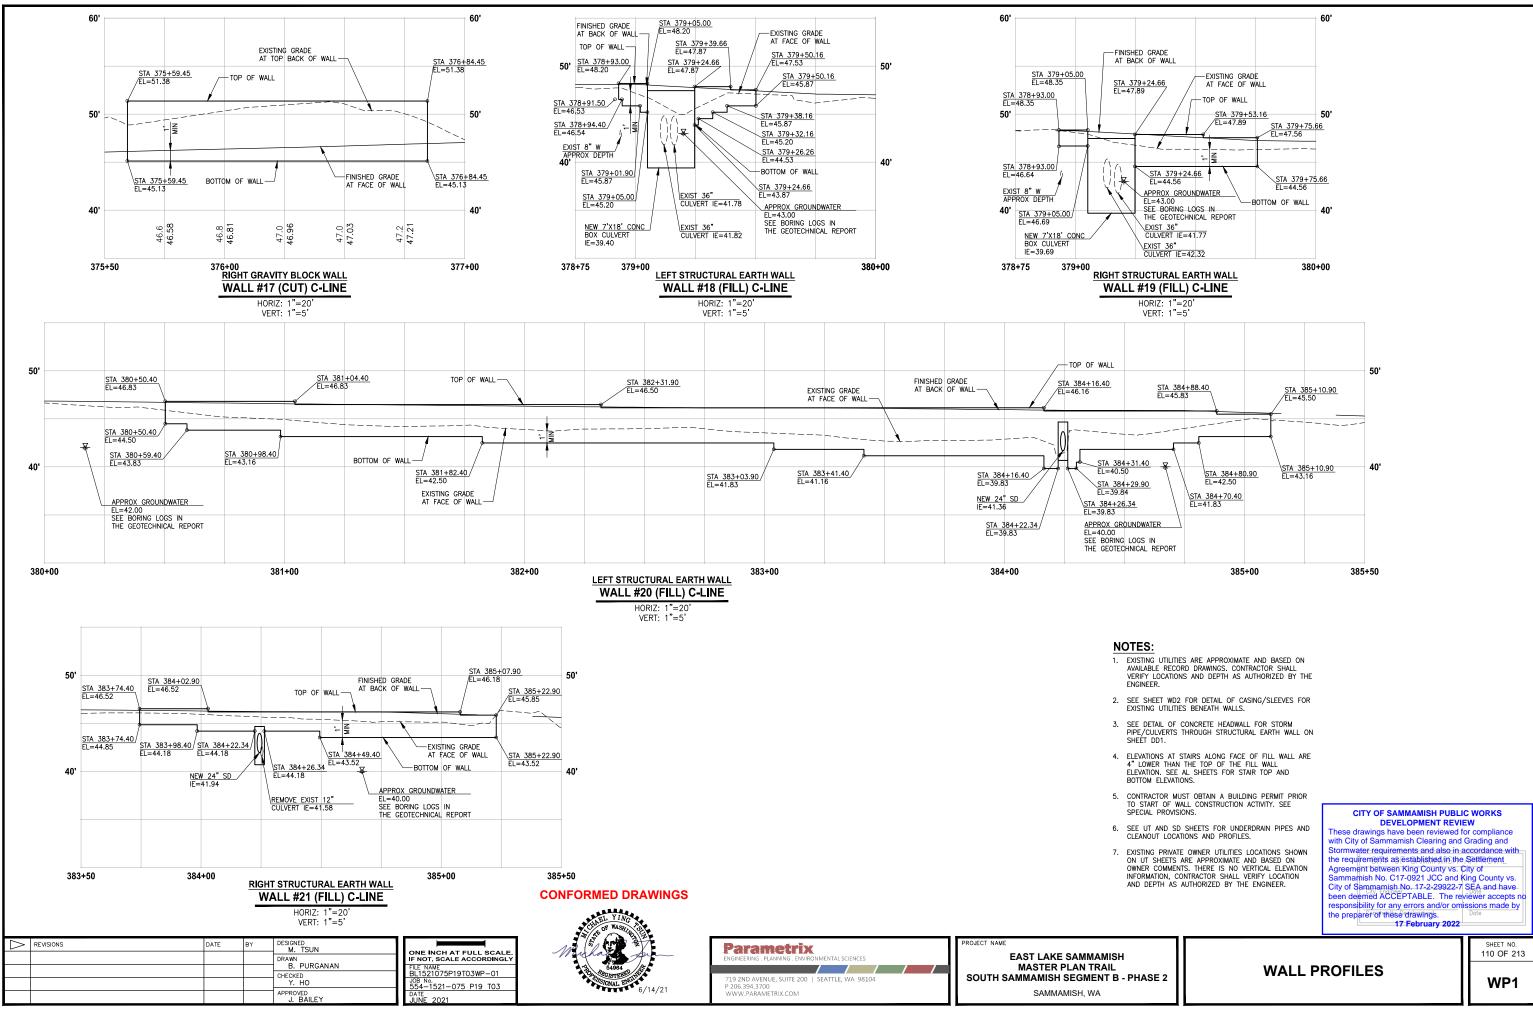


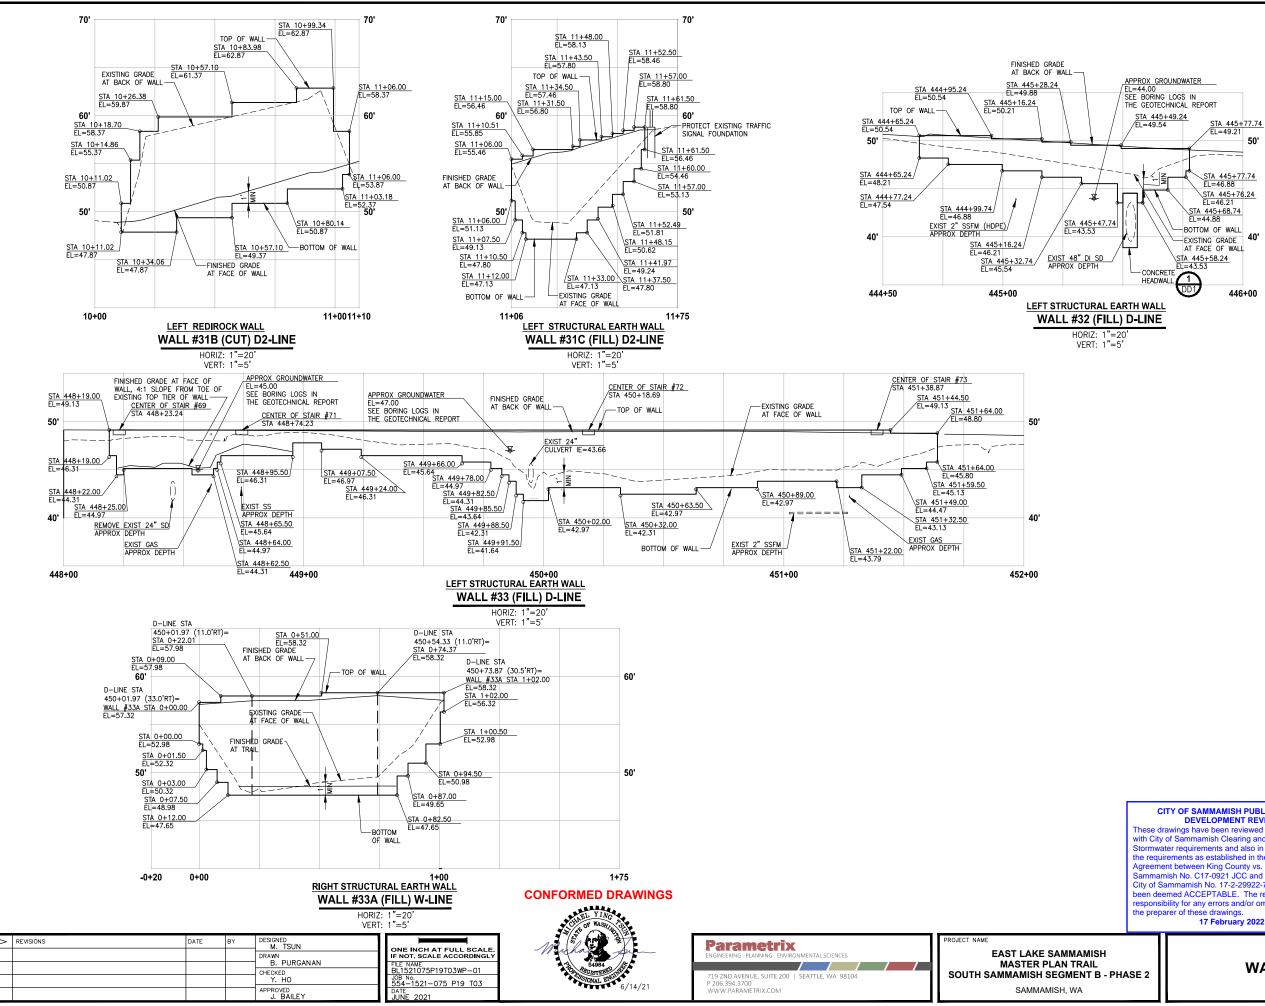


NOTES:

- EXISTING UTILITIES ARE APPROXIMATE AND BASED ON AVAILABLE RECORD DRAWINGS. CONTRACTOR SHALL VERIFY LOCATIONS AND DEPTH AS AUTHORIZED BY THE ENGINEER.
- 2. SEE SHEET WD2 FOR DETAIL OF CASING/SLEEVES FOR EXISTING UTILITIES BENEATH WALLS.
- SEE DETAIL OF CONCRETE HEADWALL FOR STORM PIPE/CULVERTS THROUGH STRUCTURAL EARTH WALL ON SHEET DD1.
- 4. ELEVATIONS AT STAIRS ALONG FACE OF FILL WALL ARE $4^{\prime\prime}$ LOWER THAN THE TOP OF THE FILL WALL ELEVATION. SEE AL SHEETS FOR STAIR TOP AND BOITOM ELEVATIONS.
- CONTRACTOR MUST OBTAIN A BUILDING PERMIT PRIOR TO START OF WALL CONSTRUCTION ACTIVITY. SEE SPECIAL PROVISIONS.
- 6. SEE UT AND SD SHEETS FOR UNDERDRAIN PIPES AND CLEANOUT LOCATIONS AND PROFILES.
- EXISTING PRIVATE OWNER UTILITIES LOCATIONS SHOWN ON UT SHEETS ARE APPROXIMATE AND BASED ON OWNER COMMENTS. THERE IS NO VERTICAL ELEVATION INFORMATION, CONTRACTOR SHALL VERIFY LOCATION AND DEPTH AS AUTHORIZED BY THE ENCINEER.

WALL PRO		ILES	WP3
			SHEET NO. 112 OF 213
These d with City Stormwa the requ Agreem Samma City of S been de respons	ITY OF SAMMAMISH PUBLIC WORKS DEVELOPMENT REVIEW awings have been reviewed for compliance of Sammamish Clearing and Grading and ter requirements and also in accordance with rements as established in the Settlement ent between King County vs. City of nish No. C17-0921 JCC and King County vs. ammamish No. 17-2-29922-7 SEA and have emed ACCEPTABLE. The reviewer accepts no bility for any errors and/or omissions made by arer of these drawings. 17 February 2022	CITY OF SAMMAMISH City Engineer Community Development	APPROVAL Date Date
		DEPTH AS AUTHORIZED BY THE EN	

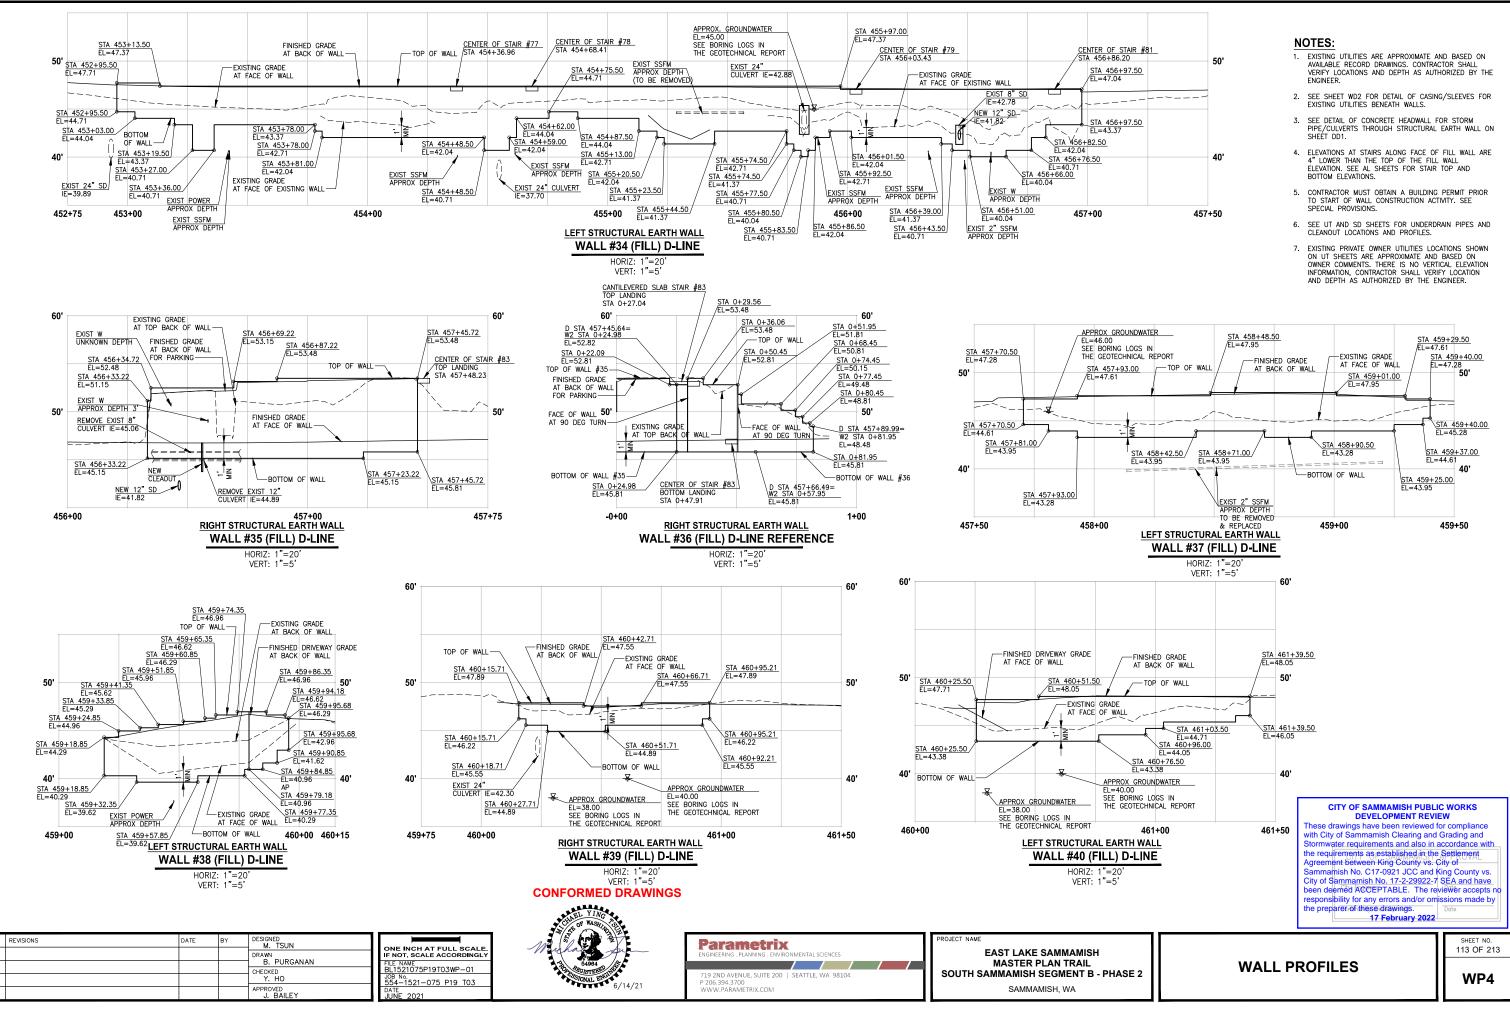

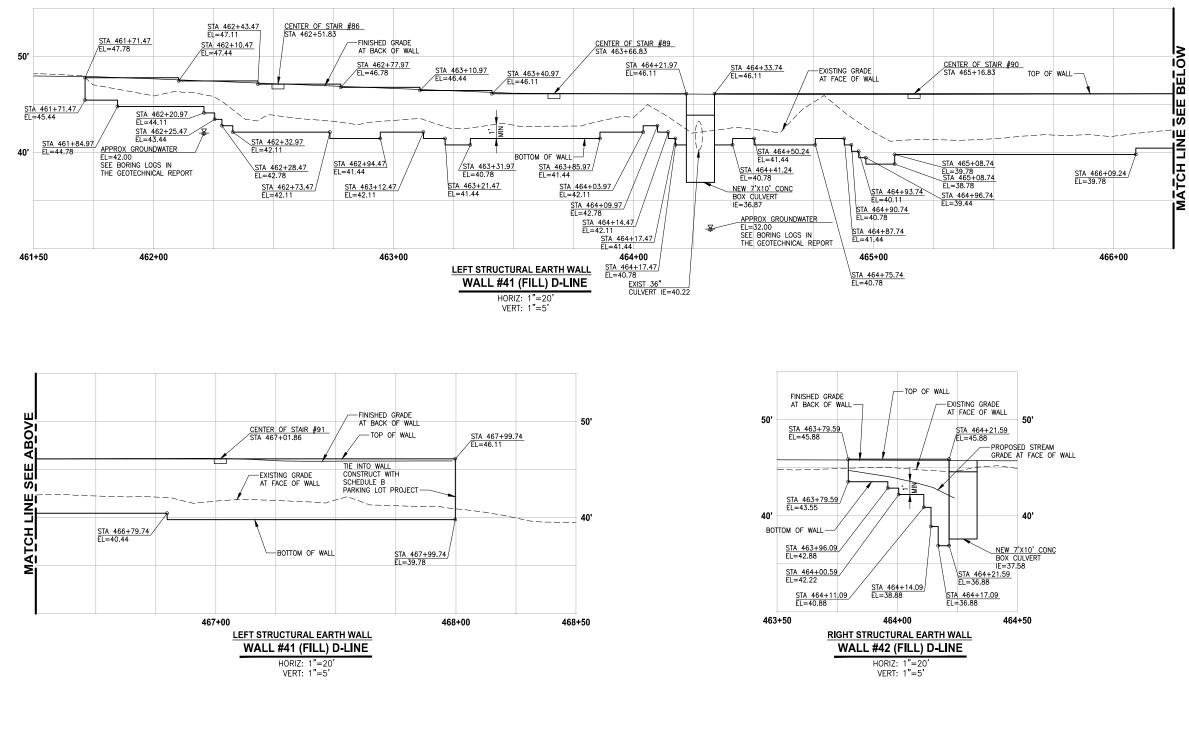

CONFORMED DRAWINGS





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				B. PURGANAN CHECKED	FILE NAME BL1521075P19T03WP-01
				Y. HO	JOB No. 554-1521-075 P19 T03
				APPROVED J. BAILEY	DATE JUNE 2021

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ASE 2	WALL PROFI	LES	SHEET NO. 114 OF 213
These of with City Stormw the requ Agreem Samma City of S been de respons	ITY OF SAMMAMISH PUBLIC WORKS DEVELOPMENT REVIEW rawings have been reviewed for compliance of Sammamish Clearing and Grading and ther requirements and also in accordance with irements as established in the Settlement ent between King County vs. City of nish No. C17-0921 JCC and King County vs. ammamish No. 17-2-29922-7 SEA and have emed ACCEPTABLE. The reviewer accepts no bility for any errors and/or omissions made by arer of these drawings. 17 February 2022	CITY OF SAMMAMISH City Engineer Community Development	APPROVAL Dote Dote



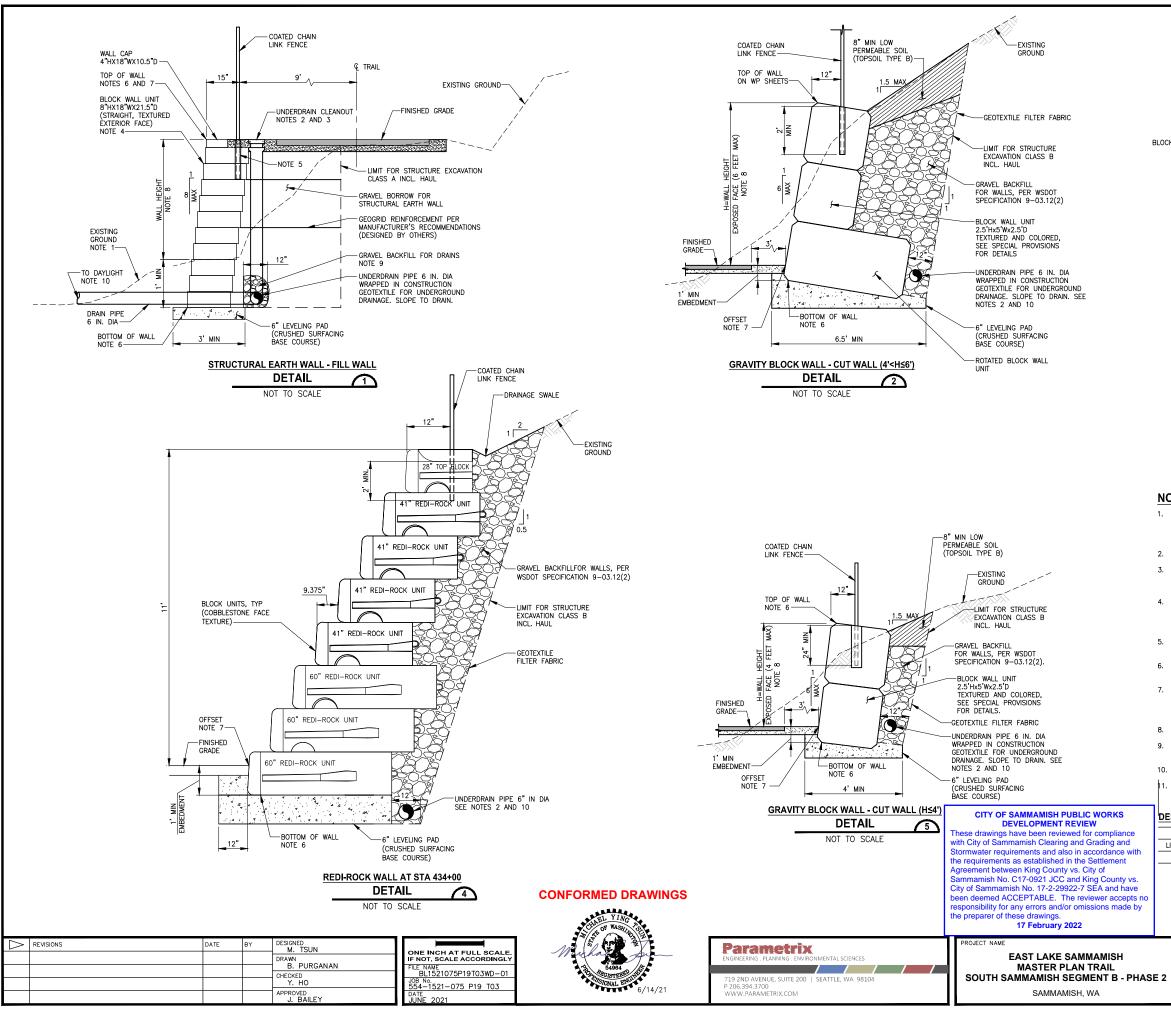

- 1. RESTORE DISTURBED EXISTING GROUND WITH NATIVE SOIL BACKFILL AND SEEDING, ANY LANDSCAPING SHALL BE OFFSET 2 FEET MIN FROM FACE OF WALL SEE SHEET LD1 FOR ADDITIONAL SETBACK REQUIREMENTS.
- 2. SEE UNDERDRAIN CLEANOUT DETAIL 6 ON SHEET DD1.
- 3. UNDERDRAIN CLEANOUT LIDS SHALL BE INSTALLED ALONG THE BACK OF WALL BLOCK AND SHALL NOT BE IN TRAIL HMA PAVEMENT.
- FILL BLOCK UNITS WITH UNIT DRAINAGE FILL. SEE SPECIAL PROVISIONS FOR WALL DESIGN REQUIREMENTS. ALL CONSTRUCTION MUST CONFORM TO MANUFACTURER'S SPECIFIC REQUIREMENTS.
- 5. POST SHALL HAVE MIN 24" DEPTH. SEE DETAIL 3 THIS SHEET FOR FENCE POST PLACEMENT.
- 6. SEE WP SHEETS FOR TOP AND BOTTOM OF WALL ELEVATIONS.
- 7. FOR FILL WALLS, OFFSET DISTANCE IS AT THE OUTSIDE EDGE OF THE CAP BLOCK PER DETAIL 1. FOR CUT WALLS, OFFSET DISTANCE IS AT THE BOTTOM OF EXPOSED WALL FACE PER DETAIL 2 THIS SHEET.
- 8. SEE WALL SCHEDULE ON SHEET WD3.
- GRAVEL BACKFILL FOR DRAINS MUST BE CLEAN AND FREE DRAINING, PER WSDOT SPECIFICATION 9-03.12(4).
- 10. SEE UT SHEETS FOR WALL DRAIN OUTFALL LOCATIONS.
- . SEE DD SHEET FOR CONCRETE HEADWALL AND SLEEVE FOR UTILITY PIPES.

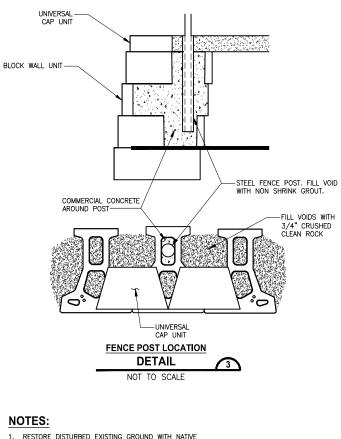DESIGN LOAD FOR FILL WALLS

LIVELOAD FOR TRAIL	100 PSF
LIVELOAD FOR DRIVEWAY/PARKING	250 PSF
DEADLOAD	NONE

VS.
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CITY	OF	SAMMAMISH	APPROVAL

Date

Date

Community Developme


City Engineer



WALL DETAILS

SHEET 115 OF 213

WD1

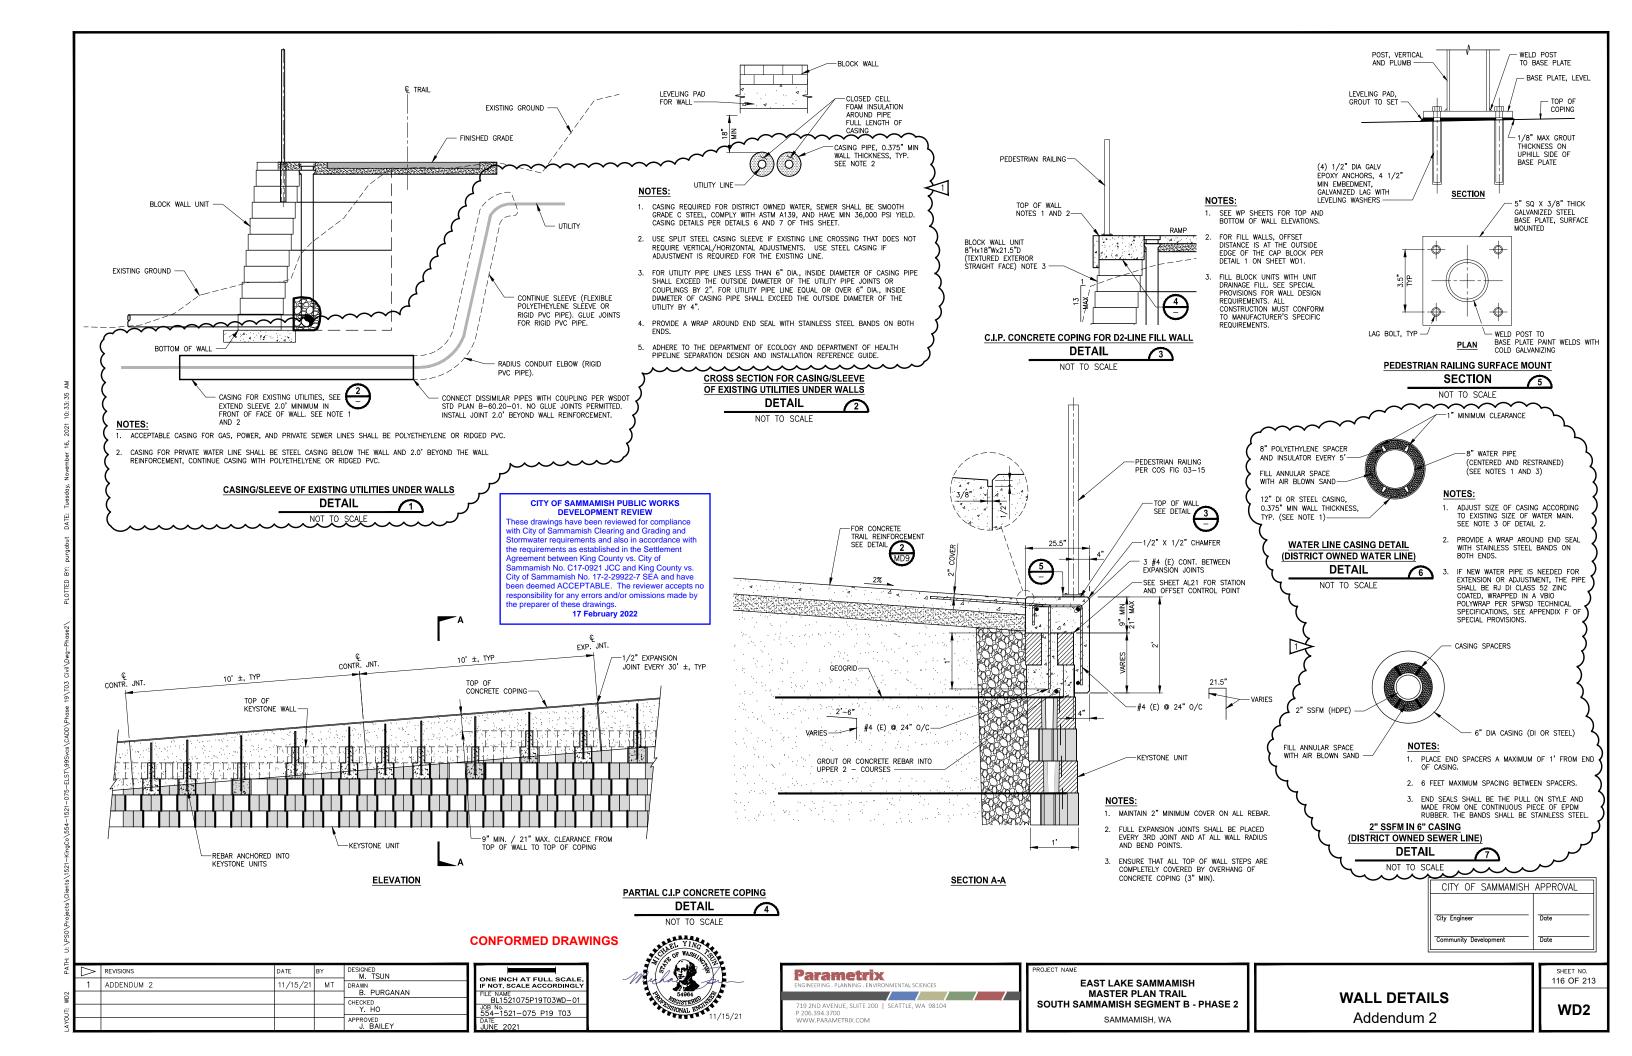

WALL SCHEDULE

WALL #	ALIGNMENT	BEGIN STA	END STA	SIDE	EXPOSED WALL HEIGHT RANGE	FILL/CUT	TYPE	NOTE
WALL 17	C-LINE	375+59.45	376+84.45	RT	4.2'-5.1'	СИТ	GBW	TEMPORARY CUT SLOPE 1.5H:1V
WALL 18	C-LINE	378+93	379+49.66	LT	0.3'-2.6'	FILL	SEW	
WALL 19	C-LINE	378+93	379+75.16	RT	0'-1.6'	FILL	SEW	
WALL 20	C-LINE	380+50.40	385+10.90	LT	0.5'-4.5'	FILL	SEW	
WALL 21	C-LINE	383+74.40	385+22.90	RT	0'-1.1'	FILL	SEW	
WALL 21A	C-LINE	394+62.98	395+12.98	RT	1.4'-4.5'	СИТ	GBW	REST STOP, TEMPORARY CUT SLOPE 1.5H:1V
WALL 22	C-LINE	401+00.11	402+74.78	RT	0.4'-3.7'	FILL	SEW	
WALL 29	D-LINE	431+70	432+64.50	LT	5.5'-10.4'	FILL	SEW	
WALL 30	D-LINE	432+91	438+37.5	LT	1.0'-10.4'	FILL	SEW	
WALL 31A	D2-LINE	10+19.26	11+61.76	RT	2'-11'	FILL	SEW	WALKWAY
WALL 31B	D2-LINE	10+11.02	11+06	LT	2'-10.5'	CUT	REDIROCK	WALKWAY, TEMPORARY CUT SLC 0.5H:1V
WALL 31C	D2-LINE	11+06	11+61.5	LT	3.7'-9.4'	FILL	SEW	WALKWAY
WALL 32	D-LINE	444+65.24	445+77.74	LT	0.8'-3.1'	FILL	SEW	
WALL 33	D-LINE	448+19	451+64	LT	1.0'-6.0'	FILL	SEW	
WALL 33A	D-LINE REF.	450+01.97	450+73.87	RT	1.6'-11'	FILL	SEW	PARKING, REFERENCE ALIGNMEN
WALL 34	D-LINE	452+95.50	456+97.50	LT	1.6'-5.8'	FILL	SEW	
WALL 35	D-LINE	456+33.22	457+45.72	RT	5.5'-5.7'	FILL	SEW	
WALL 36	D-LINE REF.	457+45.63	457+89.99	RT	1.3'-6.5'	FILL	SEW	STAIR #83, W2-LINE REFERENC
WALL 37	D-LINE	457+70.50	459+40	LT	0.7'-3.3'	FILL	SEW	
WALL 38	D-LINE	459+18.85	459+95.35	LT	0'-5.3'	FILL	SEW	DRIVEWAY #24
WALL 39	D-LINE	460+15.71	460+95.21	RT	0'-1.5'	FILL	SEW	
WALL 40	D-LINE	460+25.50	461+39.50	LT	0.3'-3.5'	FILL	SEW	
WALL 41	D-LINE	461+71.47	467+99.74	LT	0'-5.0'	FILL	SEW	
WALL 42	D-LINE	463+79.59	464+21.59	RT	0.8'-1.3'	FILL	SEW	

DESIGNED M. TSUN

DRAWN B. PURGANAN CHECKED

APPROVED J. BAILEY

DATE

CONFORMED DRAWINGS


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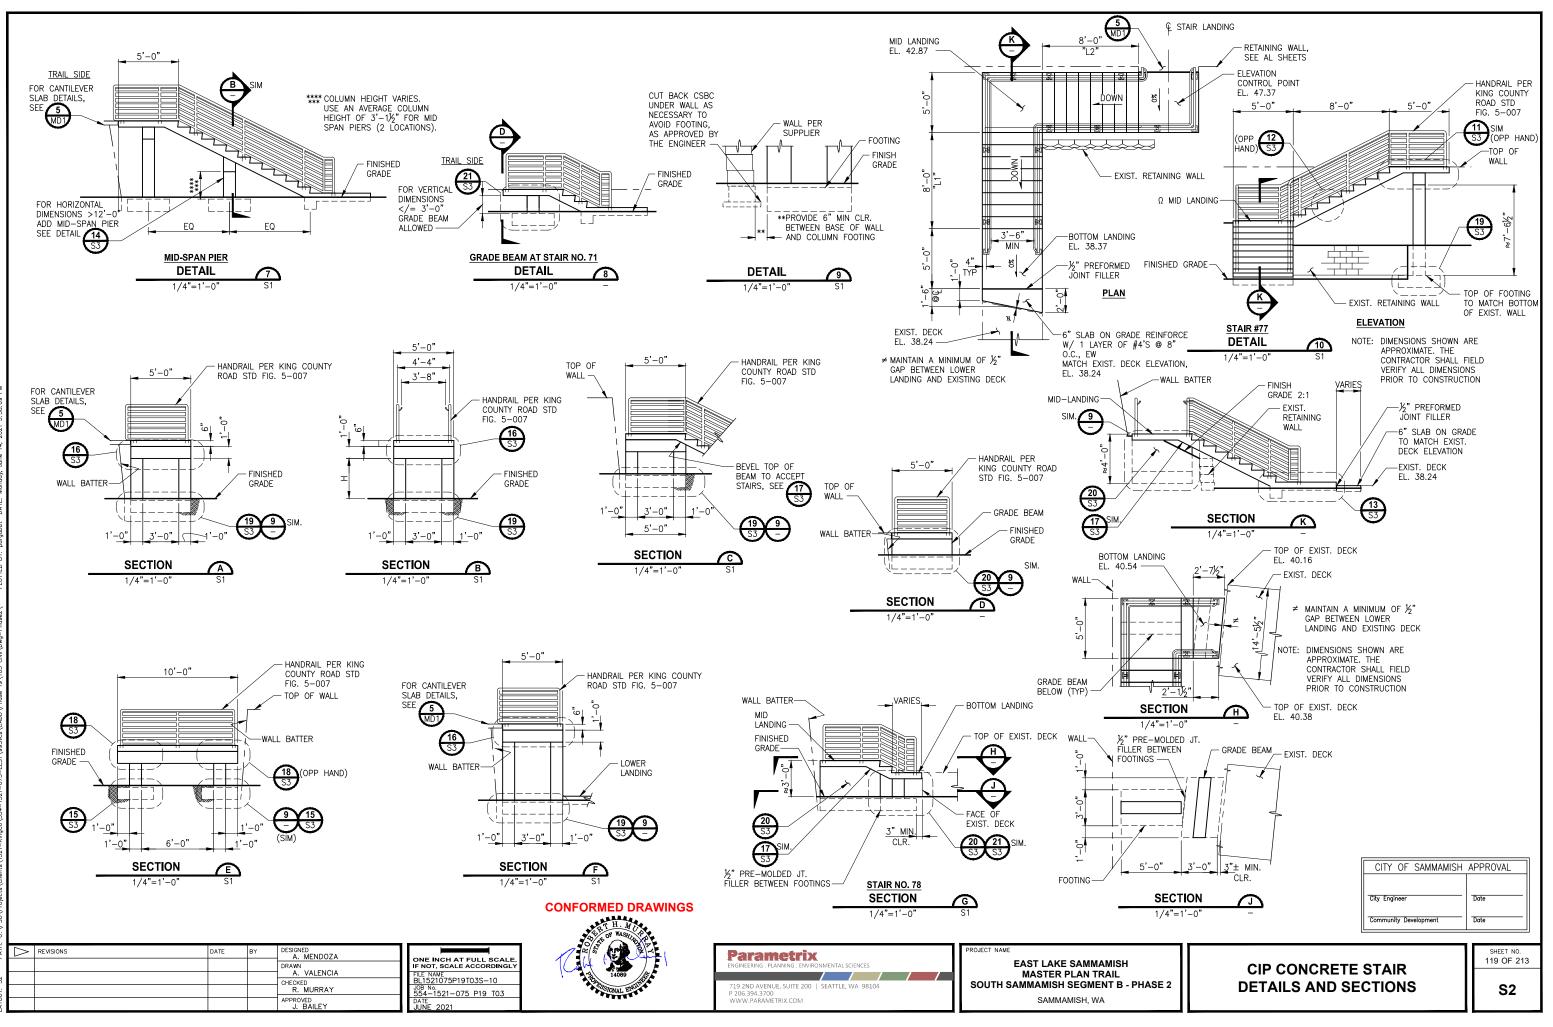
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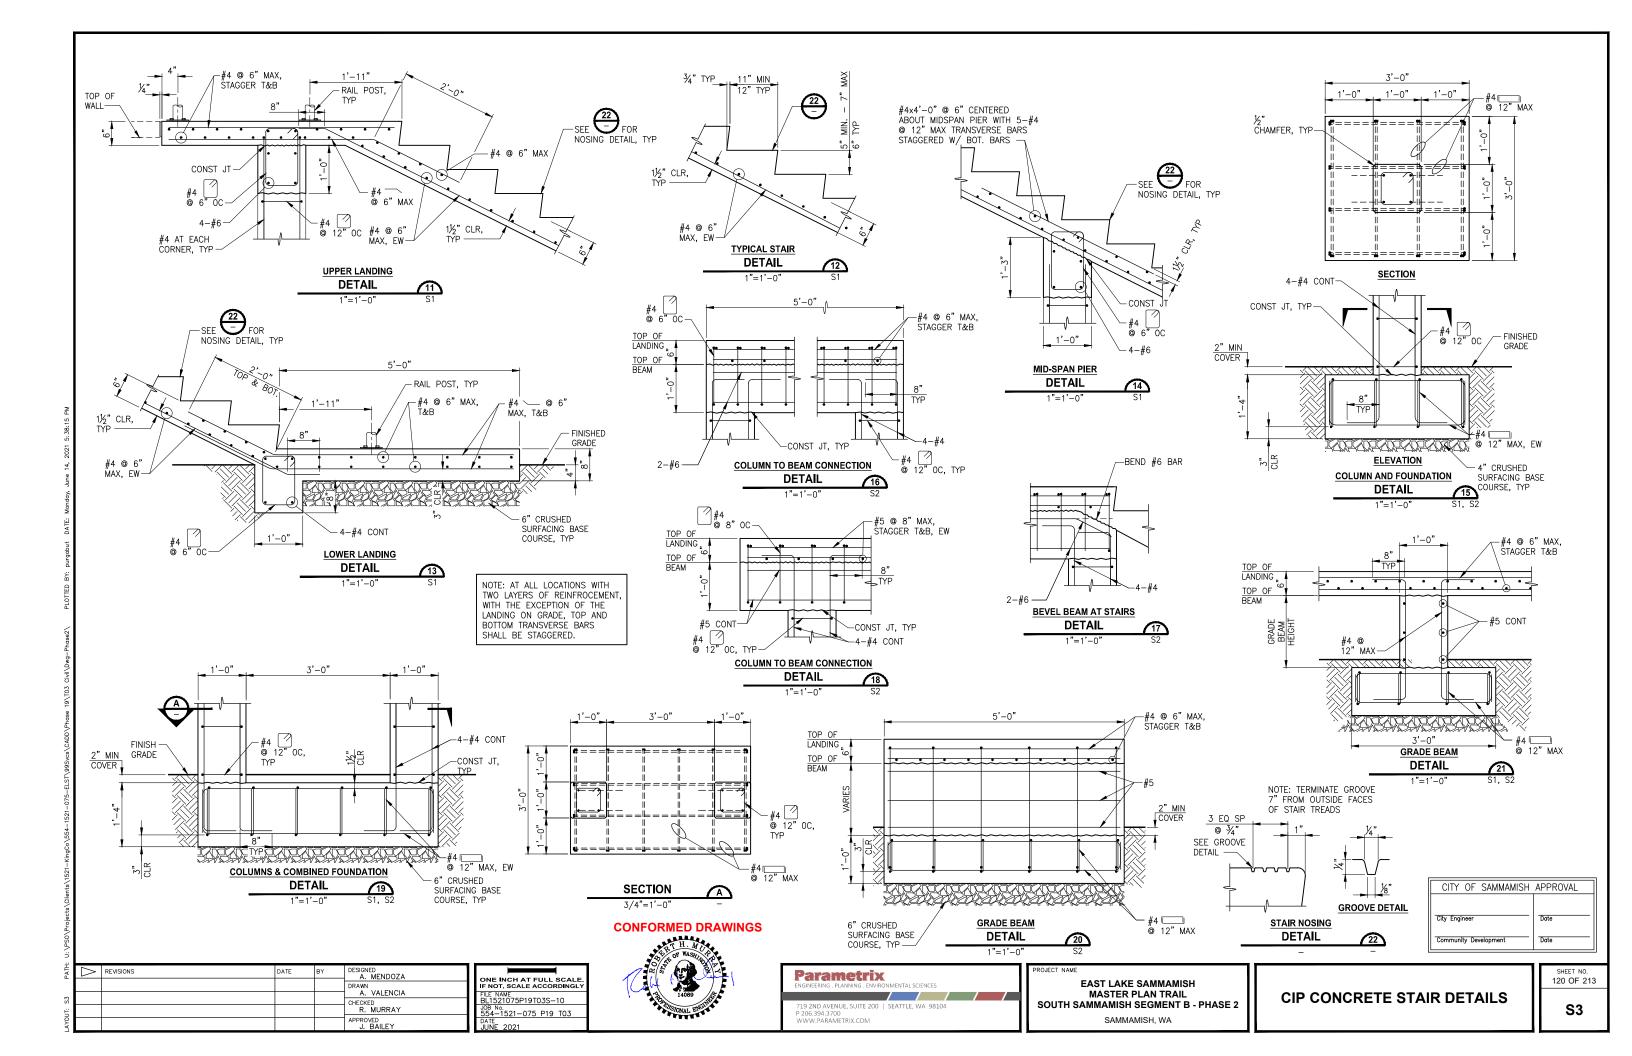
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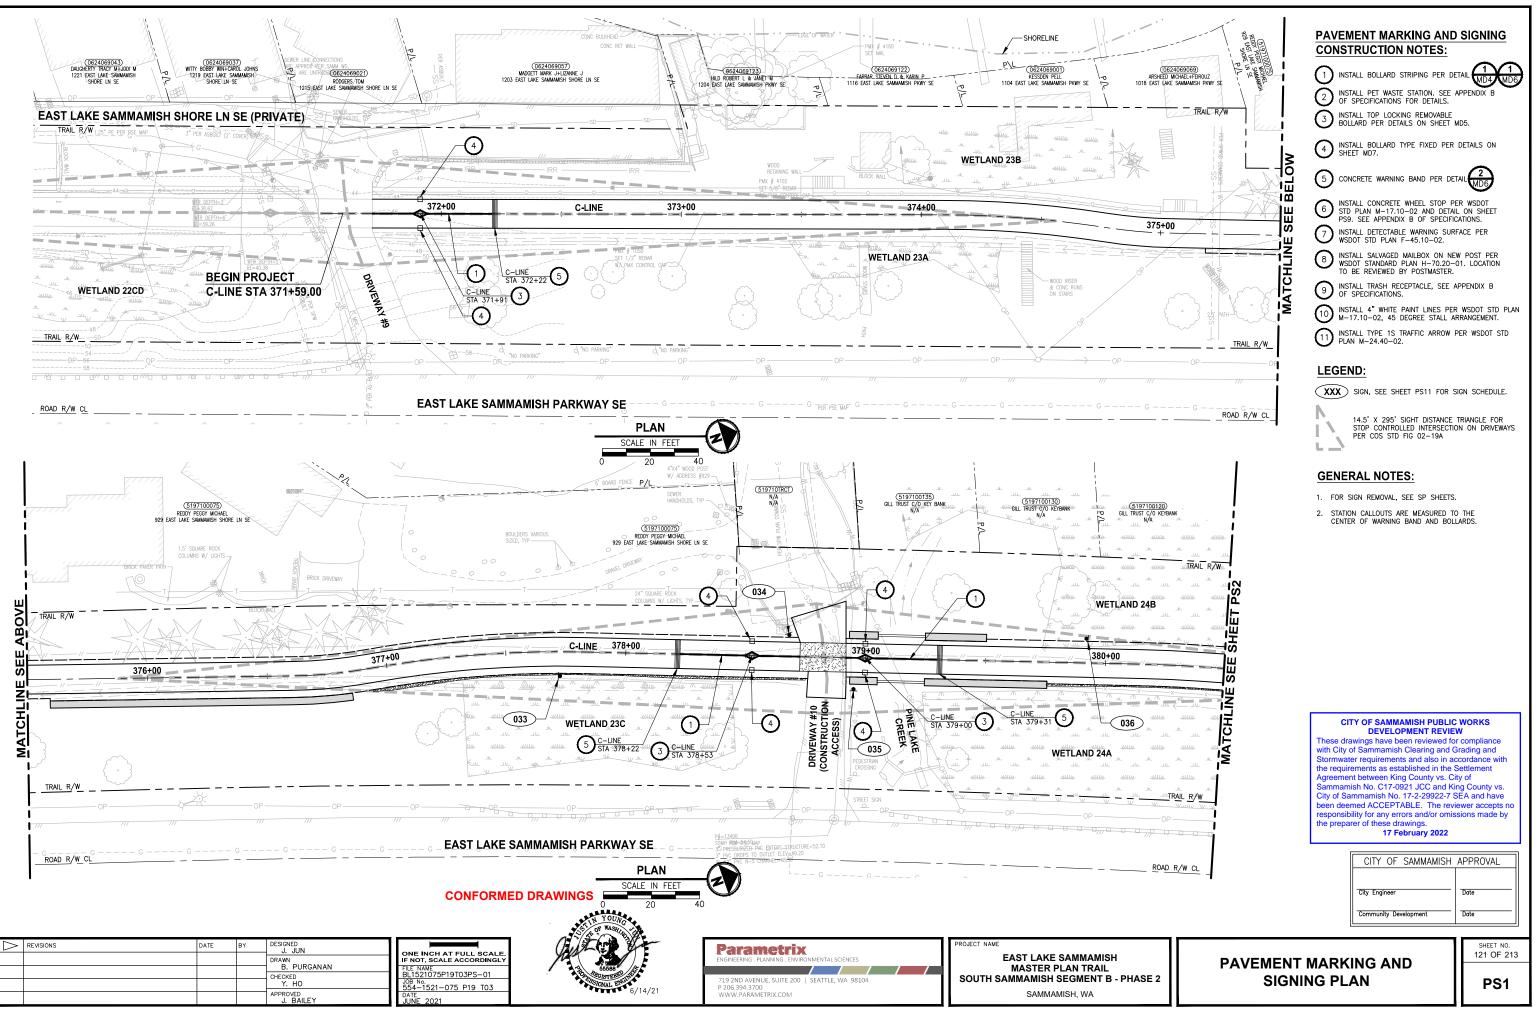
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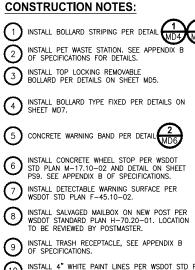
CITY OF SAMMAMISH PUBLIC WORKS DEVELOPMENT REVIEW These drawings have been reviewed for compliance with City of Sammamish Clearing and Grading and Stormwater requirements and also in accordance with the requirements as established in the Settlement Agreement between King County vs. City of Sammamish No. C17-0921 JCC and King County vs. City of Sammamish No. 17-229922-7 SEA and have been deemed ACCEPTABLE. The reviewer accepts no responsibility for any errors and/or omissions made by the preparer of these drawings. 17 February 2022 CITY OF SAMMAMISH APPROVAL City Engineer Date Community Development Date SHEET NO. 117 OF 213 WALL SCHEDULE WD3












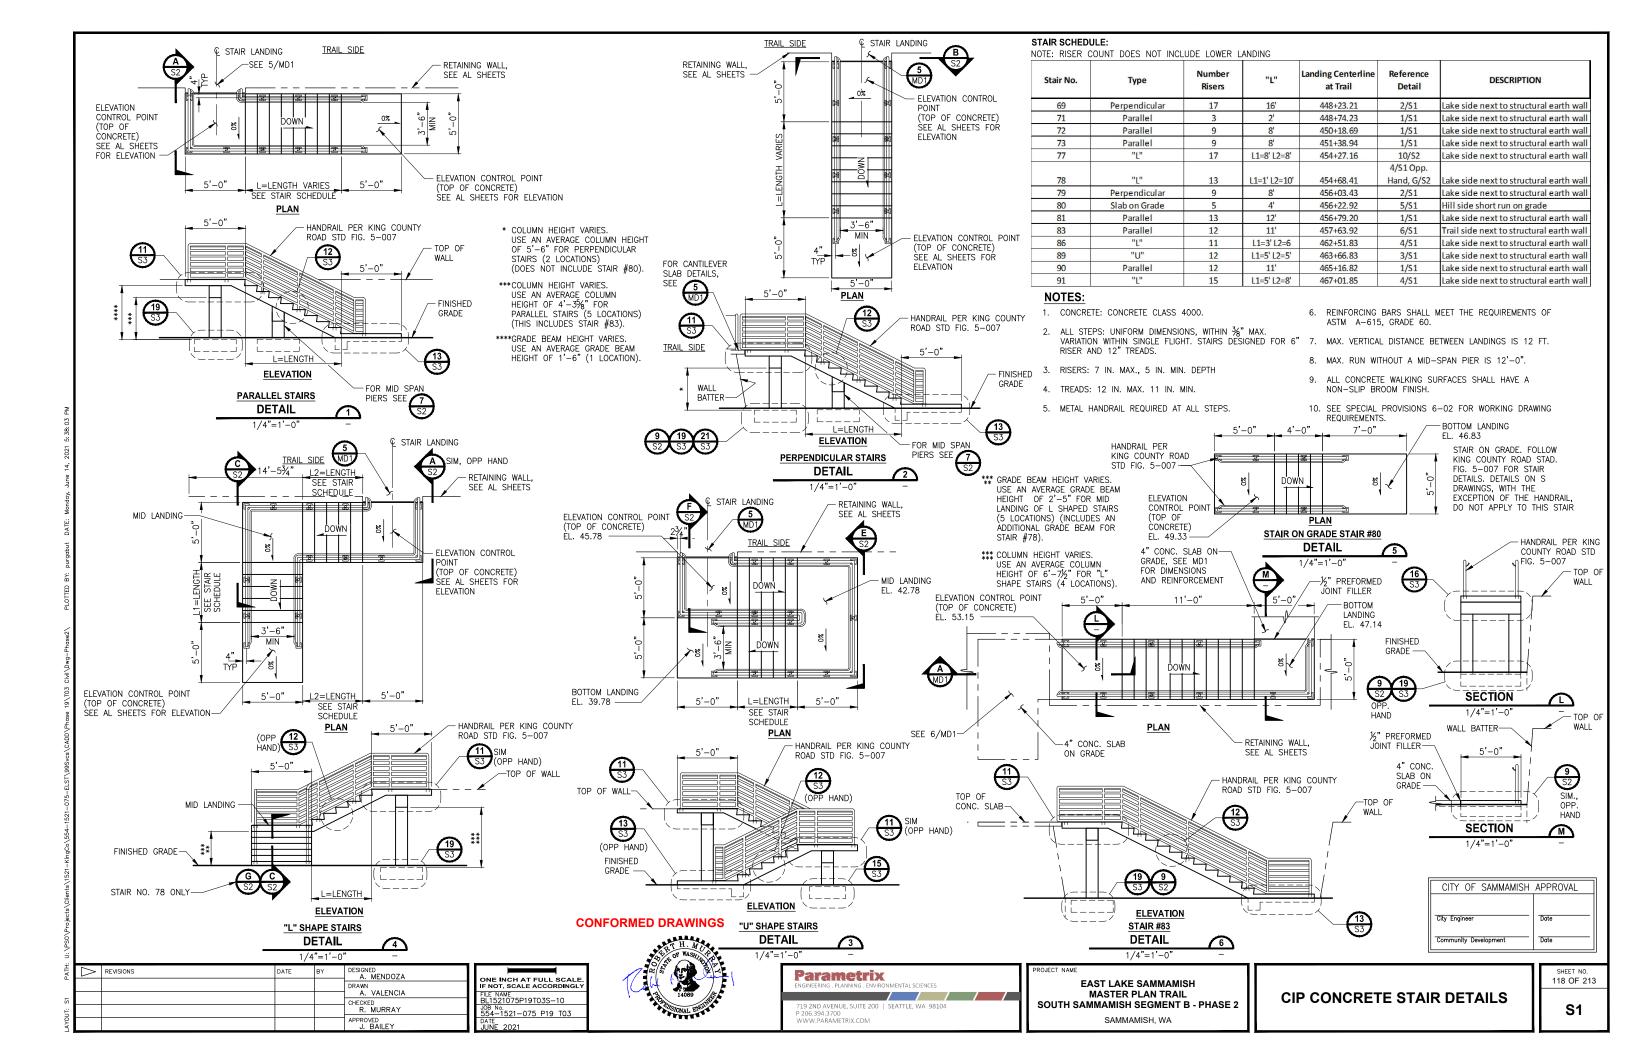



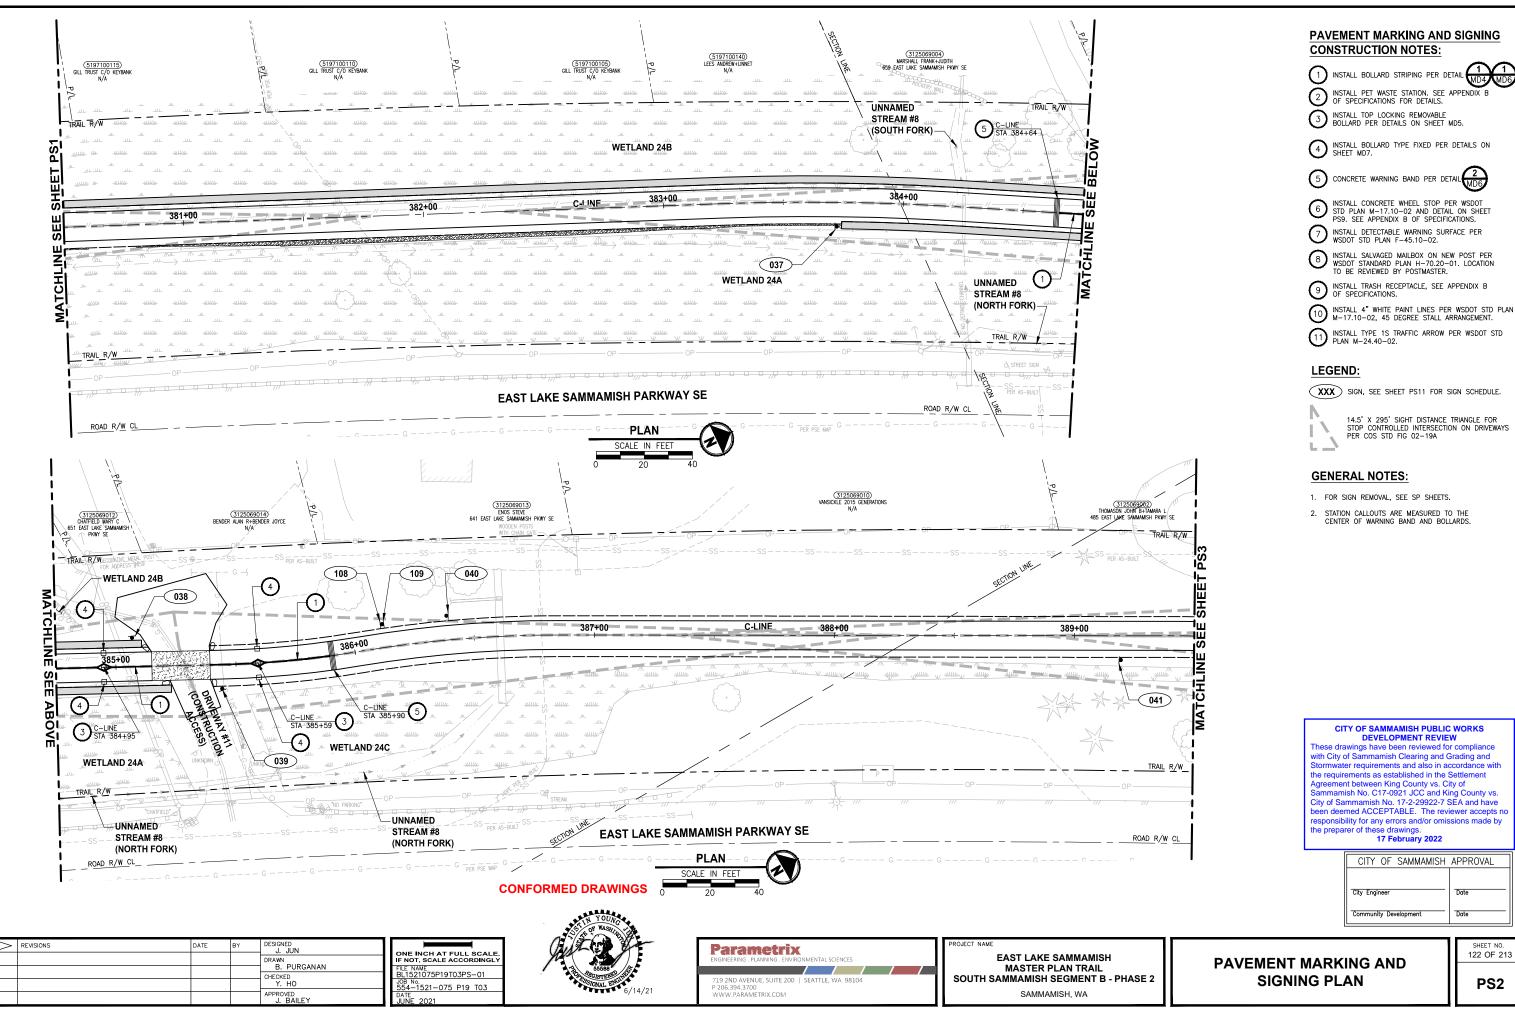

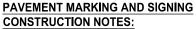

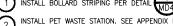

- (4) INSTALL BOLLARD TYPE FIXED PER DETAILS ON SHEET MD7.
- 5 CONCRETE WARNING BAND PER DETAIL
- DINSTALL DETECTABLE WARNING SURFACE PER WSDOT STD PLAN F-45.10-02.
- (8) INSTALL SALVAGED MAILBOX ON NEW POST PER WSDOT STANDARD PLAN H-70.20-01. LOCATION TO BE REVIEWED BY POSTMASTER.
- (9) INSTALL TRASH RECEPTACLE, SEE APPENDIX B OF SPECIFICATIONS.
- 10 Install 4" white paint lines per wSDOT STD plan M-17.10-02,~45 degree stall arrangement.
- (1) INSTALL TYPE 1S TRAFFIC ARROW PER WSDOT STD PLAN M-24.40-02.

XXX SIGN, SEE SHEET PS11 FOR SIGN SCHEDULE.



14.5' X 295' SIGHT DISTANCE TRIANGLE FOR STOP CONTROLLED INTERSECTION ON DRIVEWAYS PER COS STD FIG 02-19A

- 1. FOR SIGN REMOVAL, SEE SP SHEETS.
- 2. STATION CALLOUTS ARE MEASURED TO THE CENTER OF WARNING BAND AND BOLLARDS.


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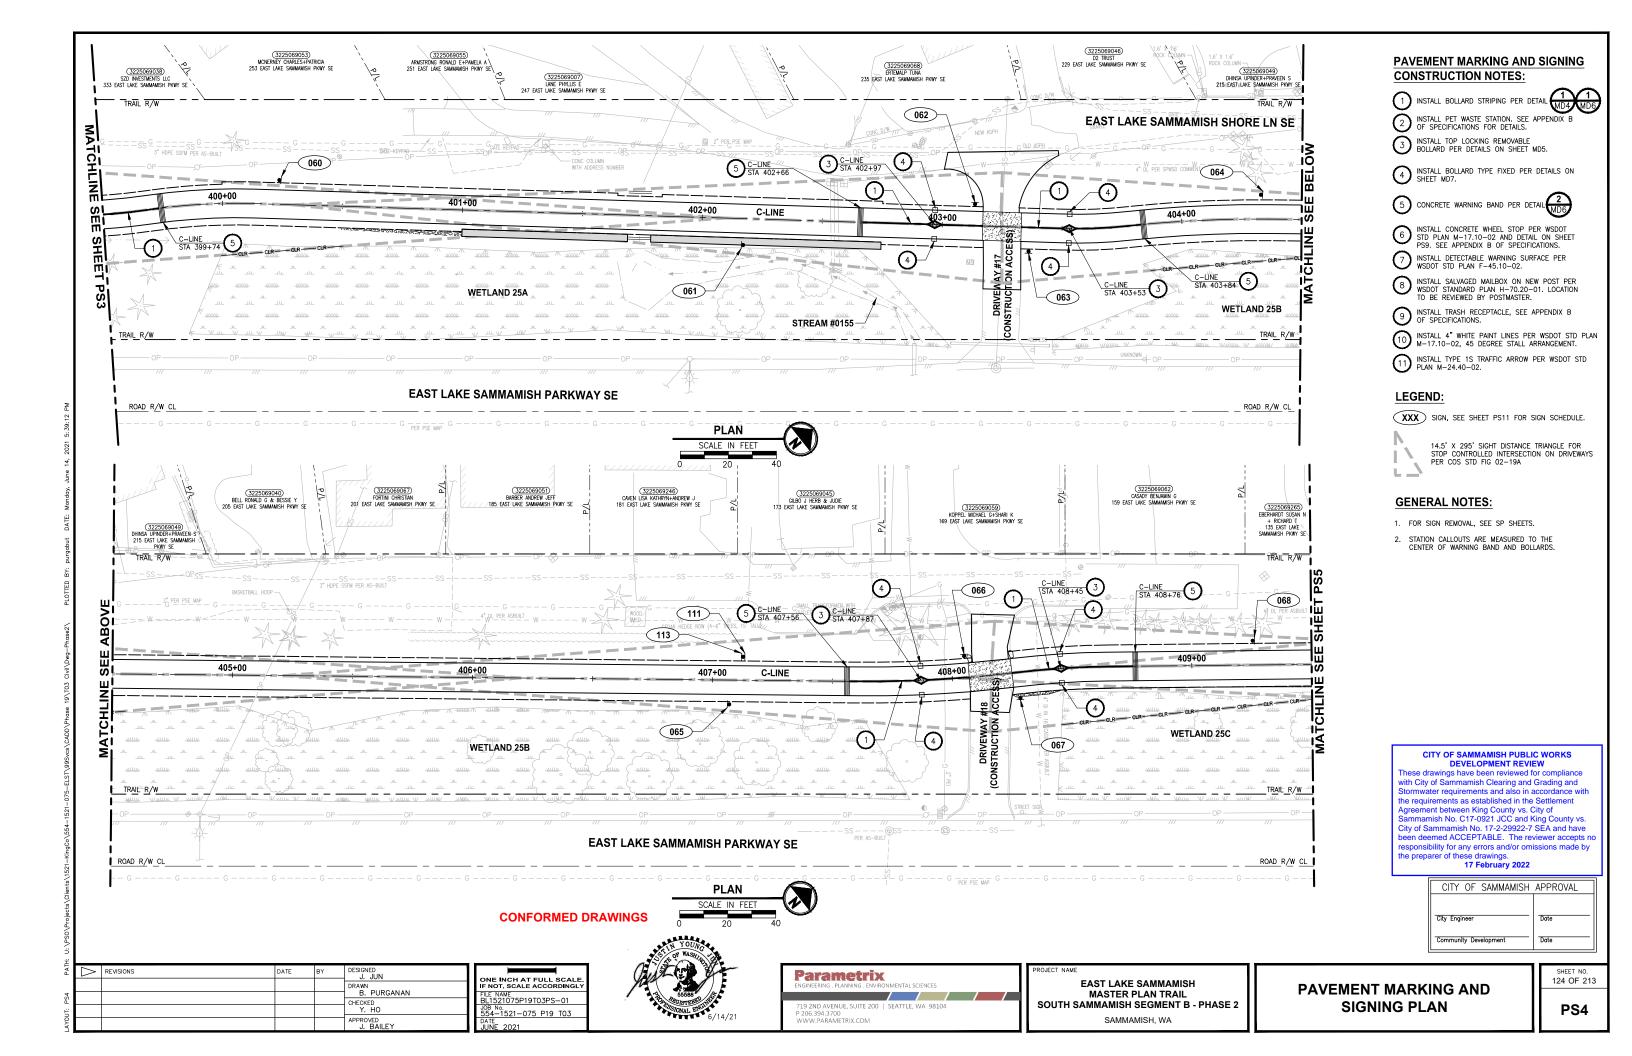
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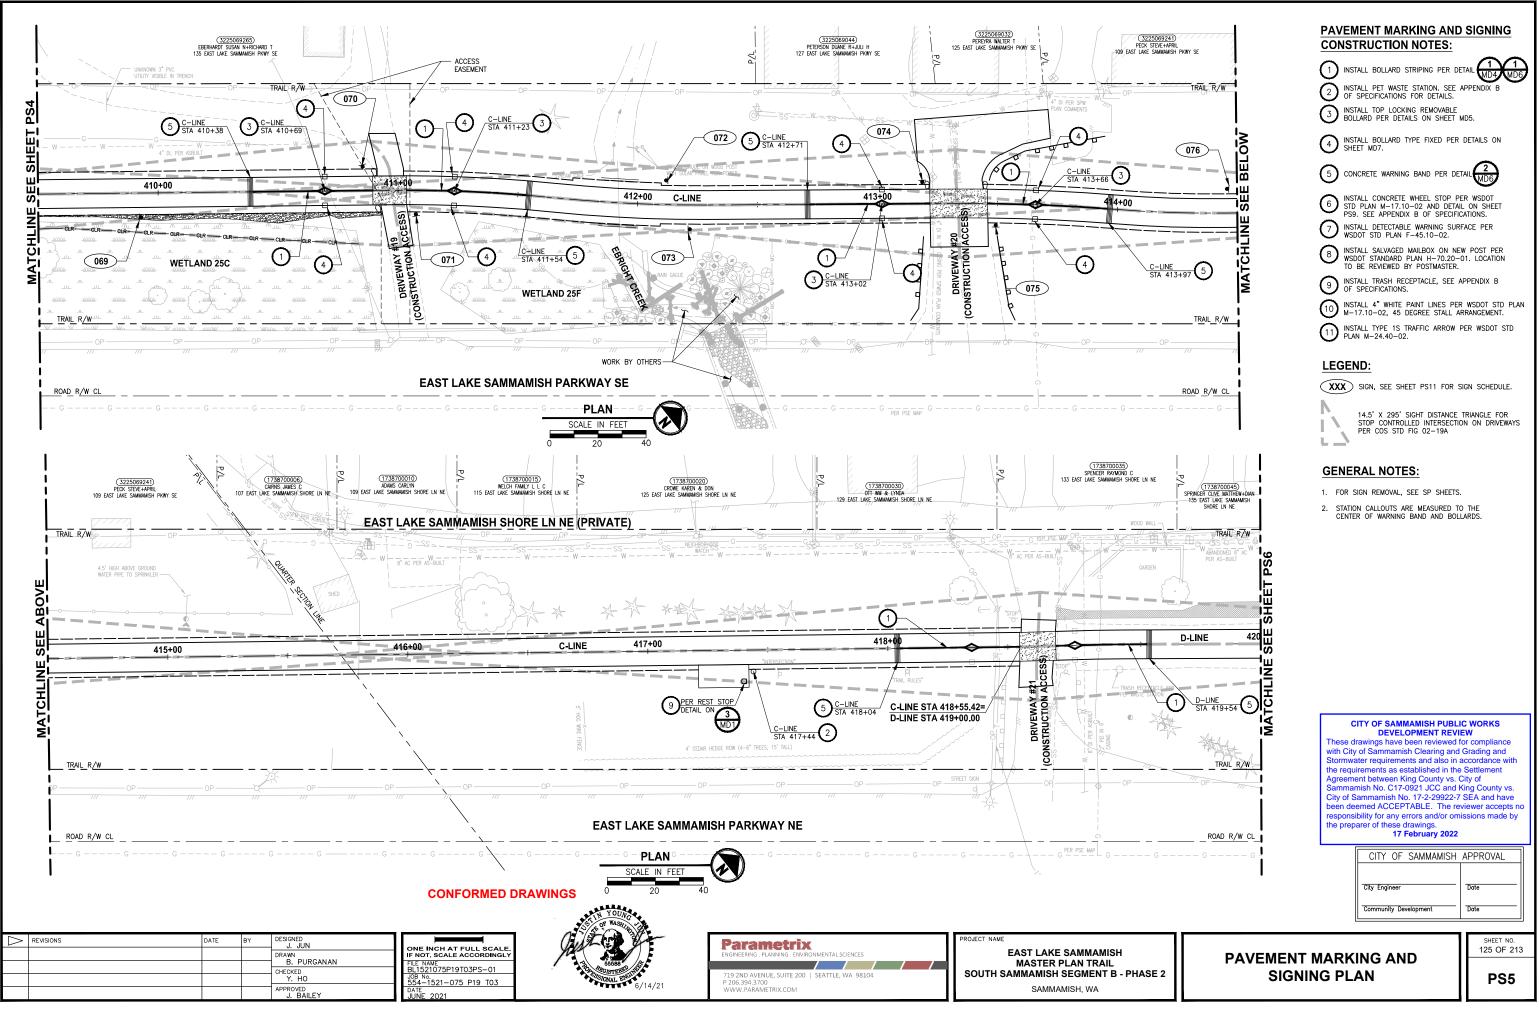
PAVEMENT MARKING AND
SIGNING PLAN


SHEET N 122 OF 213

PS2





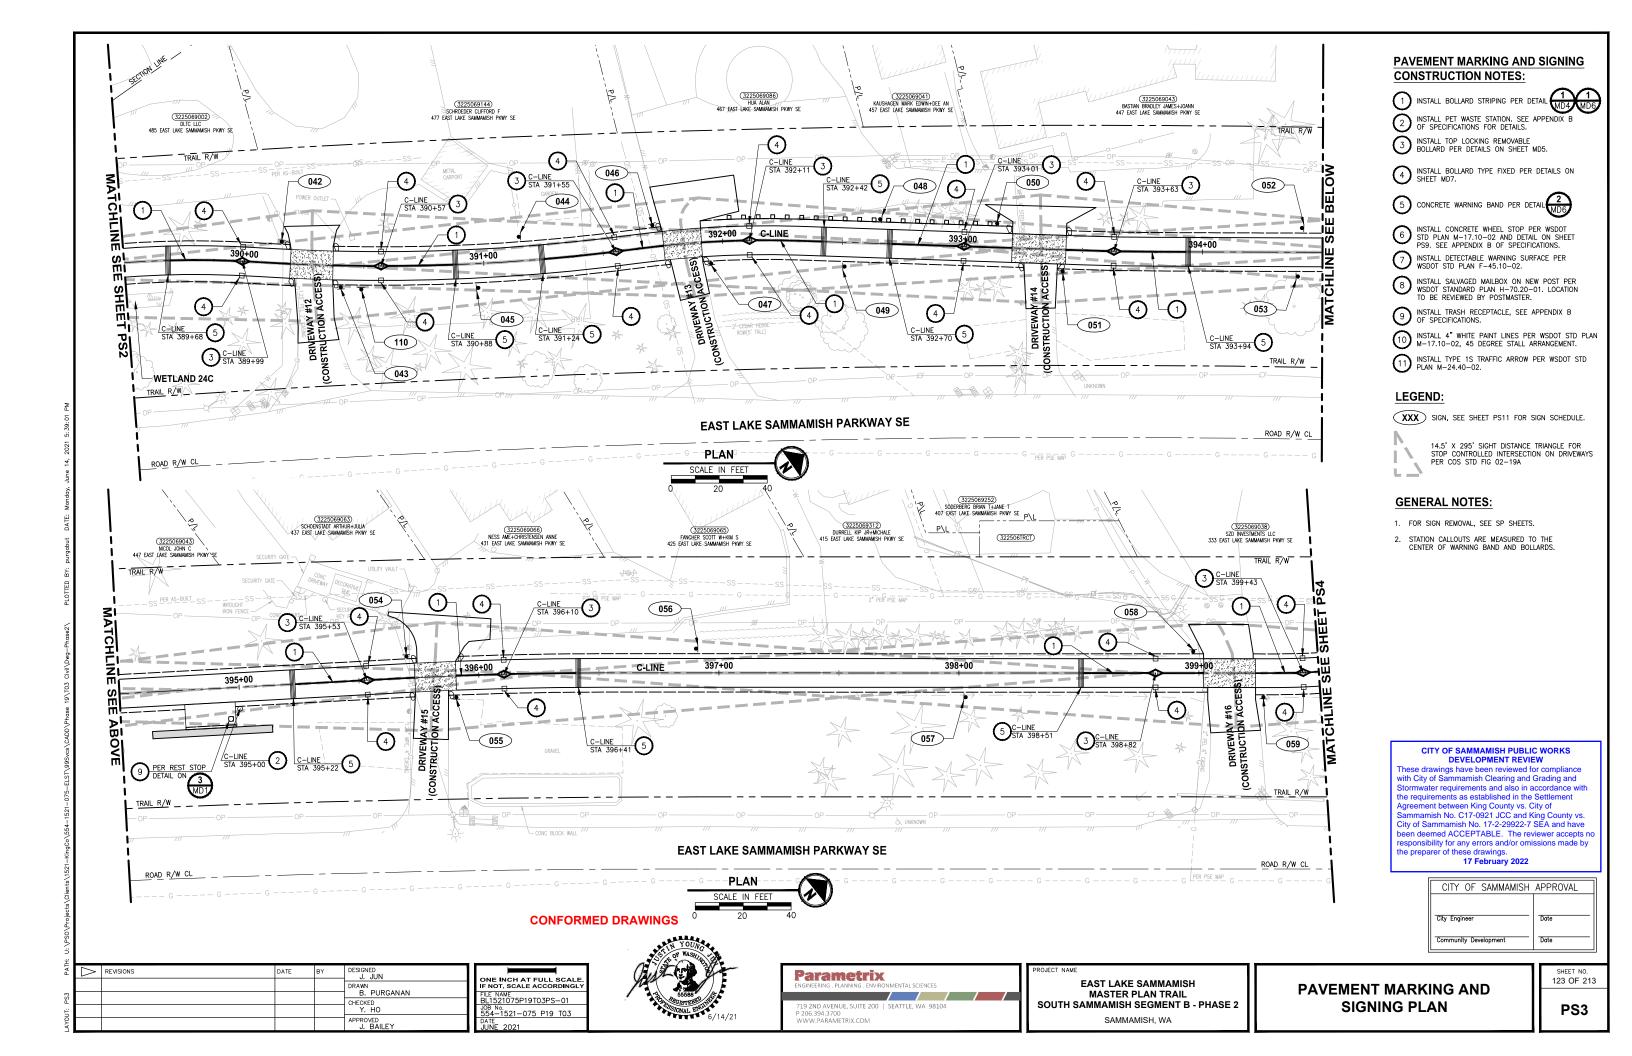

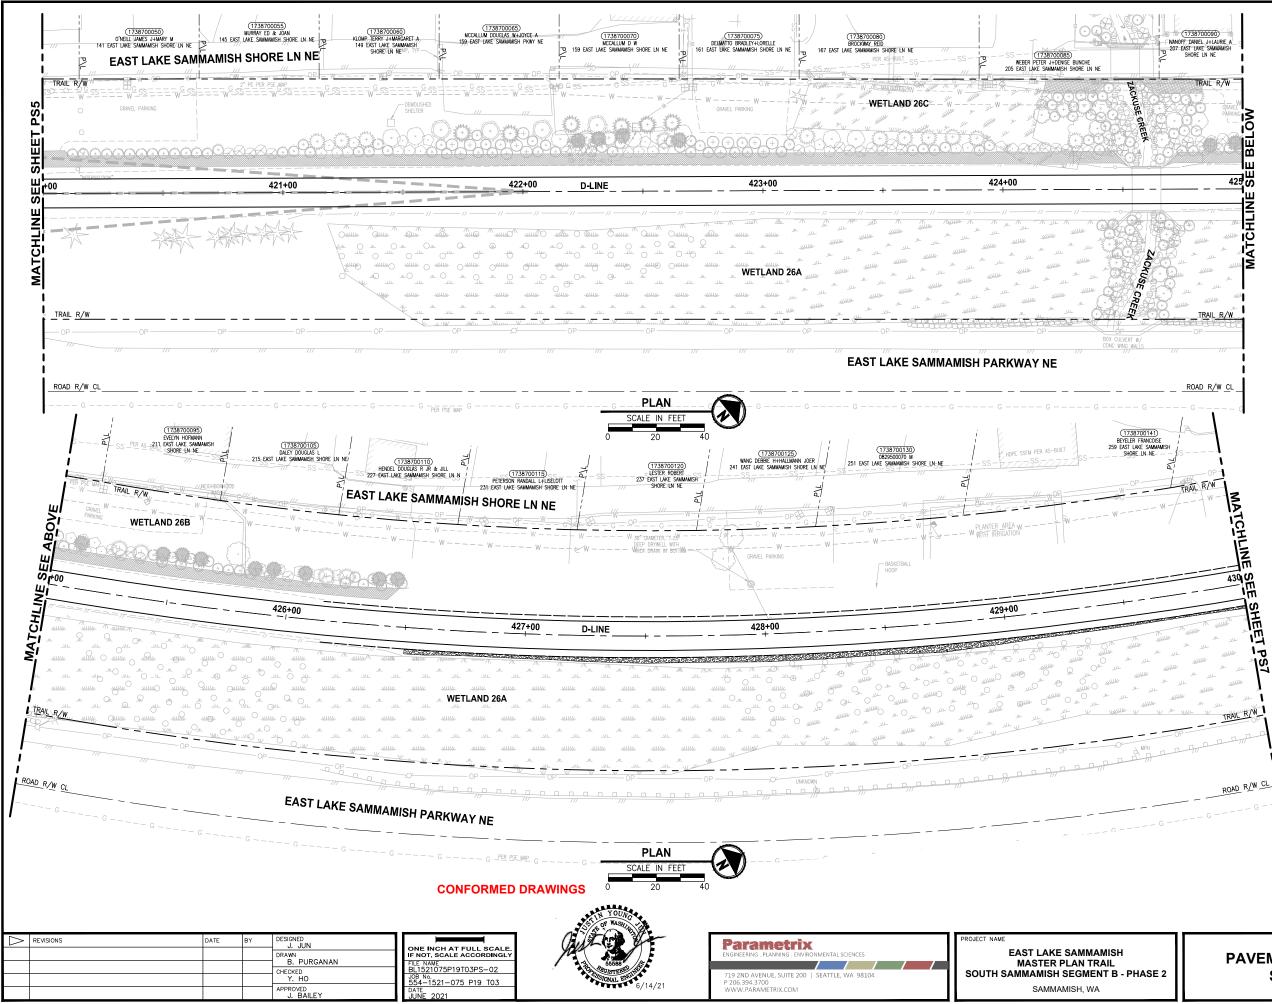

PAVEMENT MARKING AND SIGNING **CONSTRUCTION NOTES:**

- INSTALL BOLLARD STRIPING PER DETAIL
- 2 INSTALL PET WASTE STATION. SEE APPENDIX B
- (3) INSTALL TOP LOCKING REMOVABLE BOLLARD PER DETAILS ON SHEET MD5.
- (4) INSTALL BOLLARD TYPE FIXED PER DETAILS ON SHEET MD7.
- 5 CONCRETE WARNING BAND PER DETAIL
- 6 INSTALL CONCRETE WHEEL STOP PER WSDOT STD PLAN M-17.10-02 AND DETAIL ON SHEET PS9. SEE APPENDIX B OF SPECIFICATIONS.
- (7) INSTALL DETECTABLE WARNING SURFACE PER WSDOT STD PLAN F-45.10-02.
- (3) INSTALL SALVAGED MAILBOX ON NEW POST PER WSDOT STANDARD PLAN H-70.20-01. LOCATION TO BE REVIEWED BY POSTMASTER.
- (9) INSTALL TRASH RECEPTACLE, SEE APPENDIX B OF SPECIFICATIONS.
- 10 Install 4" white paint lines per wSDOT STD plan M-17.10-02,~45 degree stall arrangement.
- (1) INSTALL TYPE 1S TRAFFIC ARROW PER WSDOT STD PLAN M-24.40-02.

LEGEND:

XXX SIGN, SEE SHEET PS11 FOR SIGN SCHEDULE.



14.5' X 295' SIGHT DISTANCE TRIANGLE FOR STOP CONTROLLED INTERSECTION ON DRIVEWAYS PER COS STD FIG 02-19A

GENERAL NOTES:

- 1. FOR SIGN REMOVAL, SEE SP SHEETS.
- 2. STATION CALLOUTS ARE MEASURED TO THE CENTER OF WARNING BAND AND BOLLARDS.

CITY OF SAMMAMISH PUBLIC WORKS
DEVELOPMENT REVIEW

hese drawings have been reviewed for compliance with City of Sammamish Clearing and Grading and Stormwater requirements and also in accordance with ments as established in the Se the requ Agreement between King County vs. City of Sammamish No. C17-0921 JCC and King County vs. City of Sammamish No. 17-2-29922-7 SEA and have been deemed ACCEPTABLE. The reviewer accepts r responsibility for any errors and/or omissions made by the preparer of these drawings. 17 February 2022

CITY OF SAMMAMISH APPROVAL

Community Develop

City Engineer


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PAVEMENT MARKING AND SIGNING PLAN

SHEET NO. 126 OF 213

PS6



PAVEMENT MARKING AND SIGNING **CONSTRUCTION NOTES:**

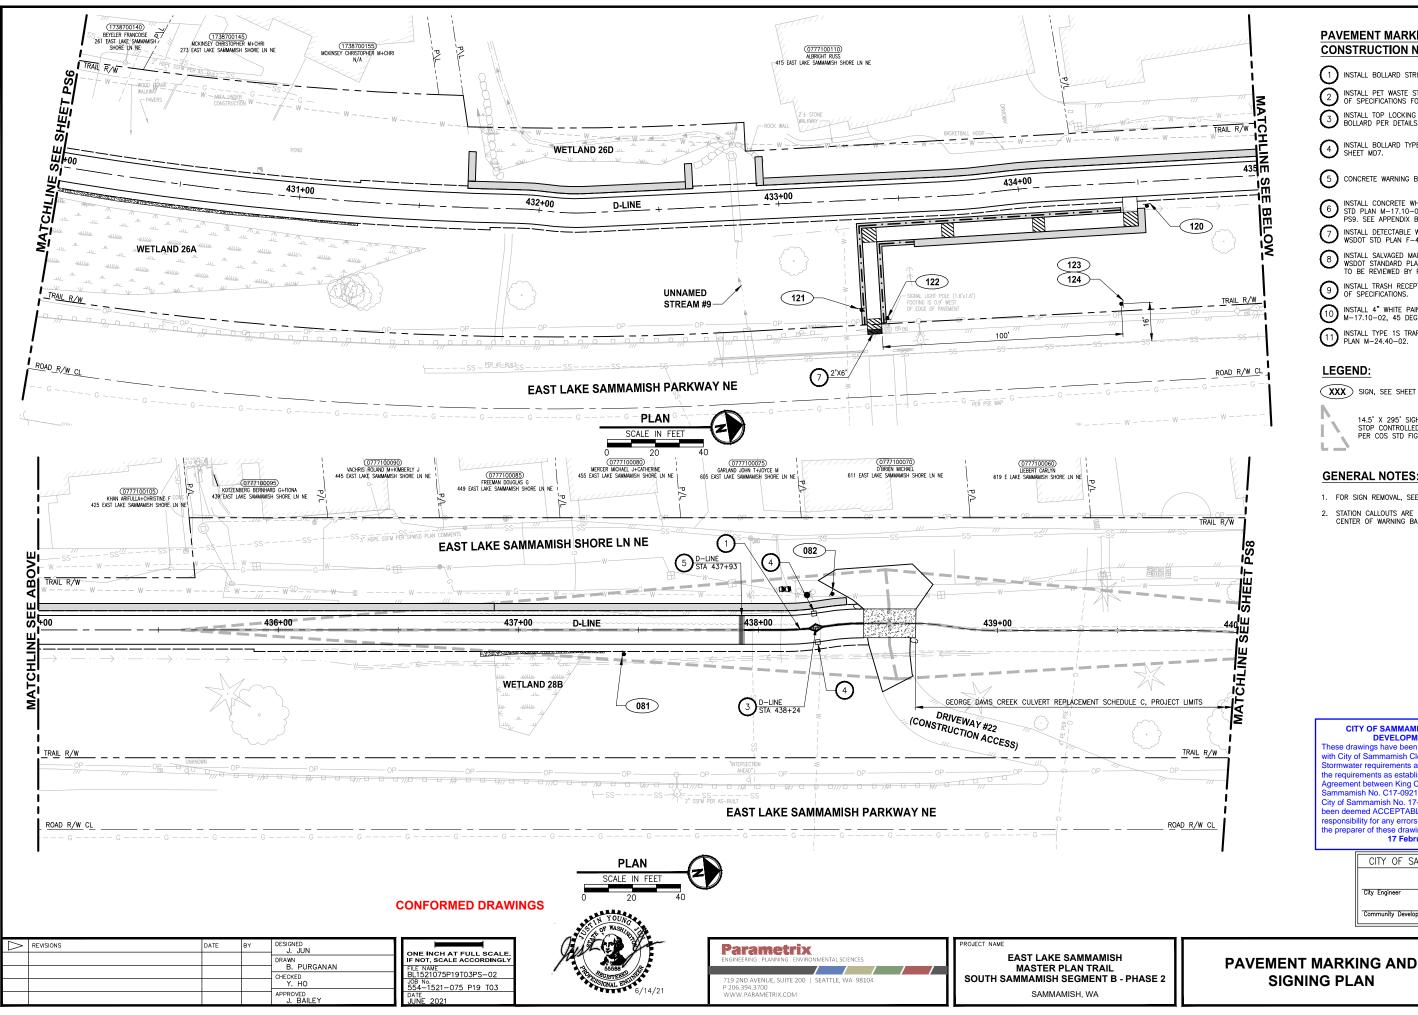- 1 INSTALL BOLLARD STRIPING PER DETAIL MD4 MD6
- 2 INSTALL PET WASTE STATION. SEE APPENDIX B OF SPECIFICATIONS FOR DETAILS.
- (3) INSTALL TOP LOCKING REMOVABLE BOLLARD PER DETAILS ON SHEET MD5.
- (4) INSTALL BOLLARD TYPE FIXED PER DETAILS ON SHEET MD7.
- 5 CONCRETE WARNING BAND PER DETAIL
- 6 INSTALL CONCRETE WHEEL STOP PER WSDOT STD PLAN M-17.10-02 AND DETAIL ON SHEET PS9. SEE APPENDIX B OF SPECIFICATIONS.
- (7) INSTALL DETECTABLE WARNING SURFACE PER WSDOT STD PLAN F-45.10-02.
- (8) INSTALL SALVAGED MAILBOX ON NEW POST PER WSDOT STANDARD PLAN H-70.20-01. LOCATION TO BE REVIEWED BY POSTMASTER.
- (9) INSTALL TRASH RECEPTACLE, SEE APPENDIX B OF SPECIFICATIONS.
- 10 Install 4" white paint lines per wSDOT STD plan M-17.10-02,~45 degree stall arrangement.
- (1) INSTALL TYPE 1S TRAFFIC ARROW PER WSDOT STD PLAN M-24.40-02.

LEGEND:

XXX SIGN, SEE SHEET PS11 FOR SIGN SCHEDULE.

14.5' X 295' SIGHT DISTANCE TRIANGLE FOR STOP CONTROLLED INTERSECTION ON DRIVEWAYS PER COS STD FIG 02-19A

GENERAL NOTES:

- 1. FOR SIGN REMOVAL, SEE SP SHEETS.
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CITY OF SAMMAMISH APPROVAL


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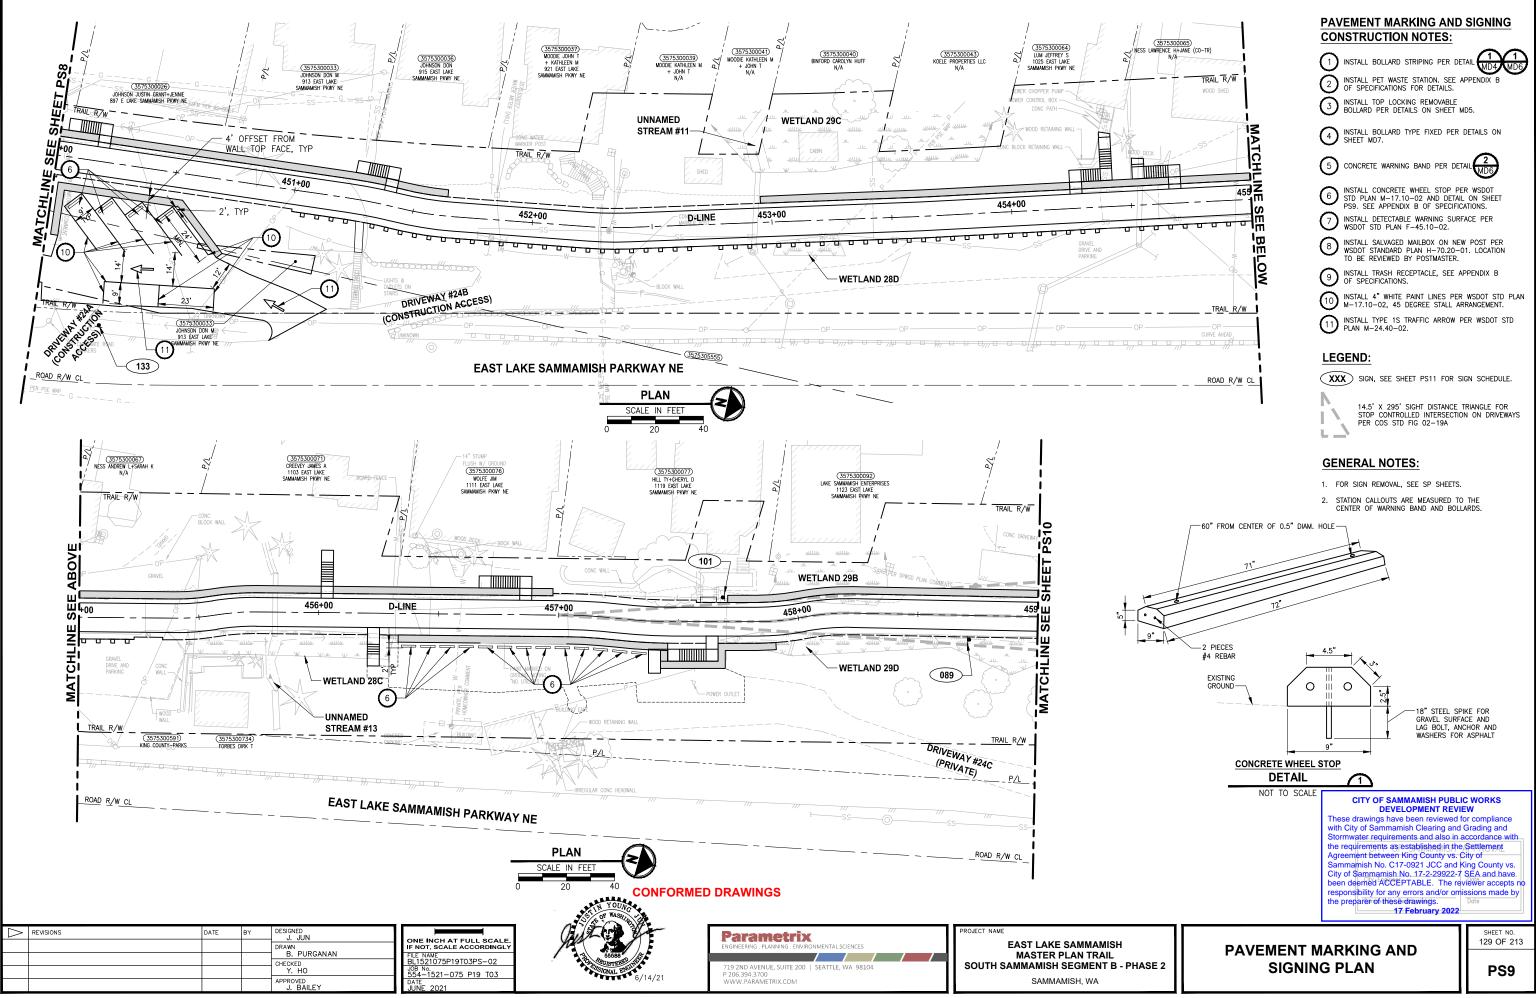
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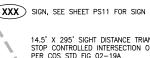
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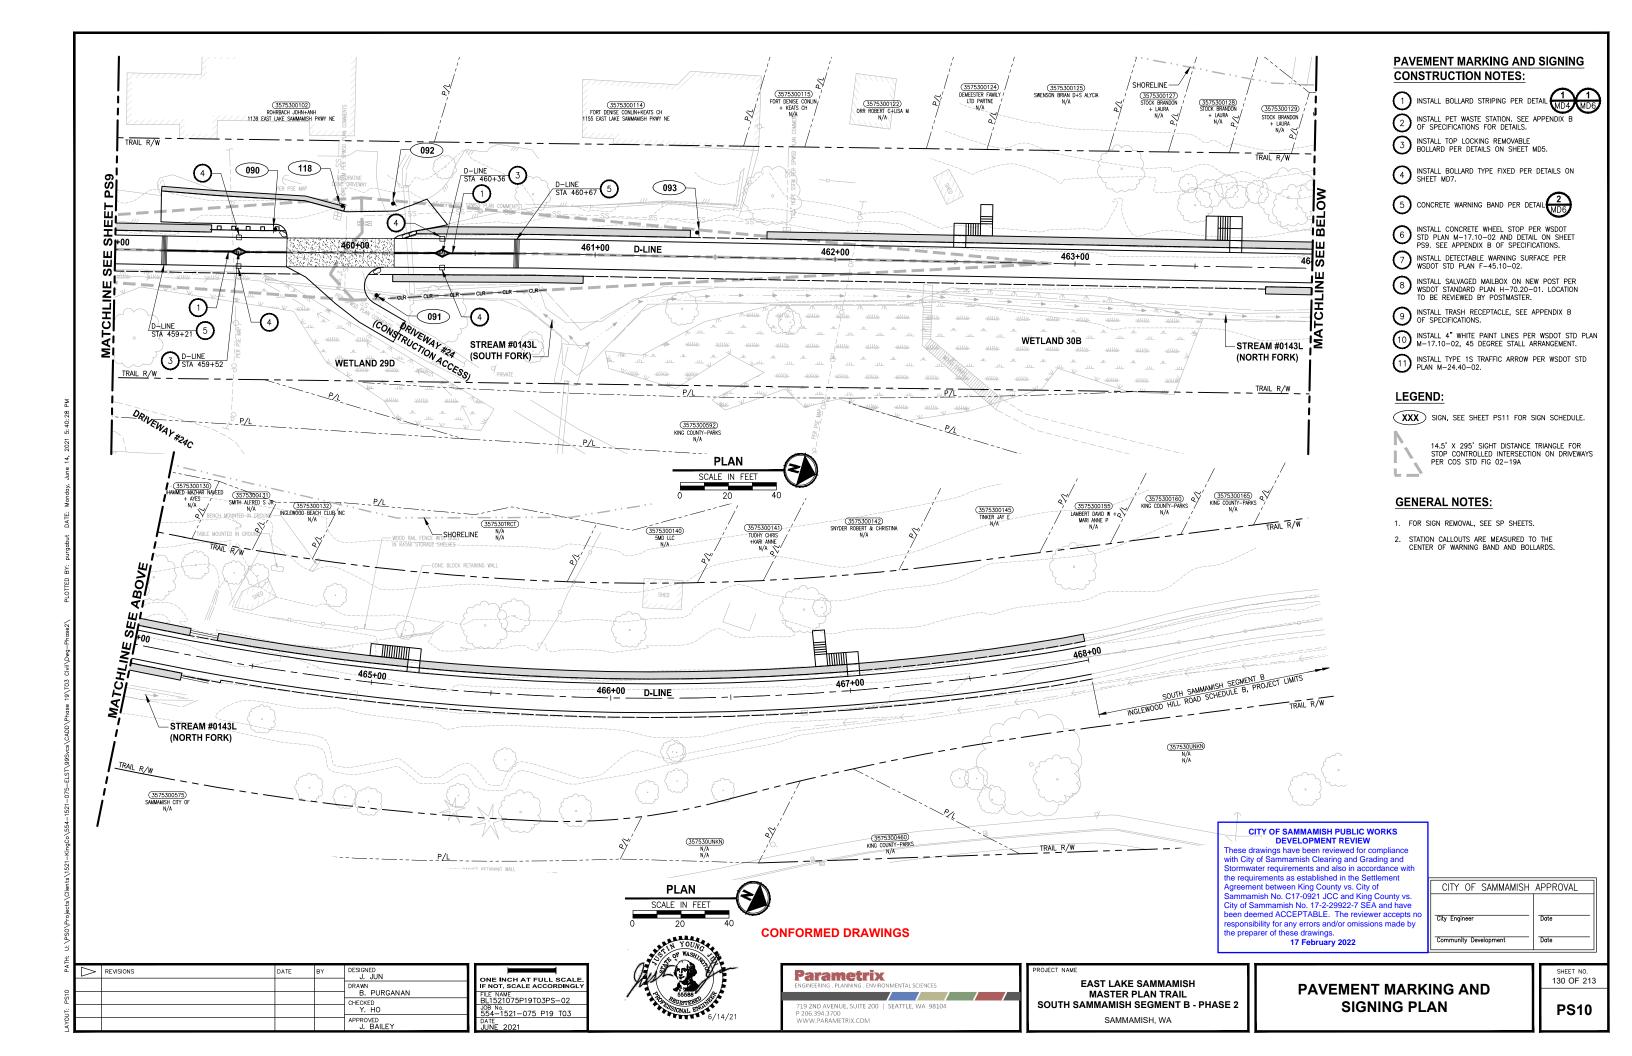
SHEET NO. 127 OF 213

PS7








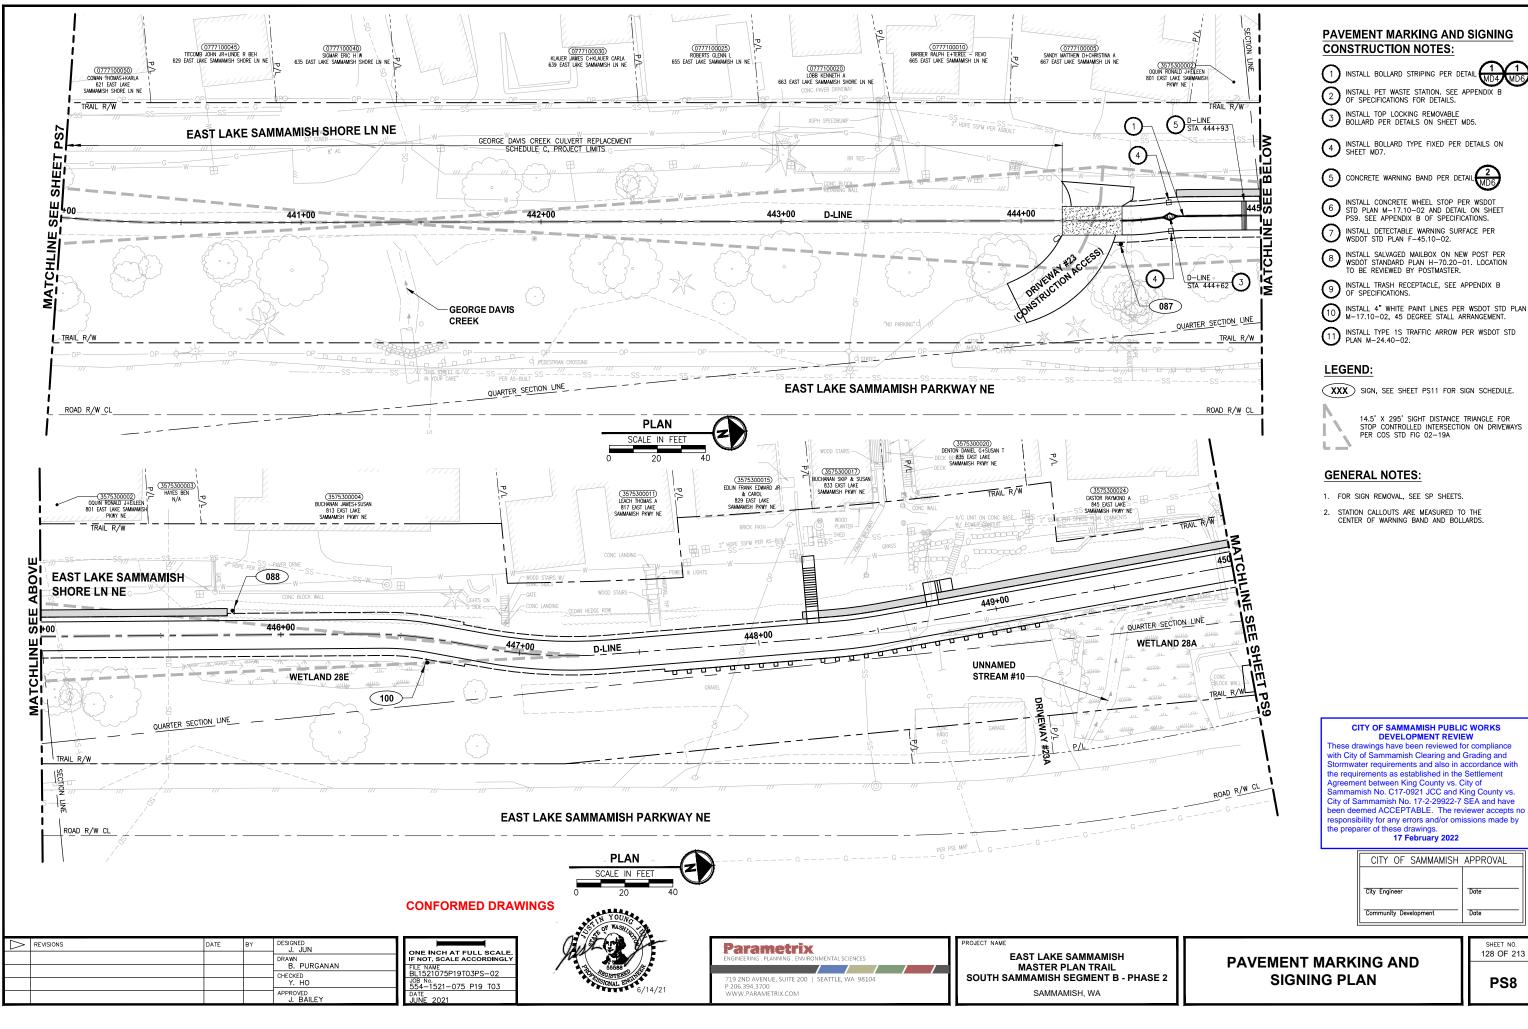

		LOCATION		DECODIDITION	MUTCD	SIGN SIZE	POST SIZE/TYPE	REMARK
SIGN NUMBER	LINE	STATION	OFFSET	DESCRIPTION	SIGN	SIGNSIZE	PUSISZE/ITPE	REMARK
033	C-LINE	377+73	10.1' RT	INTERSECTION WARNING SYMBOL	W2-1	18" X 18"	2" STEEL SQUARE*	NEW SIGN AND POST
034	C-LINE	378+68	9.0' LT	STOP	R1-1	30" X 30"	2" STEEL SQUARE*	NEW SIGN AND POST
035	C-LINE	378+95	13.0' RT	STOP	R1-1	30" X 30"	2" STEEL SQUARE*	NEW SIGN AND POST. ENSURE TO PREVENT UNDERMINING OF THE F WALL #19 AND PROTECT EXISTING WATER LINE IN THE AREA DURING CONSTRUCTION OF SIGN FOUNDATION.
036	C-LINE	379+92	10.1'LT	INTERSECTION WARNING SYMBOL	W2-1	18" X 18"	2" STEEL SQUARE*	NEW SIGN AND POST
037	C-LINE	383+72	10.1' RT	INTERSECTION WARNING SYMBOL	W2-1	18" X 18"	2" STEEL SQUARE*	NEW SIGN AND POST
038	C-LINE	385+07	12.0' LT	STOP	R1-1	30" X 30"	2" STEEL SQUARE*	NEW SIGN AND POST. ENSURE TO PREVENT UNDERMINING OF THE F WALL #20 DURING CONSTRUCTION OF SIGN FOUNDATION.
039	C-LINE	385+44	10.0' RT	STOP	R1-1	30" X 30"	2" STEEL SQUARE*	NEW SIGN AND POST
040	C-LINE	386+39	10.1' LT	INTERSECTION WARNING SYMBOL	W2-1	18" X 18"	2" STEEL SQUARE*	NEW SIGN AND POST
041	C-LINE	389+19	10.1' RT	INTERSECTION WARNING SYMBOL	W2-1	18" X 18"	2" STEEL SQUARE*	NEW SIGN AND POST
042	C-LINE	390+15	9.0' LT	STOP	R1-1	30" X 30"	2" STEEL SQUARE*	NEW SIGN AND POST
043	C-LINE	390+41	9.0' RT	STOP	R1-1	30" X 30"	2" STEEL SQUARE*	NEW SIGN AND POST
044	C-LINE	391+15	10.1' LT	INTERSECTION WARNING SYMBOL	W2-1	18" X 18"	2" STEEL SQUARE*	NEW SIGN AND POST
045	C-LINE	390+97	10.1' RT	INTERSECTION WARNING SYMBOL	W2-1	18" X 18"	2" STEEL SQUARE*	NEW SIGN AND POST
046	C-LINE	391+72	9.0' LT	STOP	R1-1	30" X 30"	2" STEEL SQUARE*	NEW SIGN AND POST
047	C-LINE	391+95	9.0' RT	STOP	R1-1	30" X 30"	2" STEEL SQUARE*	NEW SIGN AND POST
048	C-LINE	392+65	10.1' LT	INTERSECTION WARNING SYMBOL	W2-1	18" X 18"	2" STEEL SQUARE*	NEW SIGN AND POST
049	C-LINE	392+51	10.1' RT	INTERSECTION WARNING SYMBOL	W2-1	18" X 18"	2" STEEL SQUARE*	NEW SIGN AND POST
049	C-LINE	393+14	10.0' LT	STOP	R1-1	30" X 30"	2" STEEL SQUARE*	NEW SIGN AND POST
050	C-LINE C-LINE	393+14	9.0' RT	STOP	R1-1	30 × 30 30" X 30"	2" STEEL SQUARE*	NEW SIGN AND POST
					W2-1	30 X 30 18" X 18"		
052	C-LINE	394+41	10.1' LT	INTERSECTION WARNING SYMBOL			2" STEEL SQUARE*	NEW SIGN AND POST
053	C-LINE	394+40	10.1' RT	INTERSECTION WARNING SYMBOL	W2-1	18" X 18"	2" STEEL SQUARE*	NEW SIGN AND POST
054	C-LINE	395+70	9.0' LT	STOP	R1-1	30" X 30"	2" STEEL SQUARE*	NEW SIGN AND POST
055	C-LINE	395+90	9.0' RT	STOP	R1-1	30" X 30"	2" STEEL SQUARE*	NEW SIGN AND POST
056	C-LINE	396+90	10.1'LT	INTERSECTION WARNING SYMBOL	W2-1	18" X 18"	2" STEEL SQUARE*	NEW SIGN AND POST
057	C-LINE	398+03	10.1' RT	INTERSECTION WARNING SYMBOL	W2-1	18" X 18"	2" STEEL SQUARE*	NEW SIGN AND POST
058	C-LINE	398+98	9.0' LT	STOP	R1-1	30" X 30"	2" STEEL SQUARE*	NEW SIGN AND POST
059	C-LINE	399+27	10.0' RT	STOP	R1-1	30" X 30"	2" STEEL SQUARE*	NEW SIGN AND POST
060	C-LINE C-LINE	400+23	10.1' LT 11.0' RT	INTERSECTION WARNING SYMBOL	W2-1 W2-1	18" X 18" 18" X 18"	2" STEEL SQUARE*	NEW SIGN AND POST NEW SIGN AND NEW POST MOUNTED ON FACE OF WALL. SE SIGN WALL MOUNT DETAILS ON T ISHEET.
062	C-LINE	403+13	9.0' LT	STOP	R1-1	30" X 30"	2" STEEL SQUARE*	NEW SIGN AND POST
063	C-LINE	403+36	10.0' RT	STOP	R1-1	30" X 30"	2" STEEL SQUARE*	NEW SIGN AND POST
064	C-LINE	404+33	10.1'LT	INTERSECTION WARNING SYMBOL	W2-1	18" X 18"	2" STEEL SQUARE*	NEW SIGN AND POST
065	C-LINE C-LINE	407+07	10.1' RT	INTERSECTION WARNING SYMBOL	W2-1	18" X 18"	2" STEEL SQUARE*	NEW SIGN AND POST
066	C-LINE C-LINE	408+06	9.0' LT	STOP	R1-1	30" X 30"	2" STEEL SQUARE*	NEW SIGN AND POST
000			10.8' RT	STOP		30" X 30"	2" STEEL SQUARE*	
068	C-LINE C-LINE	408+27 409+25	10.8' RT 10.1' LT	INTERSECTION WARNING SYMBOL	R1-1 W2-1	30" X 30" 18" X 18"	2" STEEL SQUARE*	NEW SIGN AND POST
069	C-LINE	409+93	10.1' RT	INTERSECTION WARNING SYMBOL	W2-1	18" X 18"	2" STEEL SQUARE*	NEW SIGN AND POST
070	C-LINE	410+85	10.0' LT	STOP	R1-1	30" X 30" 30" X 30"	2" STEEL SQUARE*	NEW SIGN AND POST
071	C-LINE	411+07	10.0' RT		R1-1		2" STEEL SQUARE*	NEW SIGN AND POST
072	C-LINE	412+12	10.1'LT	INTERSECTION WARNING SYMBOL	W2-1	18" X 18"	2" STEEL SQUARE*	NEW SIGN AND POST
073	C-LINE	412+22	10.1' RT	INTERSECTION WARNING SYMBOL	W2-1	18" X 18"	2" STEEL SQUARE*	NEW SIGN AND POST
074	C-LINE	413+19	9.0' LT	STOP	R1-1	30" X 30"	2" STEEL SQUARE*	NEW SIGN AND POST
075	C-LINE	413+49	9.0' RT	STOP	R1-1	30" X 30"	2" STEEL SQUARE*	NEW SIGN AND POST
076	C-LINE	414+46	10.1'LT	INTERSECTION WARNING SYMBOL	W2-1	18" X 18"	2" STEEL SQUARE*	NEW SIGN AND POST
081	D-LINE D-LINE	437+44 438+33	10.1' RT 13.0' LT	INTERSECTION WARNING SYMBOL	W2-1 R1-1	18" X 18" 30" X 30"	2" STEEL SQUARE*	NEW SIGN AND POST NEW SIGN AND POST. ENSURE T PREVENT UNDERMING OF FILL W #30 DURING CONSTRUCTION OF S FOUNDATION.
087	D-LINE	444+42	9.75' RT	STOP	R1-1	30" X 30"	2" STEEL SQUARE*	NEW SIGN AND POST
088	D-LINE	445+80	10.1'LT	INTERSECTION WARNING SYMBOL	W2-1	18" X 18"	2" STEEL SQUARE*	NEW SIGN AND POST
089	D-LINE	458+72	10.1' RT	INTERSECTION WARNING SYMBOL	W2-1	18" X 18"	2" STEEL SQUARE*	NEW SIGN AND POST
009	D-LINE D-LINE	459+67	9.50' LT	STOP	R1-1	30" X 30"	2" STEEL SQUARE*	NEW SIGN AND POST
090	D-LINE D-LINE	459+67 460+09	9.50 LT 17.75' RT	STOP	R1-1	30 X 30 30" X 30"	2" STEEL SQUARE*	NEW SIGN AND POST
				STOP			2" STEEL SQUARE*	
092	D-LINE	460+16	20.5' LT		R1-1	30" X 30"		NEW SIGN AND POST
093 100	D-LINE D-LINE	461+42 446+63	10.1'LT 10.1'RT	INTERSECTION WARNING SYMBOL WATCH FOR PEDS	W2-1 W8-3 (MOD)	18" X 18" 18" X 18"	2" STEEL SQUARE* 2" STEEL SQUARE*	NEW SIGN AND POST NEW SIGN AND POST. SEE SIGN DETAIL W8-3 (MOD)
101	D-LINE	457+69	10.1' LT	WATCH FOR PEDS	W8-3 (MOD)	18" X 18"	2" STEEL SQUARE*	NEW SIGN AND POST. SEE SIGN DETAIL W8-3 (MOD)

	SIGN SCHEDULE							
SIGN NUMBER	LOCATION LINE STATION OFFSET		OFFSET	DESCRIPTION	MUTCD SIGN	SIGN SIZE	POST SIZE/TYPE	REMARK
108	C-LINE	386+13	9.75' LT	PET LAW	CUSTOM	N/A	2" STEEL SQUARE*	NEW SIGN AND POST. SIGN TO BE PROVIDED BY THE OWNER.
109	C-LINE	386+13	9.75' LT	PET LAW	CUSTOM	N/A	N/A	NEW SIGN. SIGN TO BE PROVIDED BY THE OWNER. SIGN ON BACK OF SIGN 108.
110	C-LINE	390+49	9.75' RT	ELST TRAIL RULES	CUSTOM	N/A	2" STEEL SQUARE*	NEW SIGN AND POST. SIGN TO BE PROVIDED BY THE OWNER.
111	C-LINE	407+13	9.75' LT	PET LAW	CUSTOM	N/A	2" STEEL SQUARE*	NEW SIGN AND POST. SIGN TO BE PROVIDED BY THE OWNER.
113	C-LINE	407+13	9.75' LT	PET LAW	CUSTOM	N/A	N/A	NEW SIGN AND POST. SIGN TO BE PROVIDED BY THE OWNER. SIGN ON BACK OF SIGN 111.
118	D-LINE	459+95	19.5' LT	STOP	R1-1	30"×30"	N/A	NEW SIGN ON CHAIN LINK FENCE
120	D-LINE	434+53	10.1' RT	BICYCLE MUST DISMOUNT	R5-6 (MOD)	18" X 18"	2" STEEL SQUARE*	NEW SIGN AND POST. SEE SIGN DETAIL W8-3 (MOD-2)
121	D-LINE	433+32	45.8' RT	LOOK BOTH WAYS BEFORE EXITING	W8-3 (MOD-3)	18" X 18"	2" STEEL SQUARE*	NEW SIGN AND POST MOUNTED ON FACE OF WALL. SEE SIGN WALL MOUNT DETAILS ON THIS SHEET. SEE SIGN DETAIL W8-3 (MOD-3)
122	D-LINE	433+43	49.6' RT	BICYCLE MUST DISMOUNT	R5-6 (MOD)	18" X 18"	2" STEEL SQUARE*	NEW SIGN AND POST MOUNTED ON FACE OF WALL. SEE SIGN WALL MOUNT DETAILS ON THIS SHEET. SEE SIGN DETAIL W8-3 (MOD-2)
123	D-LINE	434+40	50.3' RT	BICYCLE / PEDESTRIAN	W11-15	18"X18"	2" STEEL SQUARE*	NEW SIGN AND POST
124	D-LINE	434+40	50.3' RT	AHEAD (PLAQUE)	W16-9P	24"X12"	N/A	NEW SIGN ON SAME POST AS SIGN 122, BELOW SIGN 122
133	D-LINE	450+27	67.6' RT	DO NOT ENTER	R5-1	30"x30"	2" STEEL SQUARE*	NEW SIGN AND POST

* SEE DETAILS 3-7 ON SHEET MD8 FOR SIGN SUPPORT DETAILS.

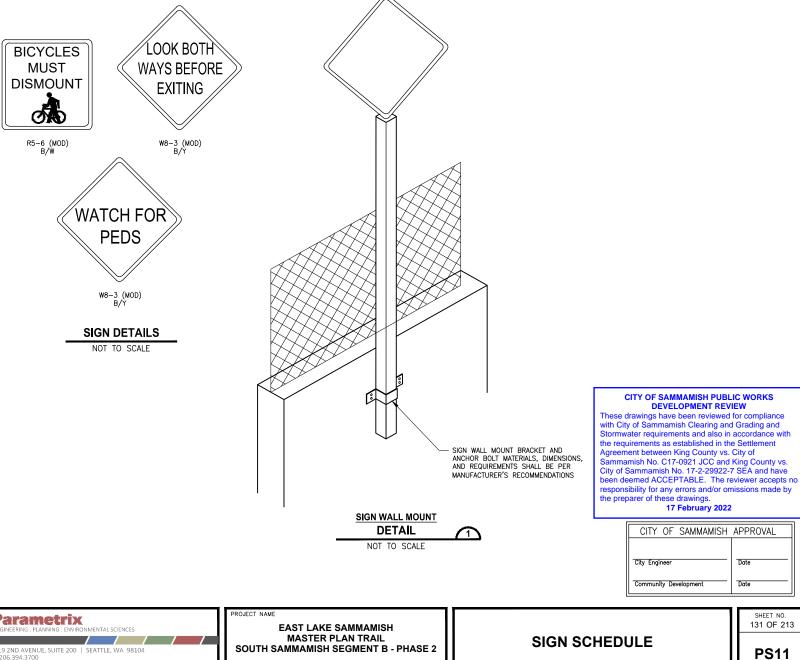


CONFORMED DRAWINGS





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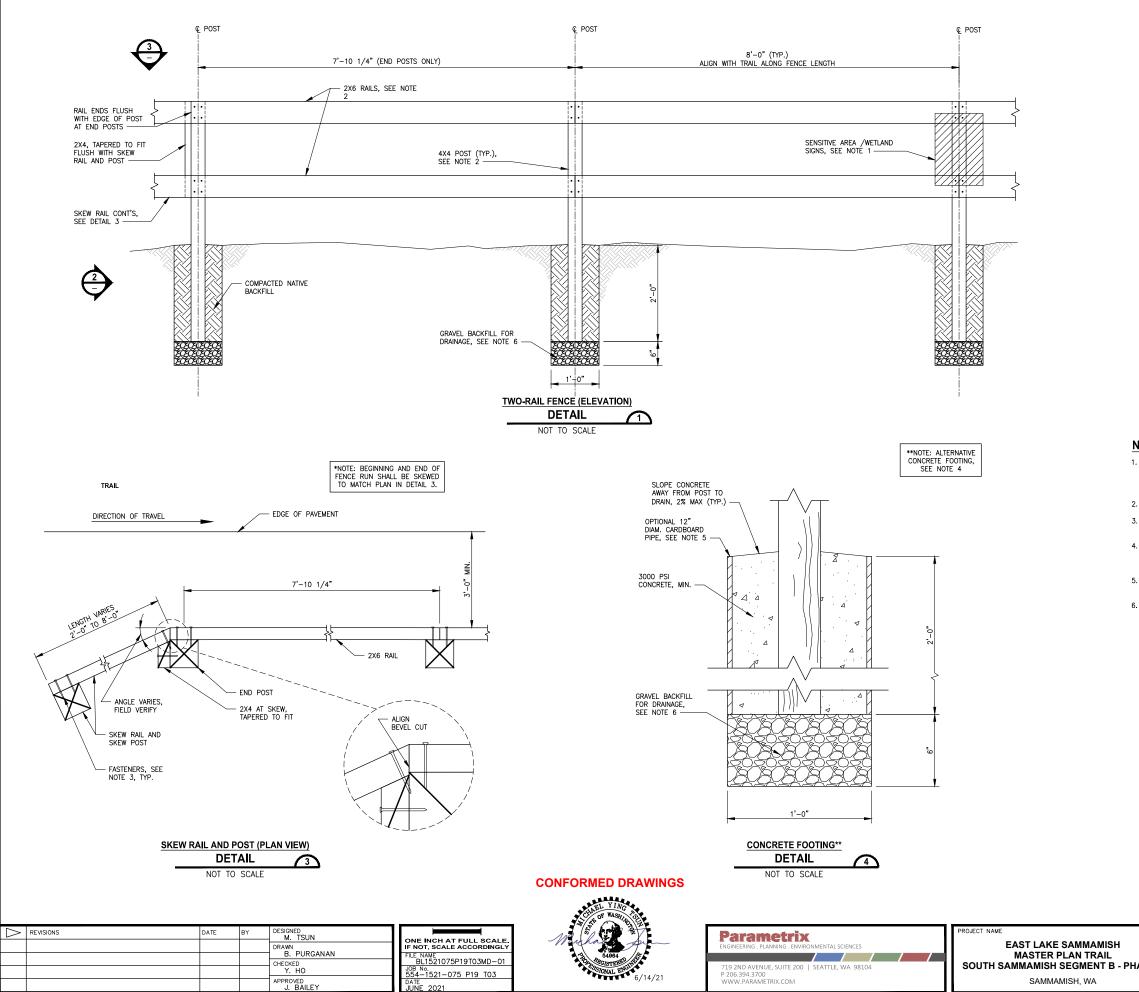
SAMMAMISH, WA

•	REVISIONS	DATE	BY	DESIGNED J. JUN	ONE INCH AT FULL SCALE.
				DRAWN	IF NOT, SCALE ACCORDINGLY
				B. PURGANAN CHECKED	FILE NAME BL1521075P19T03PS-02
				Y. HO	JOB No. 554-1521-075 P19 T03
				APPROVED J. BAILEY	DATE JUNE 2021




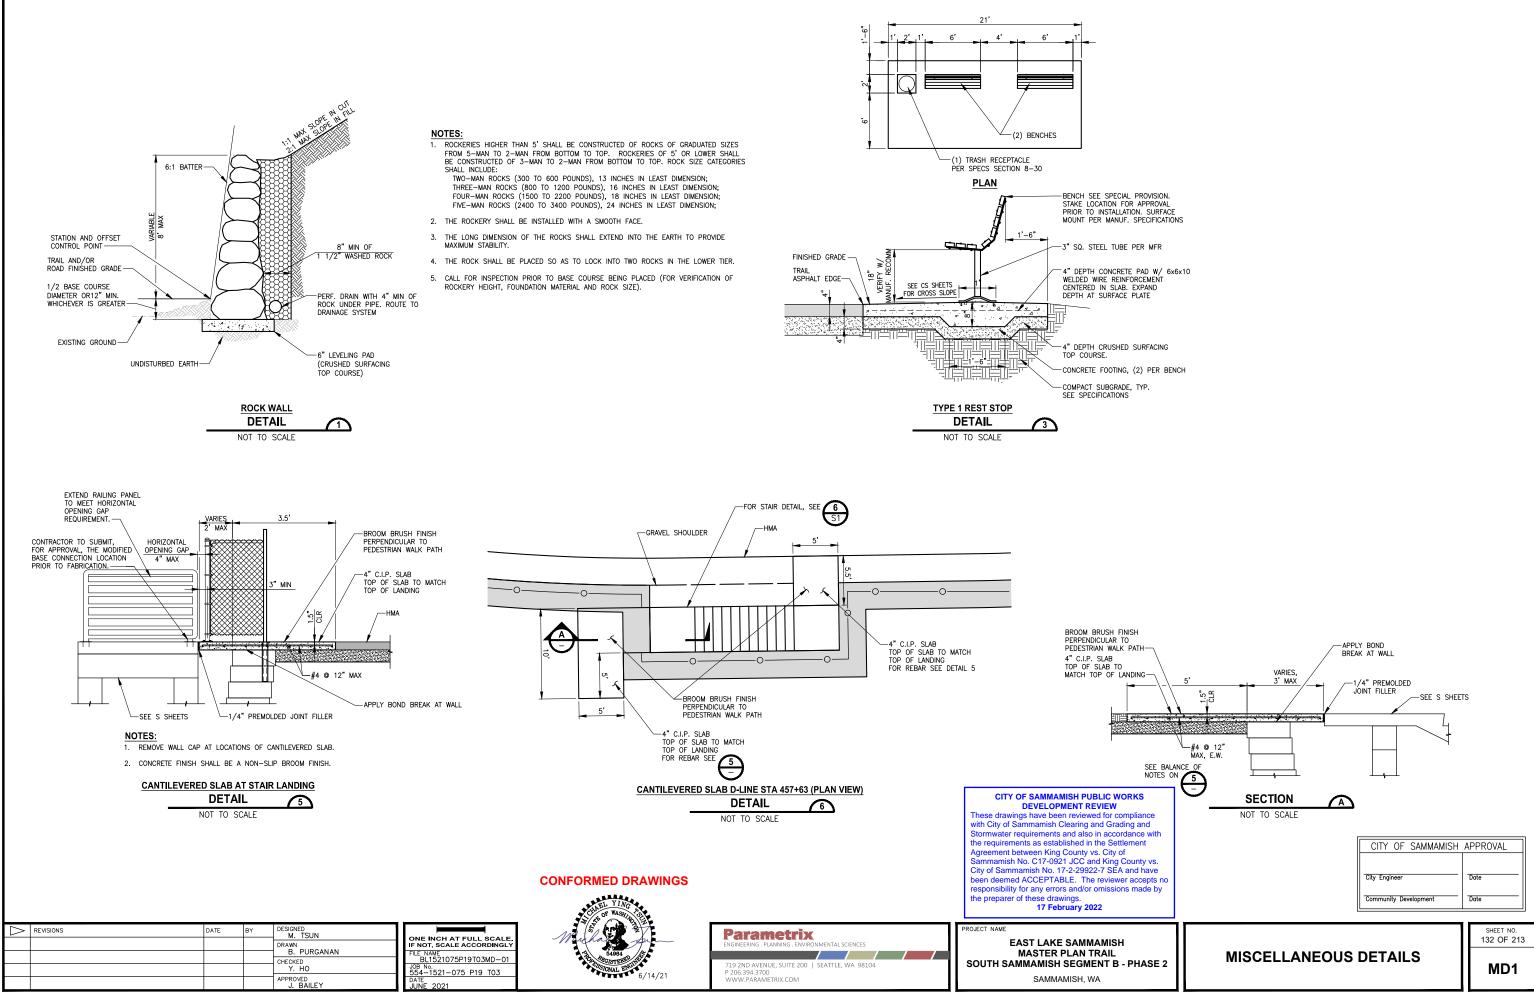

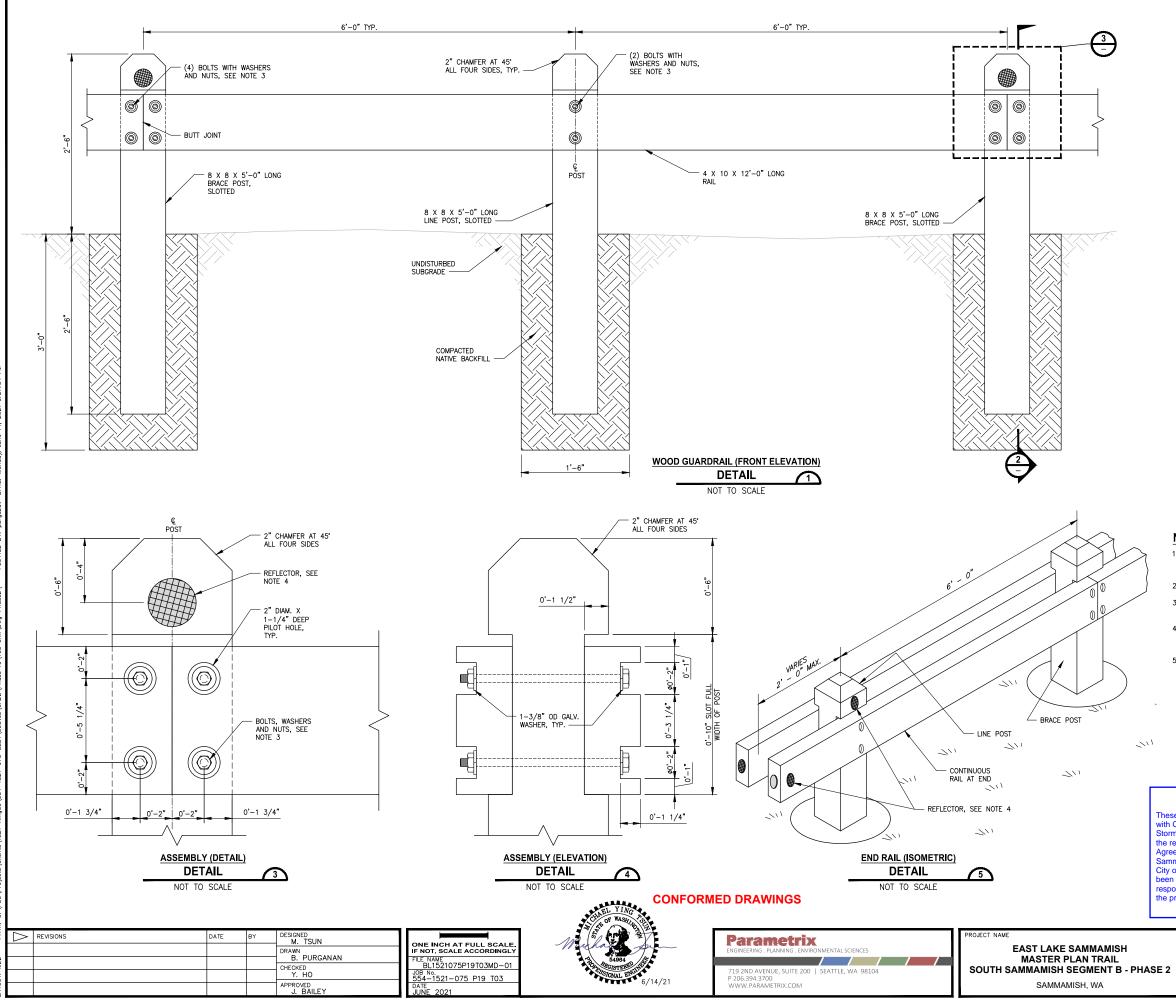

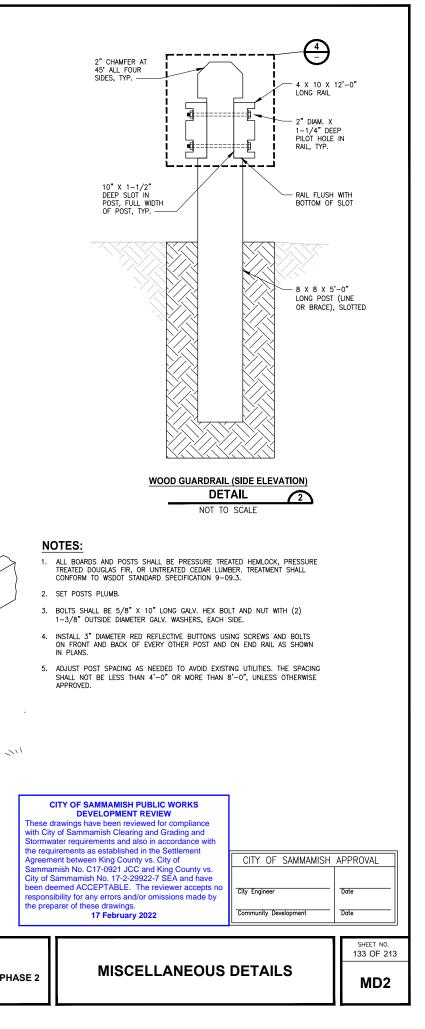



SAMMAMISH, WA

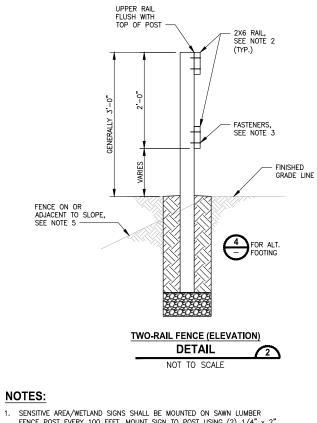



- FENCE POST EVERY 100 FEET. MOUNT SIGN TO POST USING (2) $1/4" \times 2"$ LONG GALVANIZED STEEL LAG SCREWS WITH GALVANIZED STEEL WASHERS. MINIMUM (2) SIGNS PER FENCE RUN.
- 2. ALL BOARDS AND POSTS SHALL BE UNTREATED CEDAR LUMBER.
- ALL WOOD FASTENERS SHALL BE 3 1/2" LONG, #9 STAR DRIVE FLAT HEAD STAR DRIVE POLYMER COATED DECK SCREWS.
- 4. FENCE POST SHALL BE INSTALLED EITHER IN NATIVE BACKFILL (DETAIL 1, 2) OR IN CONCRETE FOOTING (DETAIL 4) DEPENDING ON NEED PER KC PARKS OF CONCRETE FOOTING (DETAIL 4) DEPENDING ON NEED PER KC PARKS ENGINEER'S DIRECTION.
- 5. FENCE INSTALLED ON OR ADJACENT TO A SLOPE SHALL UTILIZE 12" DIAM. CARDBOARD PIPE PER KC PARKS ENGINEER'S DIRECTION.
- 6. GRAVEL BACKFILL FOR DRAINAGE TO BE USED WHERE ALLOWABLE PER KC PARKS ENGINEERS DECISION. GRAVEL BACKFILL FOR DRAINS SHALL CONFORM TO WSDOT STANDARD SPEC 9-03.12(4).

ASE 2 MISCELLANEOUS	DETAILS	sheet NO. 134 OF 213 МD3
CITY OF SAMMAMISH PUBLIC WORKS DEVELOPMENT REVIEW These drawings have been reviewed for compliance with City of Sammamish Clearing and Grading and Stormwater requirements and also in accordance with the requirements as established in the Settlement Agreement between King County vs. City of Sammamish No. 17-0921 JCC and King County vs. City of Sammamish No. 17-2-29922-7 SEA and have been deemed ACCEPTABLE. The reviewer accepts no responsibility for any errors and/or omissions made by the preparer of these drawings. 17 February 2022	CITY OF SAMMAMISH City Engineer Community Development	APPROVAL Date Date

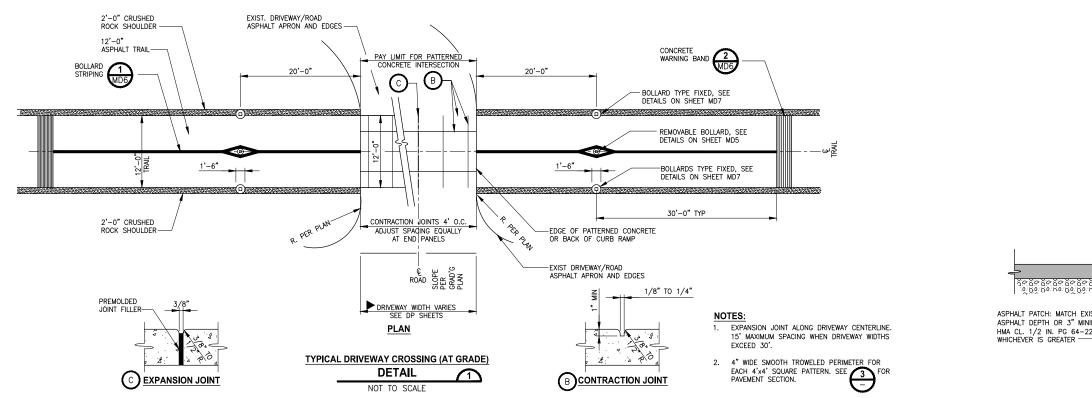

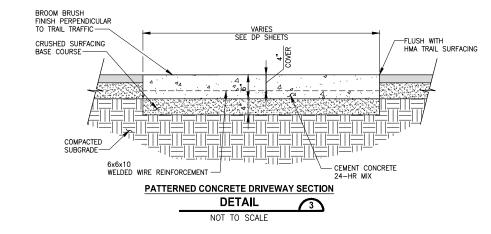

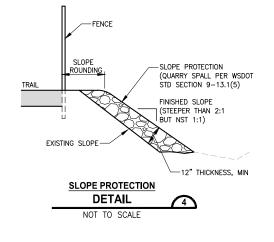


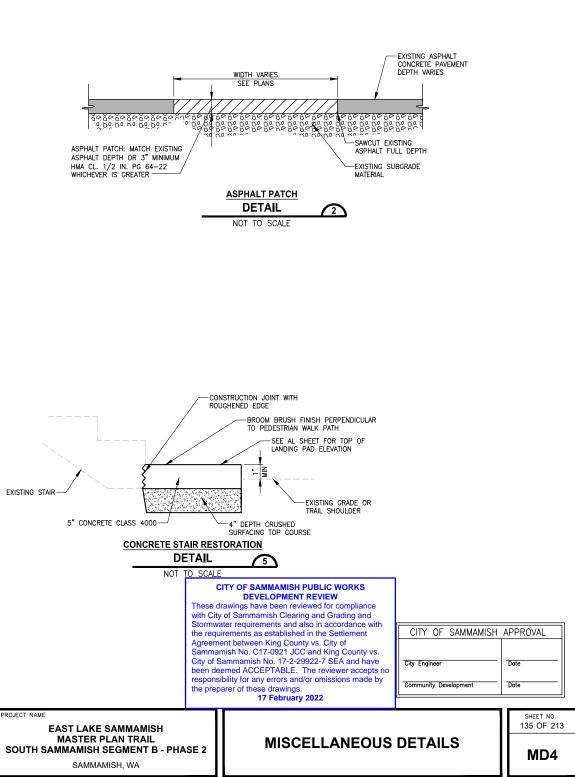


CONFORMED DRAWINGS

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					DRAWN	ONE INCH AT FULL SCALE IF NOT, SCALE ACCORDINGLY
					B. PURGANAN CHECKED	FILE NAME BL1521075P19T03MD-01
					Y. HO	JOB No. 554-1521-075 P19 T03
					J. BAILEY	DATE JUNE 2021




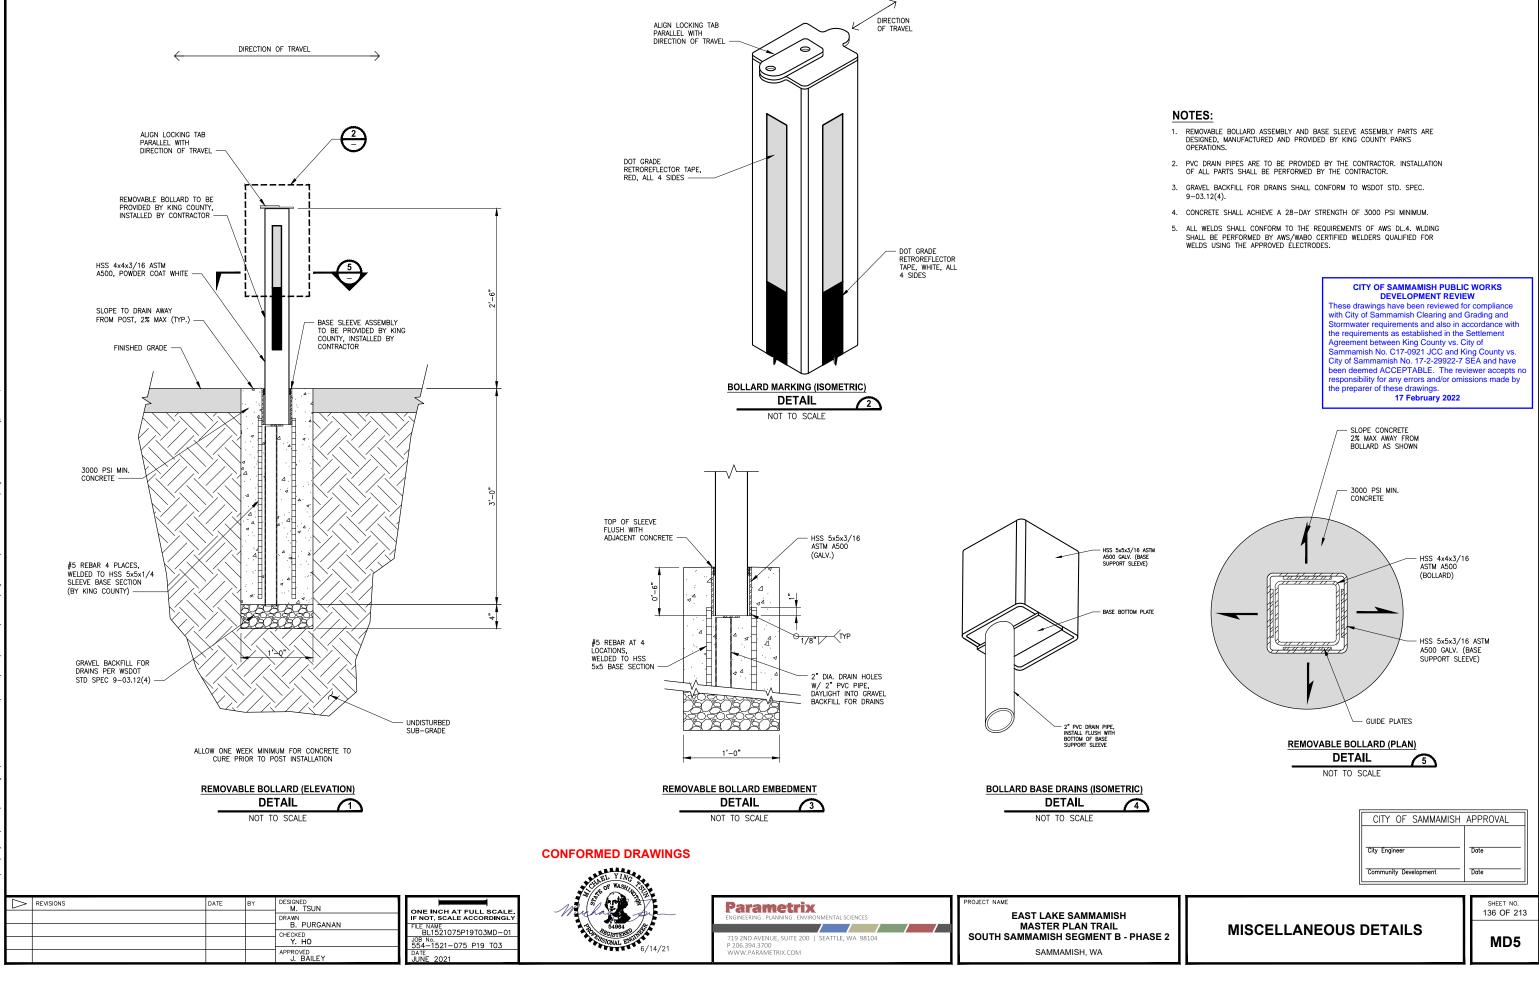

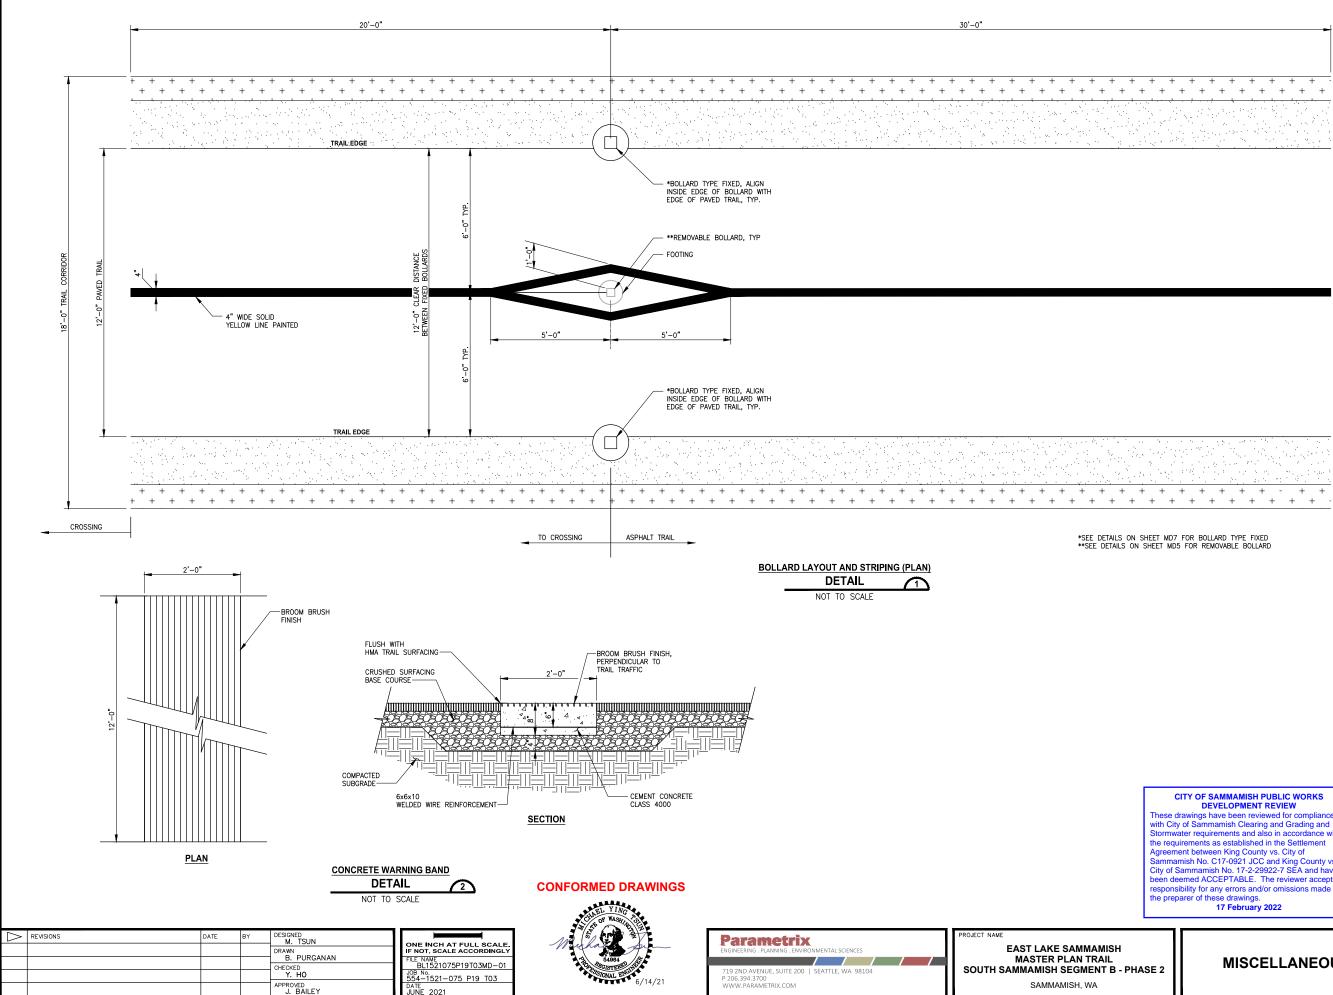
ASE 2	MISCELLANEOUS	DETAILS	MD6
			SHEET NO. 137 OF 213
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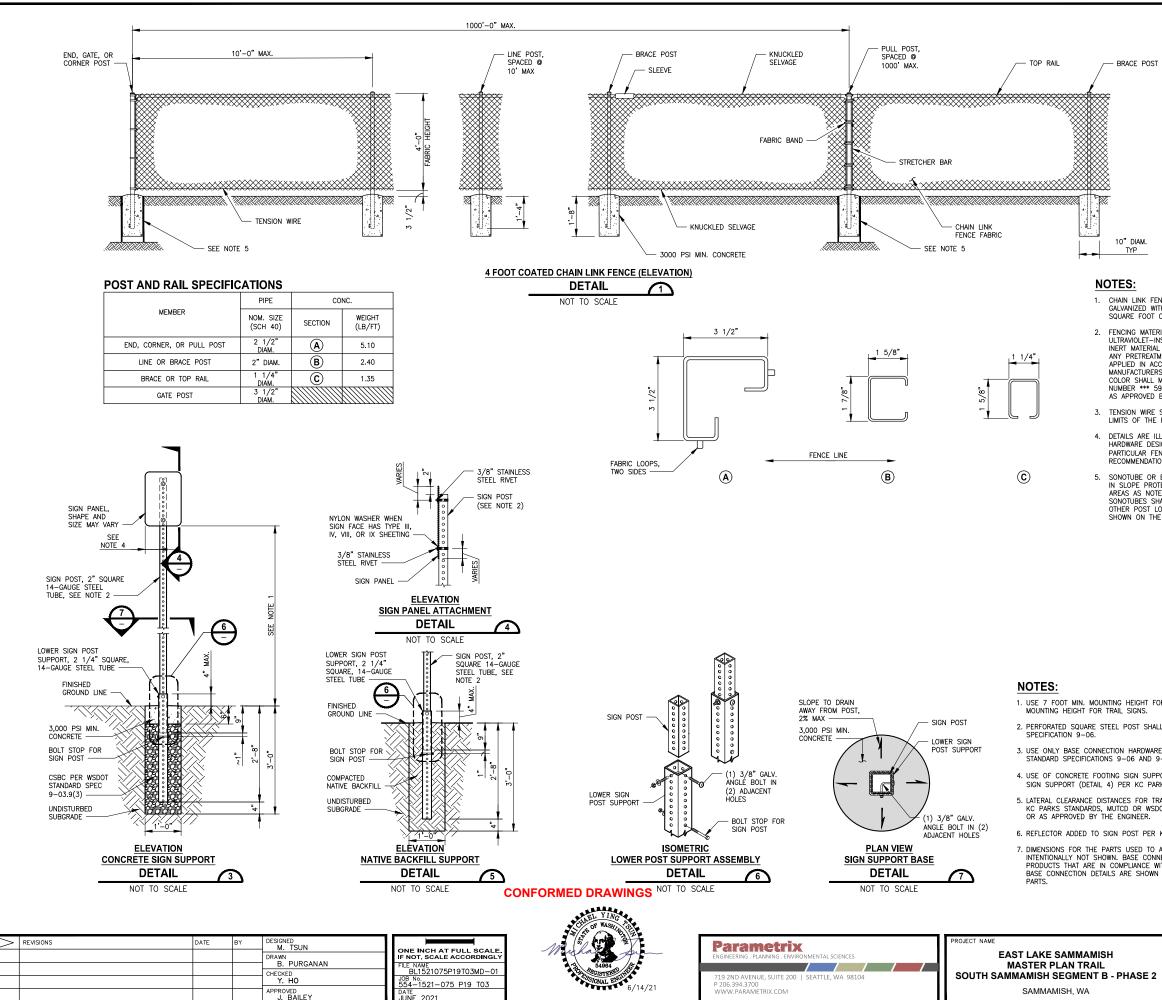
NOTES:

- 1. BOLLARD ASSEMBLY SHALL BE POWDER COATED WHITE AFTER WELDING.
- 2. APPLY RETROREFLECTIVE TAPE PER PLAN AFTER POWDER COATING.
- 3. CONCRETE SHALL ACHIEVE A 28-DAY STRENGTH OF 3,000 PSI MINIMUM.
- ALL WELDS SHALL CONFORM TO THE REQUIREMENTS OF AWS DL.4. WLDING SHALL BE PERFORMED BY AWS/WABO CERTIFIED WELDERS QUALIFIED FOR WELDS USING THE APPROVED ELECTRODES.

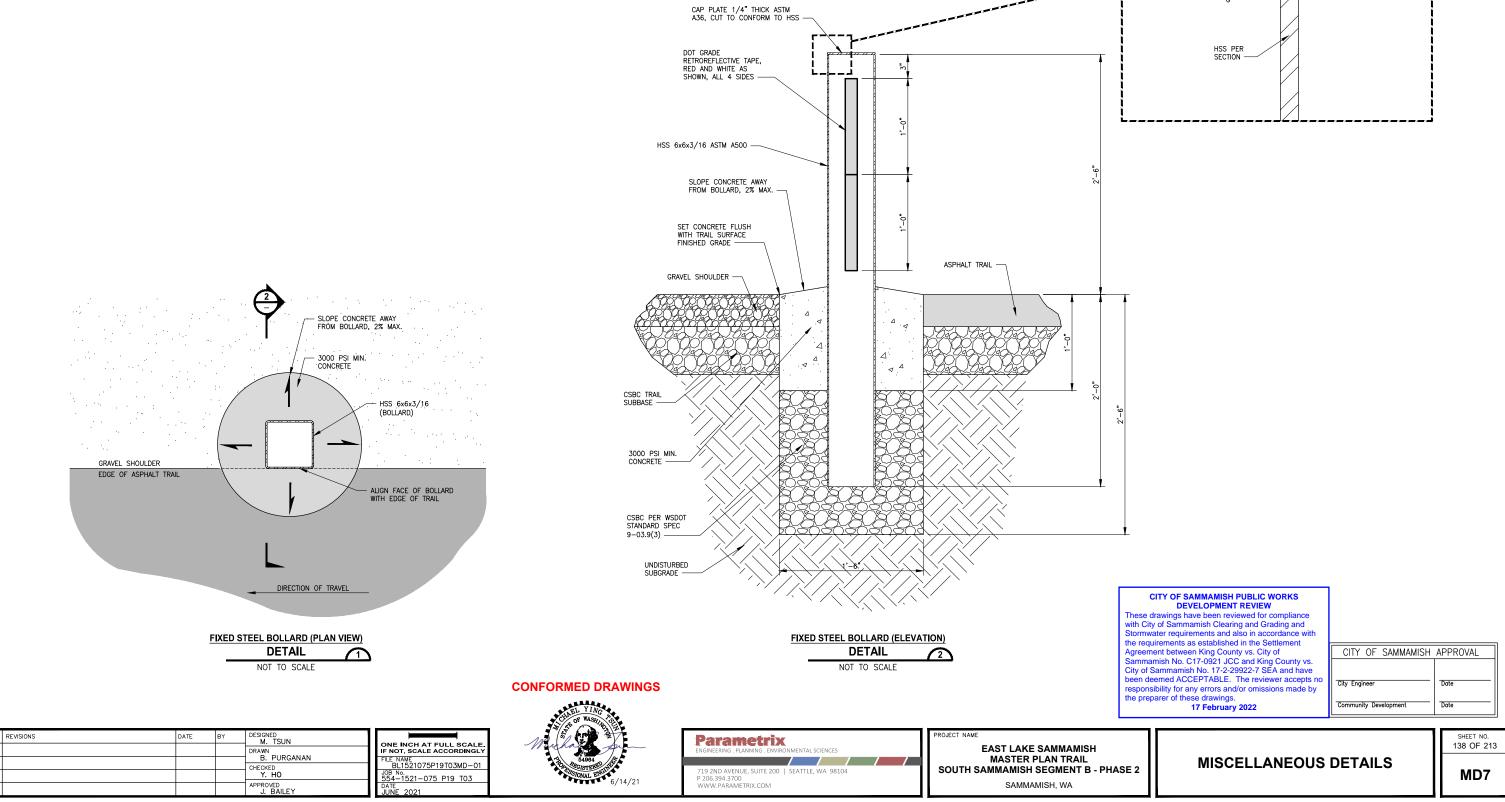


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BRACE POST

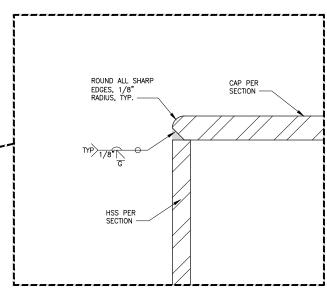

NOT TO SCALE

CHAIN LINK FENCE FABRIC SHALL BE HOT-DIP GALVANIZED WITH A MINIMUM OF 0.8 OUNCE PER SQUARE FOOT OF SURFACE AREA.

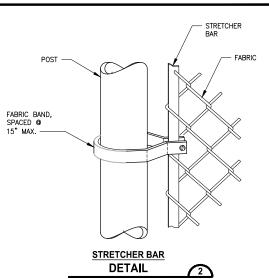2. FENCING MATERIAL SHALL BE COATED WITH AN ULTRAVIOLET-INSENSITIVE PLASTIC OR OTHER INERT MATERIAL AT LEAST 2 MILS IN THICKNESS. ANY PRETREATMENT OR COATING SHALL BE ANT PREIREAIMENT OR COATING SHALL BE APPLIED IN ACCORDANCE WITH THE MANUFACTURERS WRITTEN INSTRUCTIONS. THE COLOR SHALL MATCH FEDERAL STANDARD NUMBER *** 595 B 27038 BLACK ***, OR BE AS APPROVED BY THE ENGINEER.

3. TENSION WIRE SHALL BE PLACED WITHIN THE LIMITS OF THE FIRST FULL FABRIC WEAVE.

4. DETAILS ARE ILLUSTRATIVE AND SHALL NOT LIMIT HARDWARE DESIGN OR POST SELECTION OF ANY PARTICULAR FENCE TYPE, PER MANUFACTURER'S RECOMMENDATIONS.

5. SONOTUBE OR EQUIVALENT SHALL ONLY BE USED IN SLOPE PROTECTION OR STEEPER SLOPED AREAS AS NOTED ON THE CS SHEETS. SONOTUBES SHALL BE INSTALLED AT EVERY OTHER POST LOCATION PER PLAN LENGTH SHOWN ON THE AL SHEETS.

1. USE 7 FOOT MIN. MOUNTING HEIGHT FOR TRAFFIC SIGNS. USE 5 FOOT MIN. MOUNTING HEIGHT FOR TRAIL SIGNS.

2. PERFORATED SQUARE STEEL POST SHALL MEET REQUIREMENTS OF STANDARD SPECIFICATION 9-06.


USE ONLY BASE CONNECTION HARDWARE THAT MEET THE REQUIREMENTS OF STANDARD SPECIFICATIONS 9-06 AND 9-28.

4. USE OF CONCRETE FOOTING SIGN SUPPORT (DETAIL 1) OR NATIVE BACKFILL SIGN SUPPORT (DETAIL 4) PER KC PARKS ENGINEER'S DECISION.

LATERAL CLEARANCE DISTANCES FOR TRAIL AND TRAFFIC SIGNS SHALL BE PER KC PARKS STANDARDS, MUTCD OR WSDOT REQUIREMENTS, LOCAL JURISDICTION, OR AS APPROVED BY THE ENGINEER.

6. REFLECTOR ADDED TO SIGN POST PER KC PARKS ENGINEER'S DETERMINATION.

7 DIMENSIONS FOR THE PARTS LISED TO ASSEMBLE THE BASE CONNECTIONS ARE DIMENSIONS FOR THE PARTS USED TO ASSEMBLE THE BASE CONNECTIONS ARE INTENTIONALLY NOT SHOWN. BASE CONNECTIONS ARE PATENTED, MANUFACTURED PRODUCTS THAT ARE IN COMPLIANCE WITH NCHRP 350 CRASH TEST CRITERIA. BASE CONNECTION DETAILS ARE SHOWN ONLY TO ILLUSTRATE ASSEMBLY OF

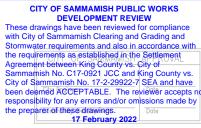

SHEET 139 OF 213

MISCELLANEOUS DETAILS

MD8


ROAD WORK $\overline{\Delta}$ AHEAD W20-1 48"x48" ROAD ONE LANE ROAD WORK ZONE WORK ZONE WORK Σ ${}^{\Box}$ LEGEND: PHASE 1 AHEAD AHEAD PHASE 2 MIN 20' W20-4 48"×48" w_{20-1} o o CHANNELIZING DEVICES 48"x48" ONE LANE ROAD AHEAD No. R WORK ZONE Ô Σ $\overline{\Delta}$ Ø ٢ L VARIES MIN 20' SEE NOTE W1-4L Ø ٨ 30"x30" Ø ٥ W20-4 48"x48" ٨ Ø Ø Ø 0 Ø WÓRK 10' ŴÓRK 10' TRAIL TRAIL TRAIL TRAIL MIN MIN AREA AREA 0 0 6 ٢ ٨ L VARIES MIN 20' EE NOTE ٨ Ø ٨ Ø ٨ Ø ONE LANE ROAD AHEAD ∇ ∇ . Ô X VARIES MIN 20' SEE NOTE W1-4L 30"x30" W20-4 48"x48 ROAD ONE LANE ROAD AHEAD ☑. WORK AHEAD NOTES: 1. DRIVEWAYS SHALL REMAIN OPEN TO LOCAL ACCESS AT ALL TIMES. W20-1 W20-4 48"x48" 48"x48" 2. FOR SIGN SIZES, REFER TO MUTCD. ROAD SIGN SPACING MAY BE ADJUSTED/REDUCED TO ACCOMMODATE DRIVEWAY APPROACHES. ∇ WORK TRAFFIC CONTROL AT DRIVEWAYS AHEAD DETAIL \square NO SCALE W20-1 48"x48" **CONFORMED DRAWINGS**


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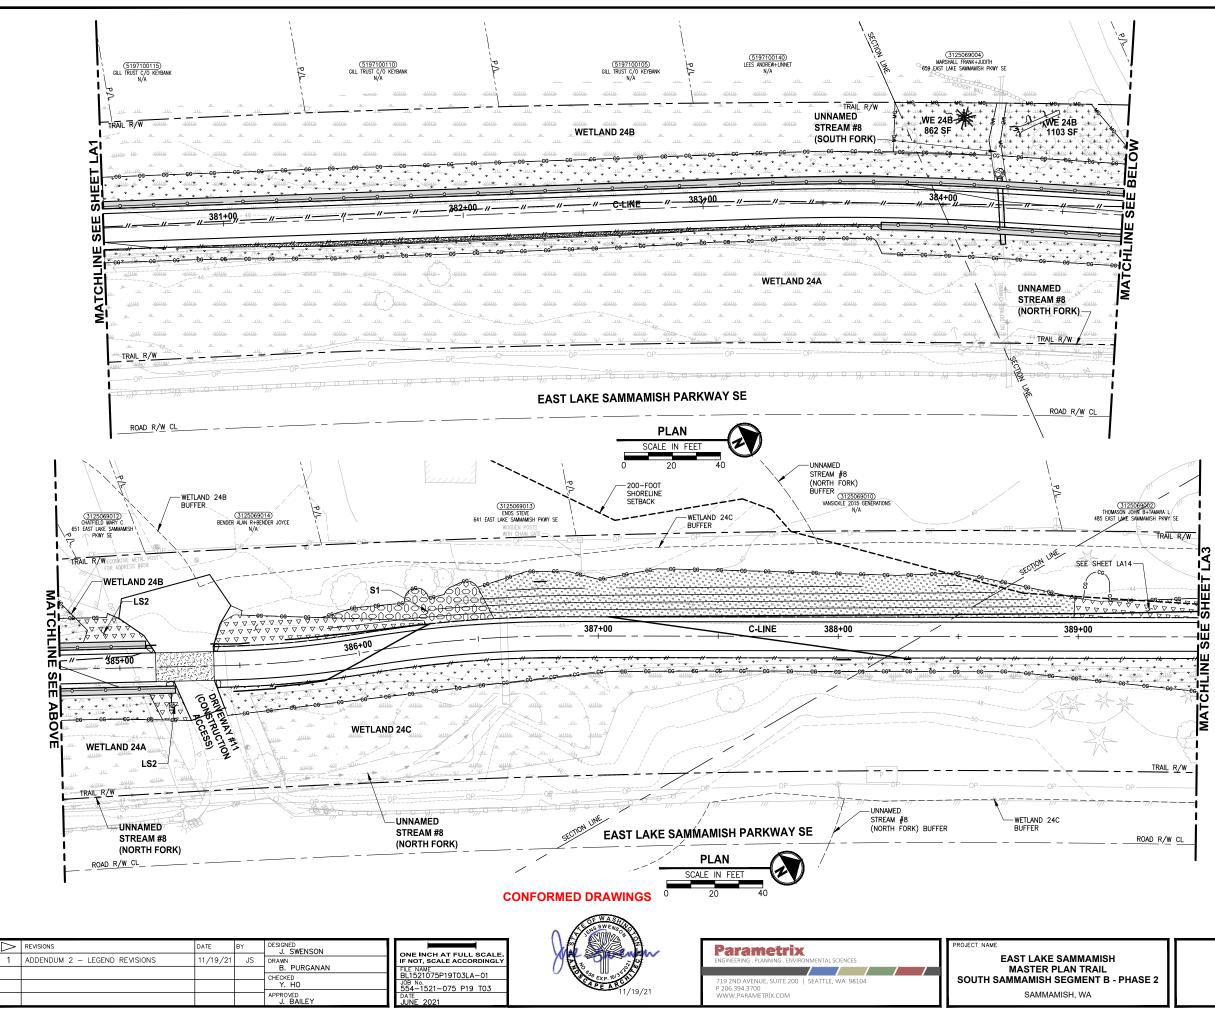


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MITIGATION CLEARING AND GRUBBING. CLEAR ALL UNWANTE VEGETATION AND GRUB ROOTS IN PLANTING AREA. REMOVE AND DISPOSE CLEARED VEGETATION LEAVING SOIL IN PLACE



HERBICIDE TREATMENT. TREAT UNWANTED VEGETATION IN PLANTING AREA WITH A NON-SELECTIVE HERBICIDE. MOW, CLEAR AND DISPOSE OF ALL UNWANTED VEGETATION. WAIT TO SEE REGROWTH AND TREAT WITH HERBICIDE A SECOND TIME. SEE SPECIFICATIONS FOR ADDITIONAL REQUIREMENTS

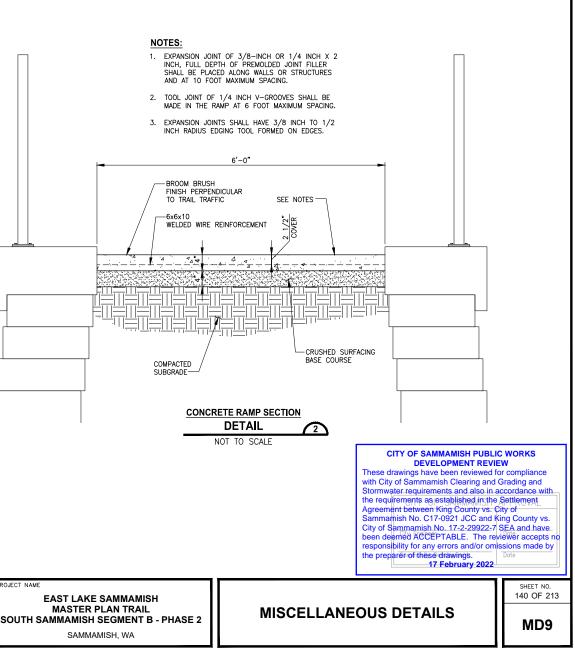3 SOIL AMENDMENT. PLACE 3" SOIL AMENDMENT AND TILL INTO SOIL TO A DEPTH OF 10" THROUGHOUT ENTIRE PLANTING AREA. SEE DETAIL 6 ON SHEET LD1.

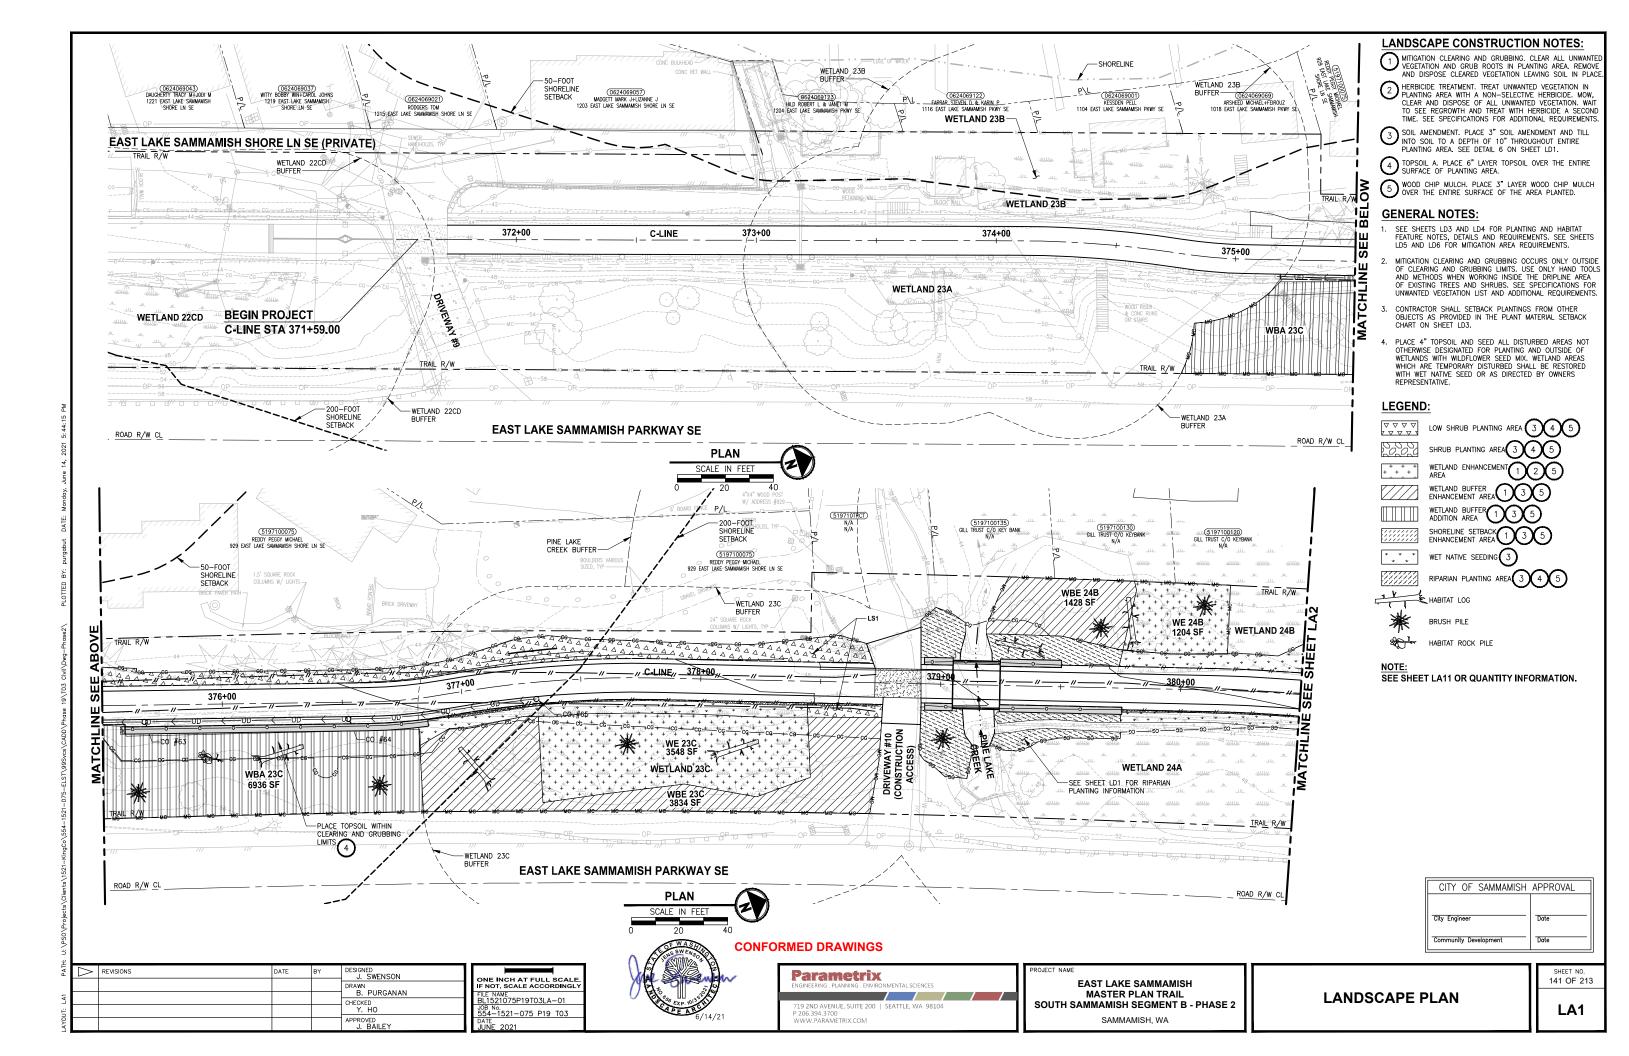4 TOPSOIL A. PLACE 6" LAYER TOPSOIL OVER THE ENTIRE SURFACE OF PLANTING AREA.

5 WOOD CHIP MULCH. PLACE 3" LAYER WOOD CHIP MULCH OVER THE ENTIRE SURFACE OF THE AREA PLANTED.

GENERAL NOTES:

- 1. SEE SHEETS LD3 AND LD4 FOR PLANTING AND HABITAT FEATURE NOTES, DETAILS AND REQUIREMENTS. SEE SHEETS LD5 AND LD6 FOR MITIGATION AREA REQUIREMENTS.
- MITIGATION CLEARING AND GRUBBING OCCURS ONLY OUTSIDE OF CLEARING AND GRUBBING LIMITS. USE ONLY HAND TOOLS AND METHODS WHEN WORKING INSIDE THE DRIPLINE AREA OF EXISTING TREES AND SHRUBS. SEE SPECIFICATIONS FOR UNWANTED VEGETATION LIST AND ADDITIONAL REQUIREMENTS.
- CONTRACTOR SHALL SETBACK PLANTINGS FROM OTHER OBJECTS AS PROVIDED IN THE PLANT MATERIAL SETBACK CHART ON SHEET LD3.
- 4. PLACE 4" TOPSOIL AND SEED ALL DISTURBED AREAS NOT OTHERWISE DESIGNATED FOR PLANTING AND OUTSIDE OF WETLANDS WITH WILDFLOWER SEED MIX. WETLAND AREAS WHICH ARE TEMPORARY DISTURBED SHALL BE RESTORED WITH WET NATIVE SEED OR AS DIRECTED BY OWNERS REPRESENTATIVE.

LEGEND	
	SEEDED LAWN INSTALLATION AREA 34
$ \begin{array}{c} \nabla \ \nabla $	LOW SHRUB PLANTING AREA 345
	SHRUB PLANTING AREA 345
+ + + + + + + + + + + + + + + + + + + +	WETLAND ENHANCEMENT 125
* * * * *	WET NATIVE SEEDING 3
11 to	HABITAT LOG
漱	BRUSH PILE
	HABITAT ROCK PILE
<u>NOTE:</u> SEE SHEE	T LA11 FOR QUANTITY INFORMATION.

ITY	OF	SAMMAMISH	APPROVAL

Community


С

City Engine

Date Date



LANDSCAPE PLAN Addendum 2

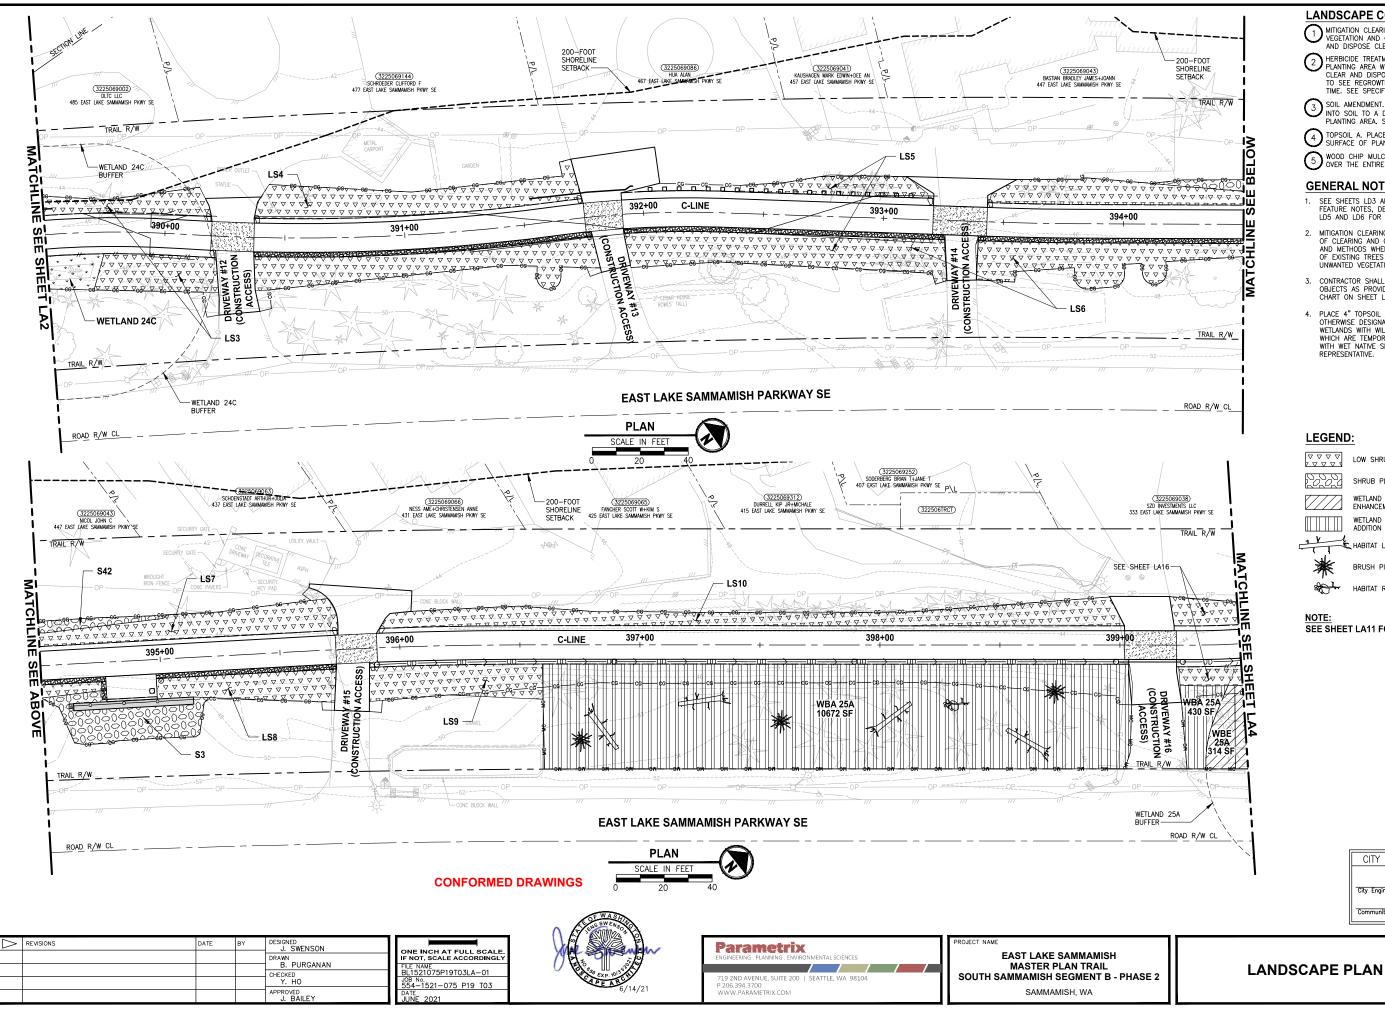

1 MITIGATION CLEARING AND GRUBBING, CLEAR ALL UNWANTE VEGETATION AND GRUB ROOTS IN PLANTING AREA. REMOVE VIGETATION AND GRUB ROOTS IN PLANTING AREA. REMOVE AND DISPOSE CLEARED VEGETATION LEAVING SOIL IN PLAC

HERBICIDE TREATMENT. TREAT UNWANTED VEGETATION IN PLANTING AREA WITH A NON-SELECTIVE HERBICIDE. MOW, CLEAR AND DISPOSE OF ALL UNWANTED VEGETATION. WAIT TO SEE REGROWTH AND TREAT WITH HERBICIDE A SECOND TIME. SEE SPECIFICATIONS FOR ADDITIONAL REQUIREMENTS

3 SOIL AMENDMENT. PLACE 3" SOIL AMENDMENT AND TILL INTO SOIL TO A DEPTH OF 10" THROUGHOUT ENTIRE INTO SOIL TO A DEPTH OF 10" THROUGHOUT ENTIRE PLANTING AREA. SEE DETAIL 6 ON SHEET LD1.

4 TOPSOIL A. PLACE 6" LAYER TOPSOIL OVER THE ENTIRE SURFACE OF PLANTING AREA.

 $\ensuremath{\textcircled{}}$ wood chip mulch. Place 3" layer wood chip mulch over the entire surface of the area planted.

GENERAL NOTES:

- 1. SEE SHEETS LD3 AND LD4 FOR PLANTING AND HABITAT FEATURE NOTES, DETAILS AND REQUIREMENTS. SEE SHEETS LD5 AND LD6 FOR MITIGATION AREA REQUIREMENTS.
- 2. MITIGATION CLEARING AND GRUBBING OCCURS ONLY OUTSIDE OF CLEARING AND GRUBBING LIMITS. USE ONLY HAND TOOLS AND METHODS WHEN WORKING INSIDE THE DRIPLINE AREA OF EXISTING TREES AND SHRUBS. SEE SPECIFICATIONS FOR UNWANTED VEGETATION LIST AND ADDITIONAL REQUIREMENTS.
- CONTRACTOR SHALL SETBACK PLANTINGS FROM OTHER OBJECTS AS PROVIDED IN THE PLANT MATERIAL SETBACK CHART ON SHEET LD3.
- 4. PLACE 4" TOPSOIL AND SEED ALL DISTURBED AREAS NOT OTHERWISE DESIGNATED FOR PLANTING AND OUTSIDE OF WETLANDS WITH WILDFLOWER SEED MIX. WETLAND AREAS WHICH ARE TEXPORARY DISTURBED SHALL BE RESTORED WITH WET NATIVE SEED OR AS DIRECTED BY OWNERS REPRESENTATIVE.


LEGEND	<u>):</u>
$\square \square \square \square \square$	LOW SHRUB PLANTING AREA 345
2002	SHRUB PLANTING AREA 345
	WETLAND BUFFER ENHANCEMENT AREA
	ADDITION AREA
-t-te	HABITAT LOG
漱	BRUSH PILE
	HABITAT ROCK PILE


NOTE: SEE SHEET LA11 FOR QUANTITY INFORMATION.

CITY OF SAMMAMISH	APPROVAL
City Engineer	Date


Community Development


SHEET 143 OF 213

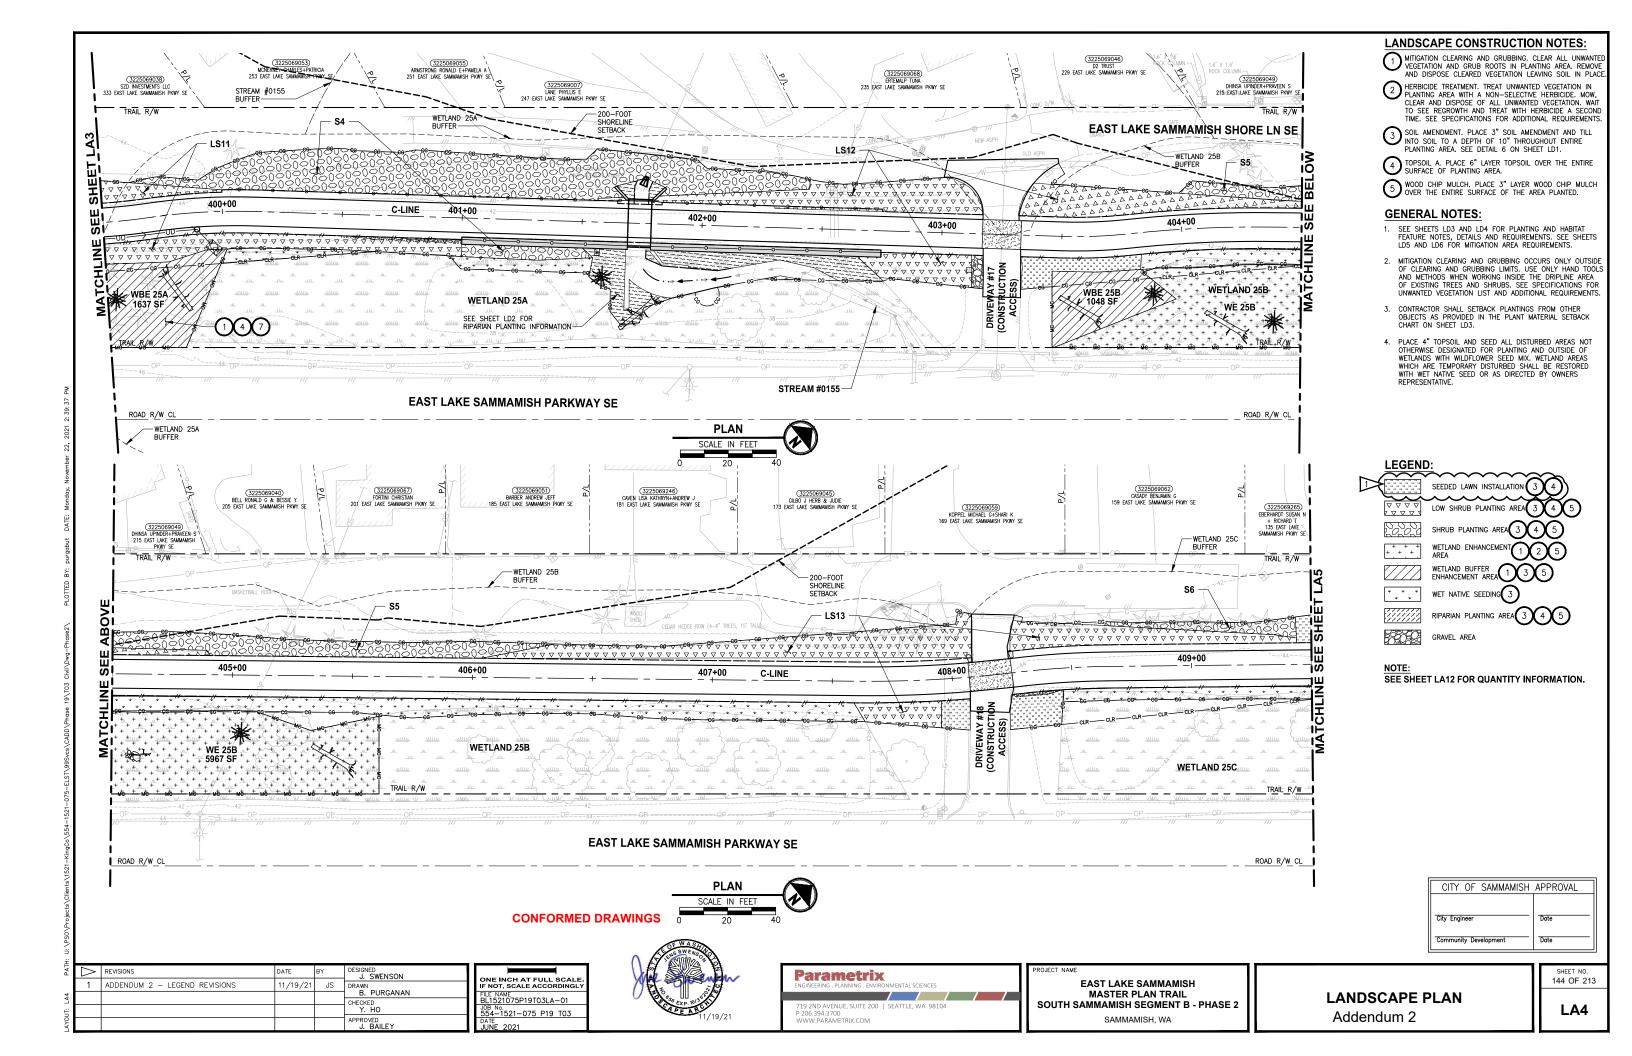

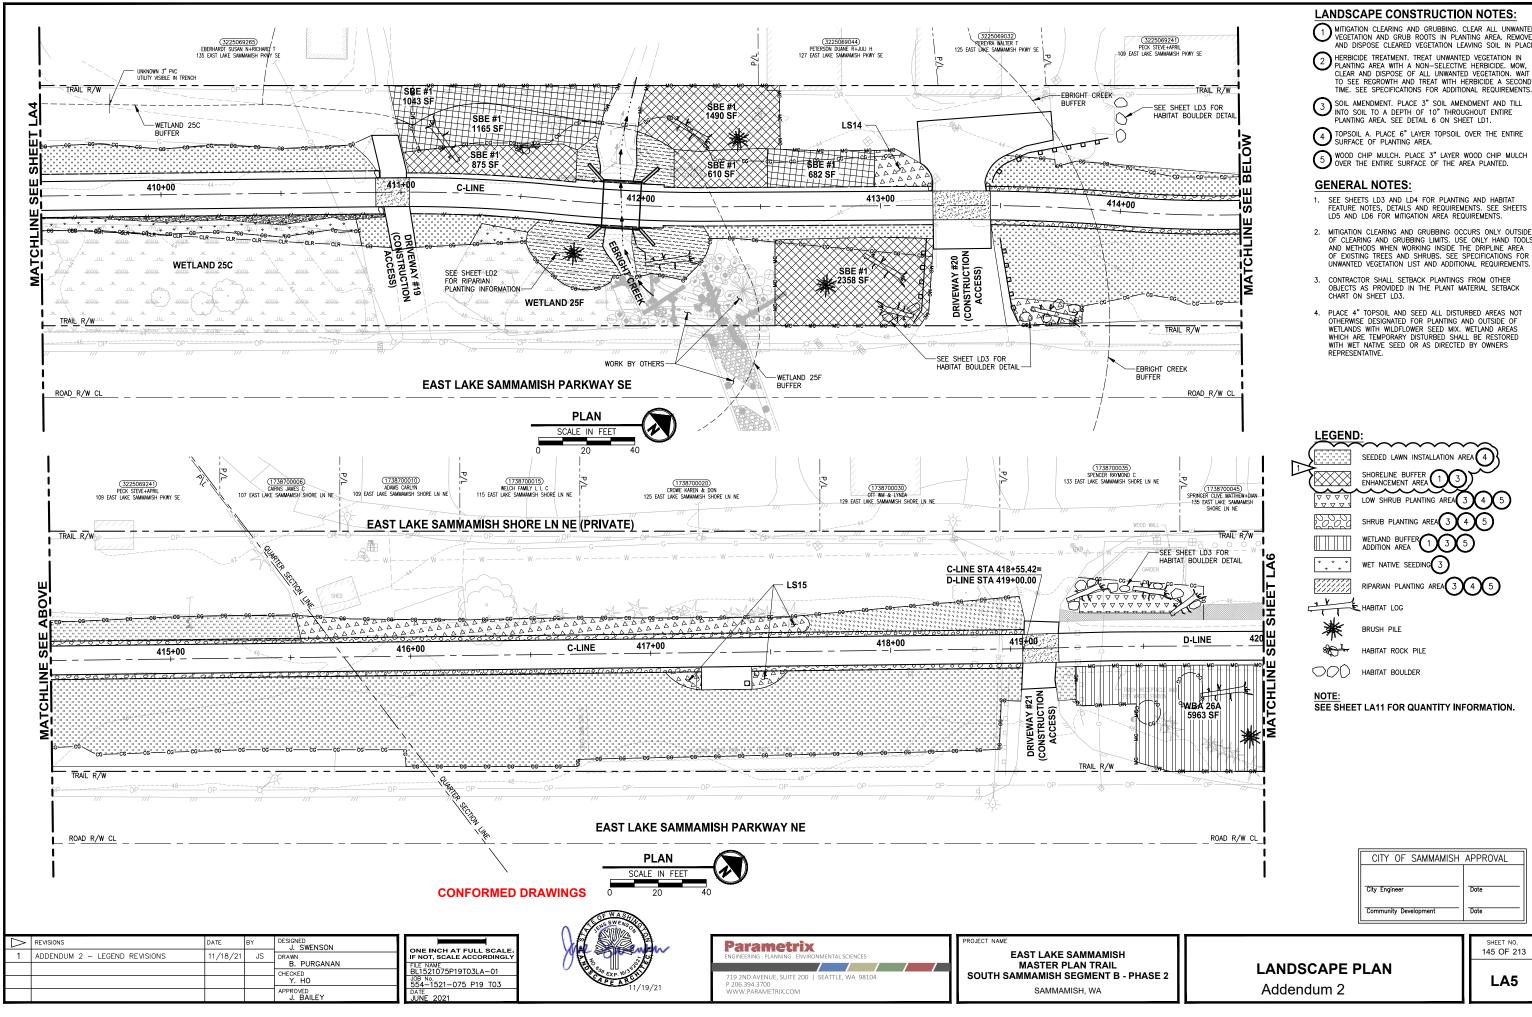

SHEET N 145 OF 213

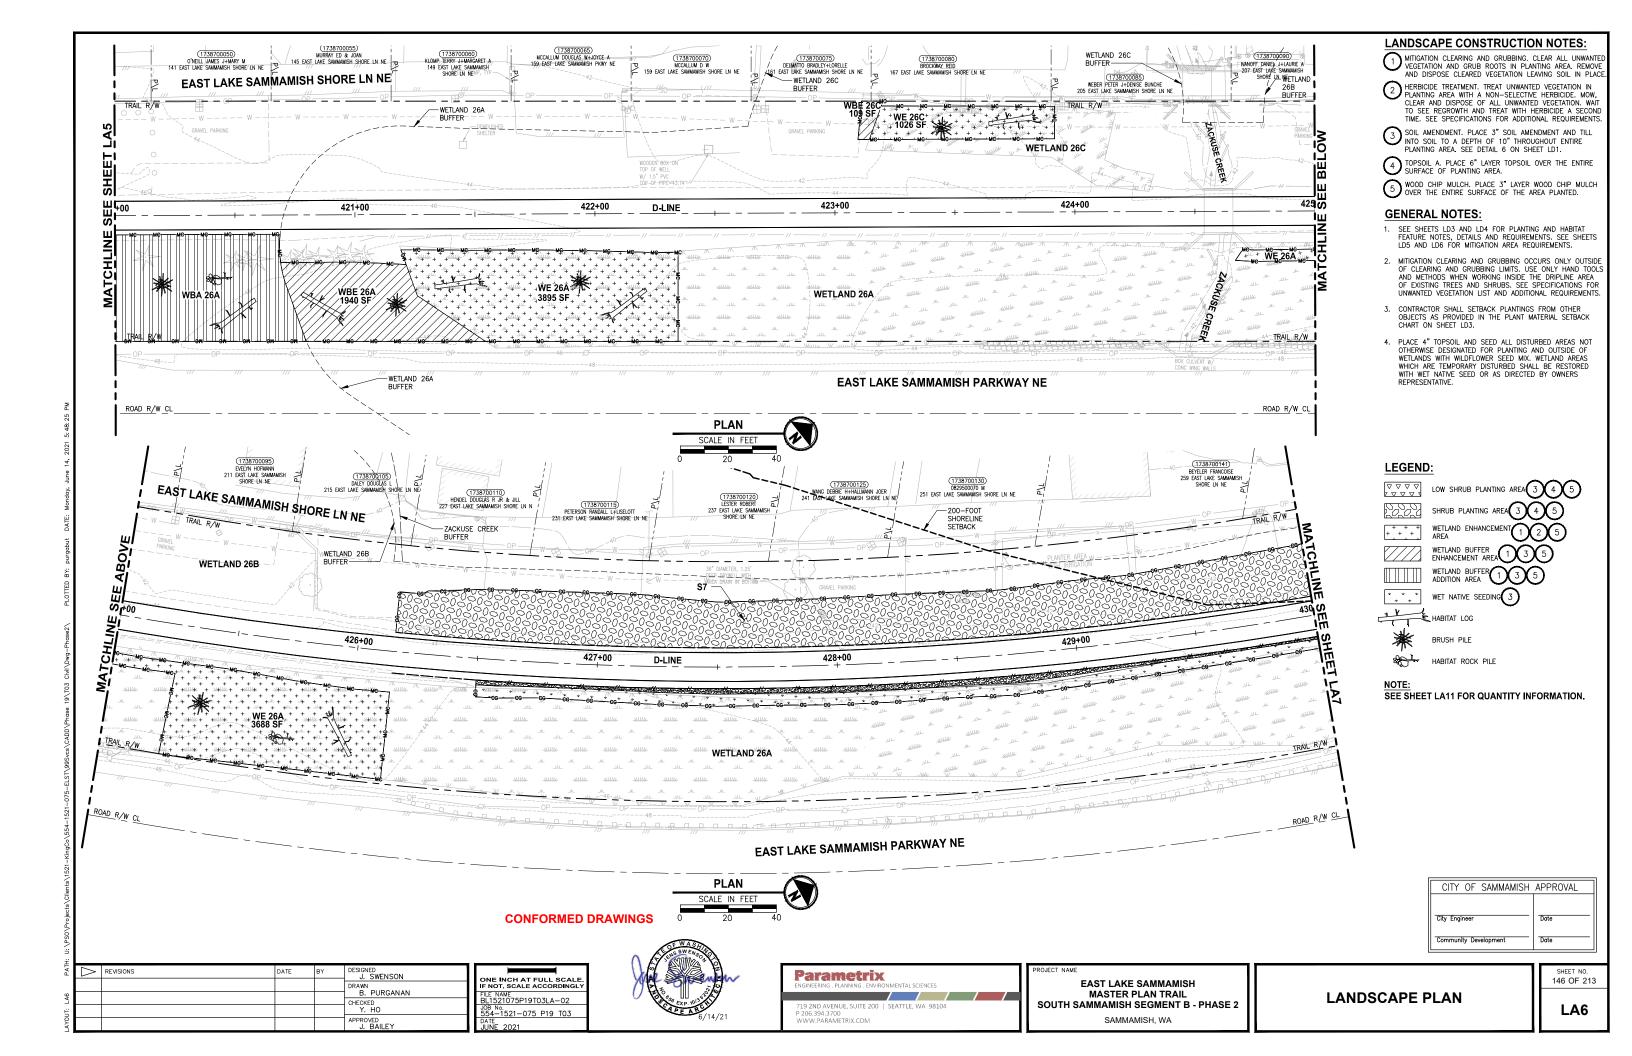

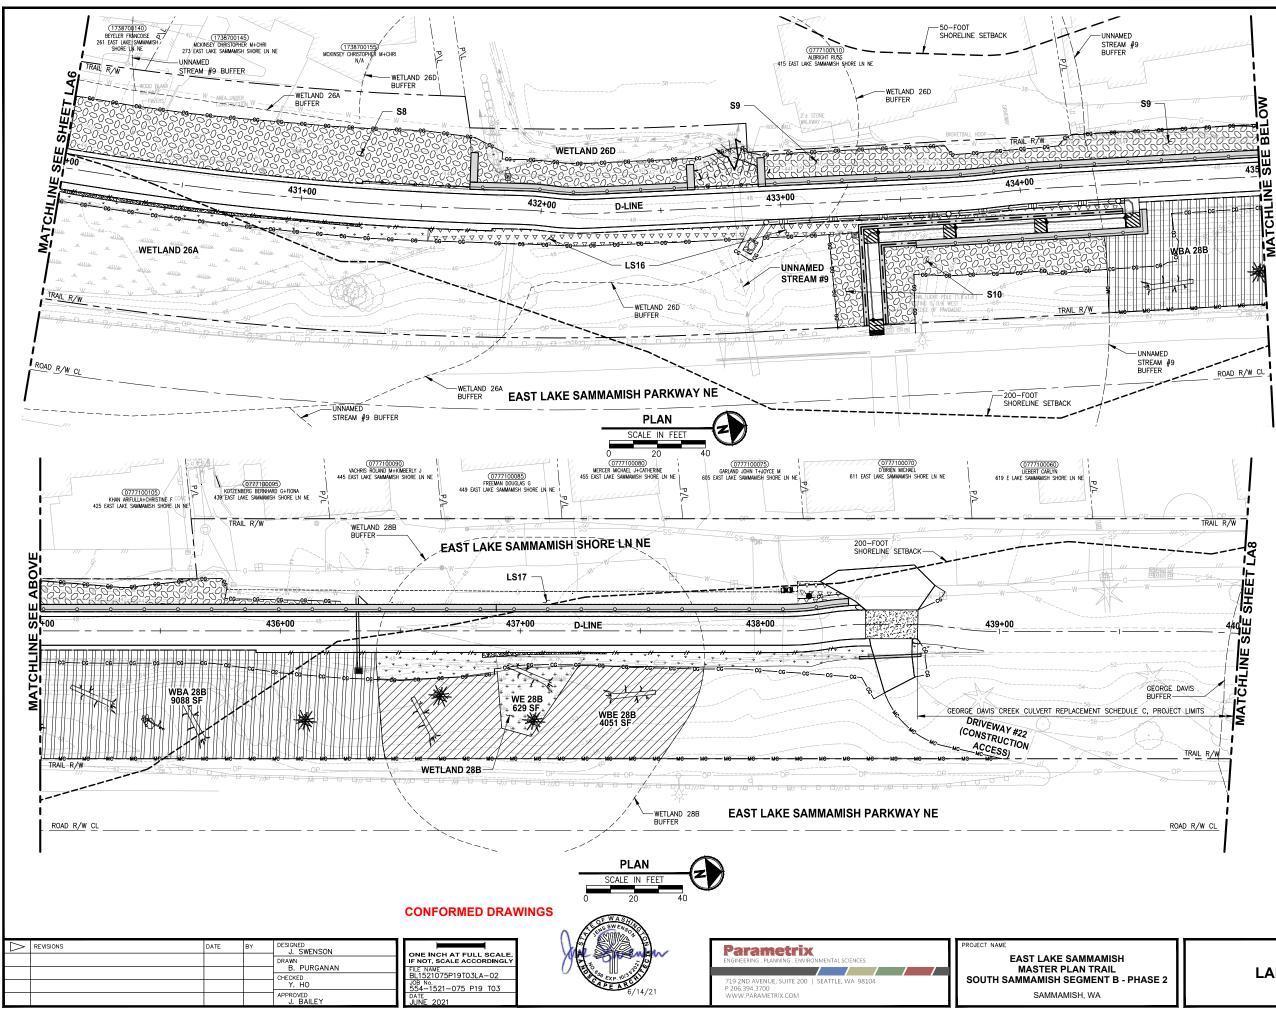


MITIGATION CLEARING AND GRUBBING. CLEAR ALL UNWANTE VEGETATION AND GRUB ROOTS IN PLANTING APEA DELIGIT VIGETATION AND GRUB ROOTS IN PLANTING AREA. REMOVE AND DISPOSE CLEARED VEGETATION LEAVING SOIL IN PLAC

- HERBICIDE TREATMENT. TREAT UNWANTED VEGETATION IN PLANTING AREA WITH A NON-SELECTIVE HERBICIDE. MOW, CLEAR AND DISPOSE OF ALL UNWANTED VEGETATION. WAIT TO SEE REGROWTH AND TREAT WITH HERBICIDE A SECOND TIME. SEE SPECIFICATIONS FOR ADDITIONAL REQUIREMENTS
- 3 SOIL AMENDMENT. PLACE 3" SOIL AMENDMENT AND TILL INTO SOIL TO A DEPTH OF 10" THROUGHOUT ENTIRE INTO SOIL TO A DEPTH OF 10" THROUGHOUT ENTIRE PLANTING AREA. SEE DETAIL 6 ON SHEET LD1.
- 4 TOPSOIL A. PLACE 6" LAYER TOPSOIL OVER THE ENTIRE SURFACE OF PLANTING AREA.
- 5 WOOD CHIP MULCH. PLACE 3" LAYER WOOD CHIP MULCH OVER THE ENTIRE SURFACE OF THE AREA PLANTED.

GENERAL NOTES:

- 1. SEE SHEETS LD3 AND LD4 FOR PLANTING AND HABITAT FEATURE NOTES, DETAILS AND REQUIREMENTS. SEE SHEETS LD5 AND LD6 FOR MITIGATION AREA REQUIREMENTS.
- 2. MITIGATION CLEARING AND GRUBBING OCCURS ONLY OUTSIDE OF CLEARING AND GRUBBING LIMITS. USE ONLY HAND TOOLS AND METHODS WHEN WORKING INSIDE THE DRIPLINE AREA OF EXISTING TREES AND SHRUBS. SEE SPECIFICATIONS FOR UNWANTED VEGETATION LIST AND ADDITIONAL REQUIREMENTS.
- CONTRACTOR SHALL SETBACK PLANTINGS FROM OTHER OBJECTS AS PROVIDED IN THE PLANT MATERIAL SETBACK CHART ON SHEET LD3.
- 4. PLACE 4" TOPSOIL AND SEED ALL DISTURBED AREAS NOT OTHERWISE DESIGNATED FOR PLANTING AND OUTSIDE OF WETLANDS WITH WILDFLOWER SEED MIX. WETLAND AREAS WHICH ARE TEMPORARY DISTURBED SHALL BE RESTORED WITH WET NATIVE SEED OR AS DIRECTED BY OWNERS REPRESENTATIVE.

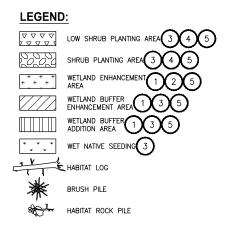



NOTE SEE SHEET LA12 FOR QUANTITY INFORMATION.

CITY OF SAMMAMISH	APPROVAL
City Engineer	Date
Community Development	Date

SHEET NO. 147 OF 213

LANDSCAPE PLAN

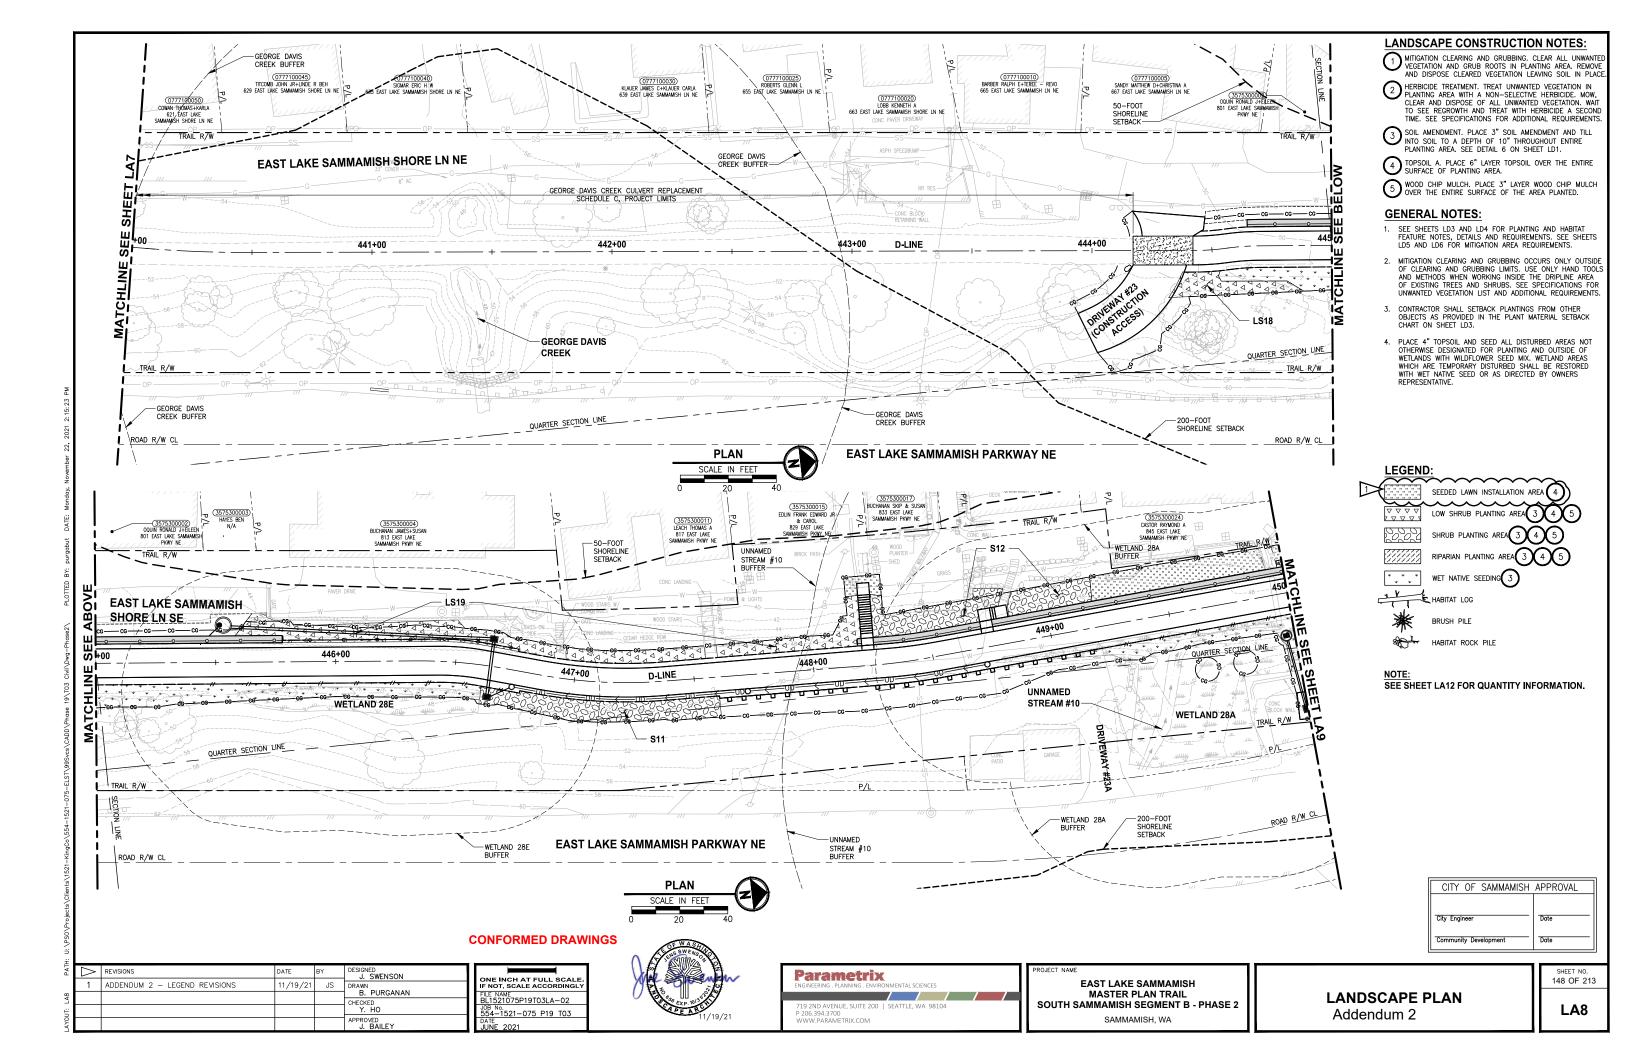

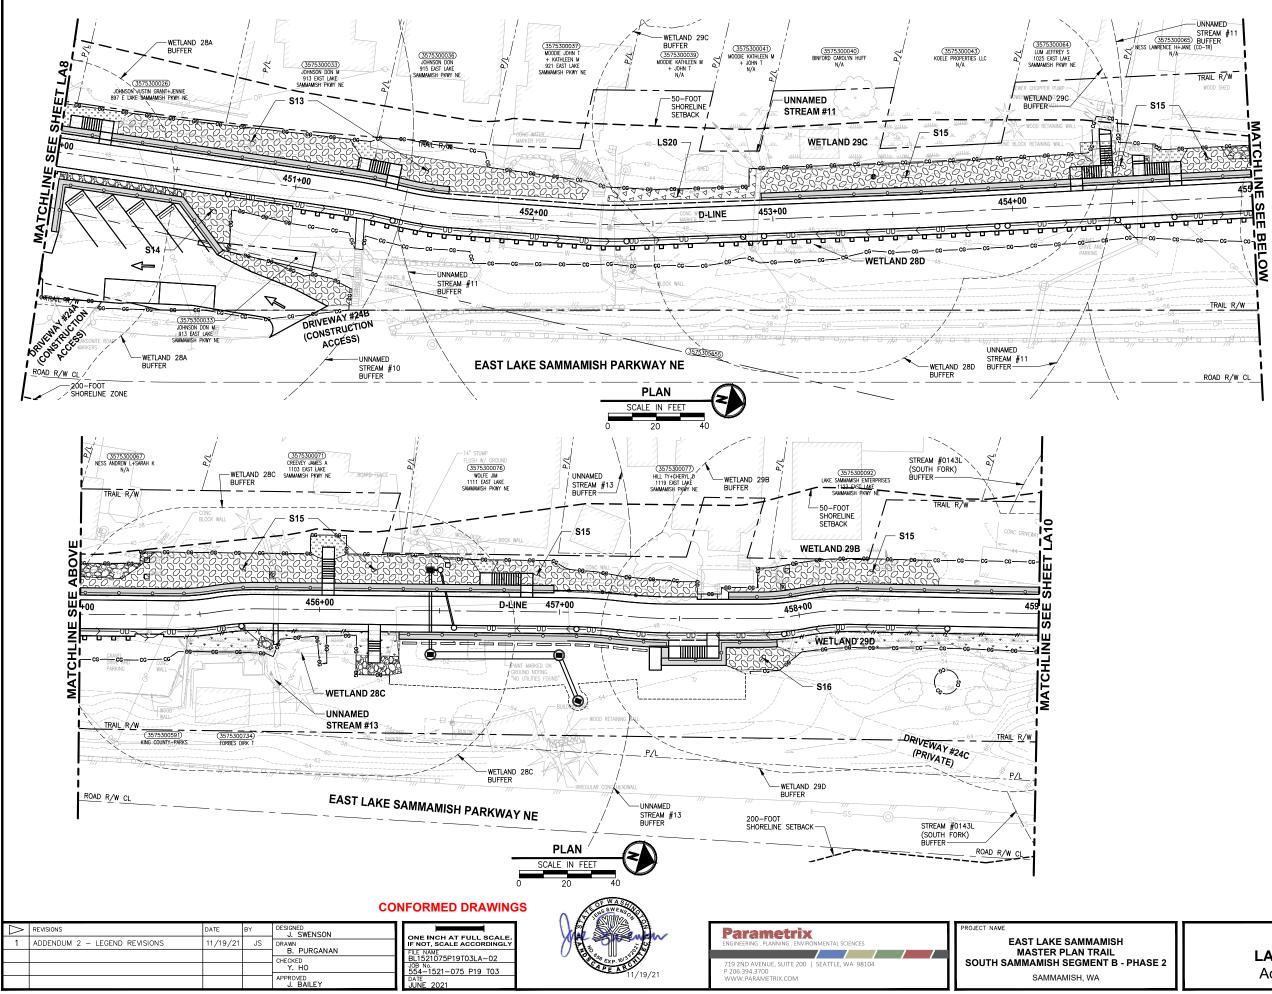

MITIGATION CLEARING AND GRUBBING. CLEAR ALL UNWANTED VEGETATION AND GRUB ROOTS IN PLANTING AREA. REMOVE AND DISPOSE CLEARED VEGETATION LEAVING SOIL IN PLACE

- HERBICIDE TREATMENT. TREAT UNWANTED VEGETATION IN PLANTING AREA WITH A NON-SELECTIVE HERBICIDE. MOW, CLEAR AND DISPOSE OF ALL UNWANTED VEGETATION. WAIT TO SEE REGROWTH AND TREAT WITH HERBICIDE A SECOND TIME. SEE SPECIFICATIONS FOR ADDITIONAL REQUIREMENTS.
- Soil Amendment. Place 3" Soil Amendment and Till into Soil to a depth of 10" Throughout entire planting area. See detail 6 on sheet LD1.
- 4 TOPSOIL A. PLACE 6" LAYER TOPSOIL OVER THE ENTIRE SURFACE OF PLANTING AREA.
- 5 WOOD CHIP MULCH. PLACE 3" LAYER WOOD CHIP MULCH OVER THE ENTIRE SURFACE OF THE AREA PLANTED.


GENERAL NOTES:

- 1. SEE SHEETS LD3 AND LD4 FOR PLANTING AND HABITAT FEATURE NOTES, DETAILS AND REQUIREMENTS. SEE SHEETS LD5 AND LD6 FOR MITIGATION AREA REQUIREMENTS.
- MITIGATION CLEARING AND GRUBBING OCCURS ONLY OUTSIDE OF CLEARING AND GRUBBING LIMITS. USE ONLY HAND TOOLS AND METHODS WHEN WORKING INSIDE THE DRIPLINE AREA OF EXISTING TREES AND SHRUBS. SEE SPECIFICATIONS FOR UNWANTED VEGETATION LIST AND ADDITIONAL REQUIREMENTS.
- CONTRACTOR SHALL SETBACK PLANTINGS FROM OTHER OBJECTS AS PROVIDED IN THE PLANT MATERIAL SETBACK CHART ON SHEET LD3.
- 4. PLACE 4" TOPSOIL AND SEED ALL DISTURBED AREAS NOT OTHERWISE DESIGNATED FOR PLANTING AND OUTSIDE OF WETLANDS WITH WILDFLOWER SEED MIX. WETLAND AREAS WHICH ARE TEMPORARY DISTURBED SHALL BE RESTORED WITH WET NATIVE SEED OR AS DIRECTED BY OWNERS REPRESENTATIVE.

LEGEND: SEEDED LAWN INSTALLATION AREA 3 4 VVVV LOW SHRUB PLANTING AREA 3 4 5 SHRUB PLANTING AREA 3 4 5 VVVV WET NATIVE SEEDING 3 GRAVEL AREA

NOTE: SEE SHEET LA12 FOR QUANTITY INFORMATION.

	CITY OF SAMMAMISH	APPROVAL
	City Engineer	Date
	Community Development	Date
		SHEET NO. 149 OF 213
IASE 2	LANDSCAPE PLAN Addendum 2	LA9

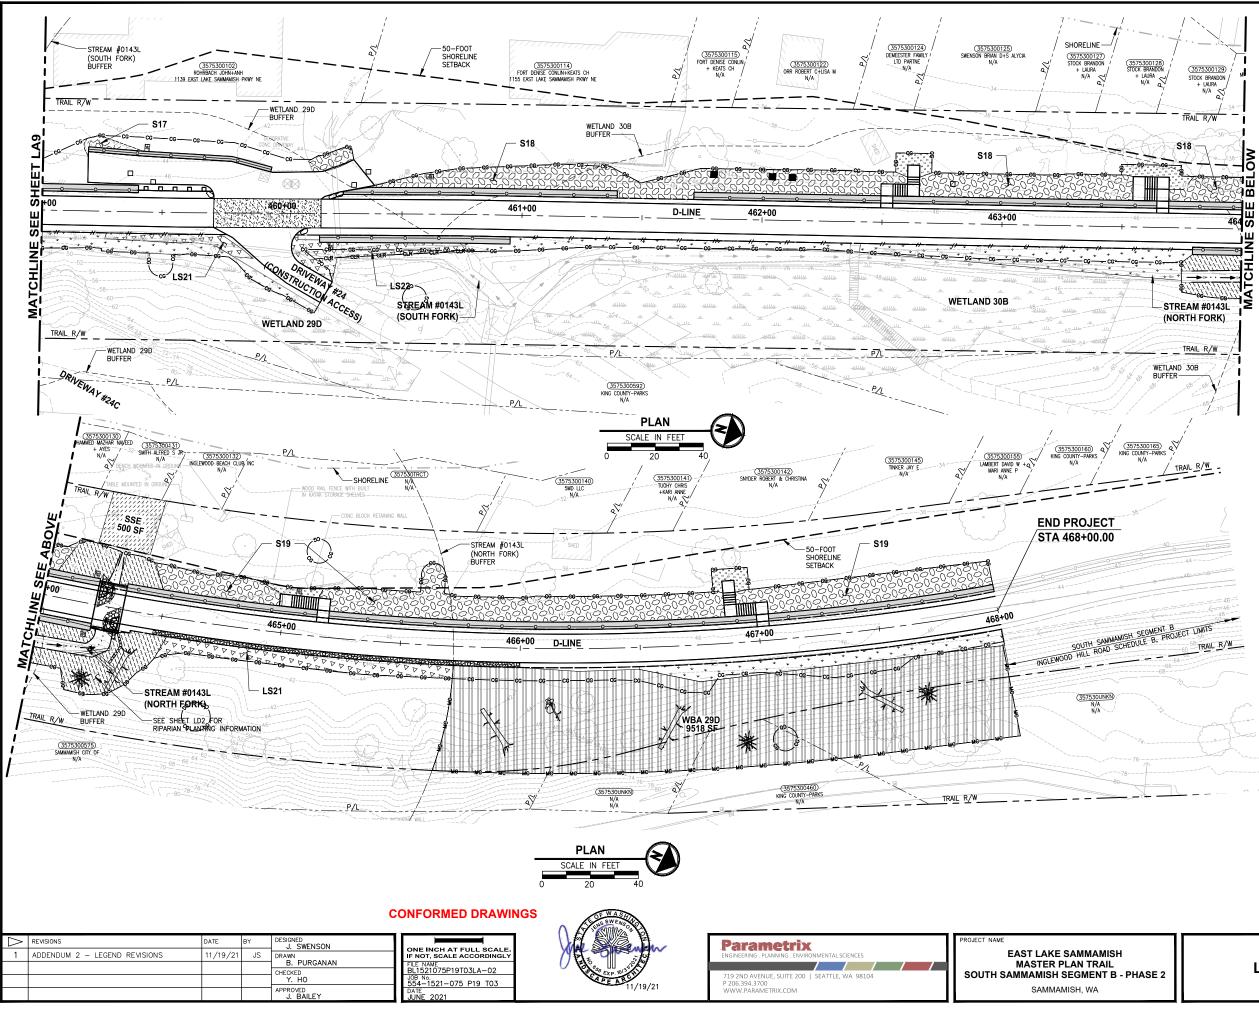

MITIGATION CLEARING AND GRUBBING. CLEAR ALL UNWANTED VEGETATION AND GRUB ROOTS IN PLANTING AREA. REMOVE AND DISPOSE CLEARED VEGETATION LEAVING SOIL IN PLACE

- HERBICIDE TREATMENT. TREAT UNWANTED VEGETATION IN PLANTING AREA WITH A NON-SELECTIVE HERBICIDE. MOW, CLEAR AND DISPOSE OF ALL UNWANTED VEGETATION. WAIT TO SEE REGROWTH AND TREAT WITH HERBICIDE A SECOND TIME. SEE SPECIFICATIONS FOR ADDITIONAL REQUIREMENTS.
- SOIL AMENDMENT. PLACE 3" SOIL AMENDMENT AND TILL INTO SOIL TO A DEPTH OF 10" THROUGHOUT ENTIRE PLANTING AREA. SEE DETAIL 6 ON SHEET LD1.
- 4 TOPSOIL A. PLACE 6" LAYER TOPSOIL OVER THE ENTIRE SURFACE OF PLANTING AREA.
- 5 WOOD CHIP MULCH. PLACE 3" LAYER WOOD CHIP MULCH OVER THE ENTIRE SURFACE OF THE AREA PLANTED.

GENERAL NOTES:

Γ

- 1. SEE SHEETS LD3 AND LD4 FOR PLANTING AND HABITAT FEATURE NOTES, DETAILS AND REQUIREMENTS. SEE SHEETS LD5 AND LD6 FOR MITIGATION AREA REQUIREMENTS.
- MITIGATION CLEARING AND GRUBBING OCCURS ONLY OUTSIDE OF CLEARING AND GRUBBING LIMITS. USE ONLY HAND TOOLS AND METHODS WHEN WORKING INSIDE THE DRIPLINE AREA OF EXISTING TREES AND SHRUBS. SEE SPECIFICATIONS FOR UNWANTED VEGETATION LIST AND ADDITIONAL REQUIREMENTS.
- CONTRACTOR SHALL SETBACK PLANTINGS FROM OTHER OBJECTS AS PROVIDED IN THE PLANT MATERIAL SETBACK CHART ON SHEET LD3.
- 4. PLACE 4" TOPSOIL AND SEED ALL DISTURBED AREAS NOT OTHERWISE DESIGNATED FOR PLANTING AND OUTSIDE OF WETLANDS WITH WILDFLOWER SEED MIX. WETLAND AREAS WHICH ARE TEMPORARY DISTURBED SHALL BE RESTORED WITH WET NATIVE SEED OR AS DIRECTED BY OWNERS REPRESENTATIVE.

	LEGENL	<u>):</u>
\triangleright	(SEEDED LAWN INSTALLATION AREA 3 4
		LOW SHRUB PLANTING AREA 3 4 5
	2022	SHRUB PLANTING AREA 345
		ADDITION AREA
		SHORELINE SETBACK 135
	* * * * *	WET NATIVE SEEDING
		RIPARIAN PLANTING AREA 345
	1 to	HABITAT LOG
	☀	BRUSH PILE
		HABITAT ROCK PILE

NOTE: SEE SHEET LA12 FOR QUANTITY INFORMATION.

IASE 2	LANDSCAPE F	PLAN	SHEET NO. 150 OF 213
		City Engineer Community Development	Dote
		CITY OF SAMMAMISH	APPROVAL

QUANTITY TAB -FOR SHEET LA1-	QUANTITYBYAREA										
	WBA 23C	WBA23C WBE23C LS1 WBE24B WE24B WET SEE									
Trees Area SF →	6936	3834	3548	2306	1428	1204	1808				
BIG LEAF MAPLE	10	5	-	-	2	-					
OREGON ASH	-	-	5	-	-	2					
SITKASPRUCE	5	3	5	-	1	2					
SHORE PINE	-	-	-	-	-						
BITTER CHERRY	10	5	-	-	2	-					
DOUGLAS FIR	10	5	-	-	2	-					
PACIFIC WILLOW	-	-	5	-	-	2					
SCOULERS WILLOW	5	3	5	-	1	2					
WESTERN RED CEDAR	5	3	5	-	1	2					
WESTERN HEMLOCK	5	3	-	-	1						
Shrubs							1				
VINE MAPLE	21	8	7		3	3					
		-									
WESTERN SERVICEBERRY	21	8	-	-	3	-					
RED-T WIG DOGWOOD	-	-	11	-	-	5					
WESTERN HAZEL	10	4	•	-	1	-					
OCEAN SPRAY	21	8	-	-	3	-					
BLACK TWINBERRY	-	-	7	-	-	3					
PACIFIC CRAB APPLE	-	-	7	-	-	3					
OSO BERRY	21	8	-	-	3	-					
MOCK ORANGE PACIFIC NINEBARK	21	8	- 7	-	3	-					
RED FLOWERING CURRANT	21	8	7	-	3	- 3					
		-	-	-							
NOOTKAROSE	21	8	-	-	3	-					
CLUSTERED ROSE	-	-	11	-	-	5					
SITKA WILLOW SNOWBERRY	- 31	- 12	11	-	- 4	5					
	31	12	11	-	4	5					
Low Shrubs				0.5							
SALAL	-	-	-	85	-	-					
MAHONIA REPENS	-	-	-	128	-	-					
SWORD FERN KELSEY DWARF DOGWOOD	-	-	-	128 43	-	-					
	-	-		10	•	-					
	-	-	-	21	-	-					
LAVENDER 'HIDCOTE'	-	-	-	21	-	-					
Other Items	0.407	0.050									
MITIGATION CLEAR & GRUB - ACRE	0.127	0.053	0.049	-	0.020	0.022	-				
HERBICIDE TREATMENT - SY SOIL AMENDMENT - ACRES	-	- 0.053	237	- 0.053	- 0.020	107	- 0.042				
TOPSOIL TYPE A - 6" DEPTH - CY	0.127	0.055	•	43	0.020	-	0.042				
WET NATIVE SEEDING - SY		-	-			-	- 201				
WOOD CHIP MULCH - CY	- 51	- 22	- 20	- 21	- 8	- 9	- 201				
HABITAT BRUSH PILE HABITAT LOG HABITAT ROCK PILE	2 1 1	- 1 -	1	-		1 -	-				

QUANTITY TAB -FOR SHEET LA2-		QUA	WTITYB'	Y AREA			
Planting Areas 🔶	WE24B	LS2	S1	LAWN	WET SEE	D	
Trees Area SF →	1965	1068	608	4254	11084		
OREGON ASH	-	-	-				
SITKA SPRUCE	-	-	-				
PACIFIC WILLOW	-	-	-				
SCOULERS WILLOW	-	-	-				
WESTERN RED CEDAR	-	-	-				
Shrubs							
VINE MAPLE	7	-	-				
RED-TWIG DOGWOOD	10	-	-				
BLACK TWINBERRY	7	-	-				
PACIFIC CRAB APPLE	7	-	-				
PACIFICNINEBARK	-	-	6				
RED FLOWERING CURRANT	7	-	6				
CLUSTERED ROSE	10	-	-				
SIT KA WILLOW	10	-	-				
SNOWBERRY	10	-	6			1	
Low Shrubs						1	
SALAL	-	39	-			1	
MAHONIA REPENS	-	59	-			1	
SWORD FERN	-	59	-			1	
KELSEY DWARF DOGWOOD	-	20	3			1	
DAYLILY	-	20	8			1	
Other Items							
MIT IGAT ION CLEAR & GRUB - ACRE	0.041	-	-	-	-		
HERBICIDE TREATMENT - SY	197	-	-	-	-		
SOIL AMENDMENT - ACRES	-	0.025	0.014	0.098	0.254	1	
TOPSOIL TYPE A - 6" DEPTH - CY	-	20	11	79	-		
WET NATIVE SEEDING - SY	-	-	-	-	1,232	2	
SEEDED LAWN - SY	-	-	-	473	-		
WOOD CHIP MULCH - CY	16	10	6	-	-		
HABITAT BRUSH PILE	1	-	-	-	-		
QUANTITY TAB	1	-	-	- NTITYBY			
-FOR SHEET LA5-			QUA		AREA		
Planting Areas →	SBE	LS14	LS15	LS16	WBA 26A	WET SEED	
Trees Area SF →	8223	300	1666	325	5963	1059	2191
BIG LEAF MAPLE	7	-	-	-	8	-	-
SITKASPRUCE	10	-	-	-	4	-	-
SHORE PINE	7	-	-	-	8	-	-
BITTER CHERRY	10	-	-	-	8	-	-
DOUGLAS FIR	10	-	-	-	4	-	-
PACIFIC WILLOW	7	-	-	-	-	-	-
SCOULERS WILLOW	7	-	-	-	4	-	-
WESTERN RED CEDAR	10	-	-	-	4	-	-
Shrubs							
VINE MAPLE	28	-	-	-	7	-	-
WESTERN SERVICEBERRY	28	-	-	-	7	-	-
WESTERN HAZEL	14	-	-	-	3	-	-
OCEAN SPRAY	28	-	-	-	7	-	-
OSO BERRY	28	-	-	-	7	-	-
MOCK ORANGE	28	-	-	-	7	-	-
PACIFIC NINEBARK	28	-	-	-	7	-	-
RED FLOWERING CURRANT	28	-	-	-	7	-	-
NOOTKAROSE	28				7		-
SNOWBERRY	42	-	-	8	10	-	-
Low Shrubs							
SALAL	24	-	31	-	73		-
MAHONIA REPENS	49	11	77	8	73		-
SWORD FERN	49	6	31	5	75	-	-
	49 -	6 11	31 31	5 6	75 -	-	-

QUANTITY TAB QUANTITY BY ARE -FOR SHEET LA3-											
Planting Areas \rightarrow	LS3	LS4	LS5	LS6	LS7	S2	S3	LS8	LS9	WBA 25A	LS10
Trees Area SF →	1690	3032	2300	1485	2110	290	637	795	976	11102	2129
BIG LEAF MAPLE	-	-	-	-	-	-	-	-	-	13	-
SHORE PINE	-	-	-	-	-	-	-	-	-	13	-
BITTER CHERRY	-	-	-	-	-	-	-	-	-	13	-
DOUGLAS FIR	-	-	-	-	-	-	-	-	-	10	-
WESTERN RED CEDAR	-	-	-	-	-	-	1	-	-	10	-
WESTERN HEMLOCK	-	-	-	-	-	-	-	-	-	6	-
WHITE WONDER DOGWOOD	-	-	-	-	-	-	3	-	-	-	-
JAPANESE FLOWERING CHERRY	-	-	-	-	-	-	2	-	-	-	-
Shrubs											
VINE MAPLE	-	-	-	-	-	-	-	-	-	16	-
WEST ERN SERVICEBERRY	-	-	-	-	-	-	-	-	-	16	-
WESTERN HAZEL	-		-			-	-		-	8	-
OCEAN SPRAY	-	-	-	-	-	-	-	-		16	-
TALL OREGON GRAPE	-	-	-	-	-	4	-	-		-	-
OSO BERRY	-	-	-	-	-	-	-	-	-	16	
MOCKORANGE	-	-	-	-	-	-	4	-	-	16	-
PACIFIC NINEBARK	-	-	-	-	-	-	4	-	-	16	-
RED FLOWERING CURRANT	-	-	-	-	-	4	8	-	-	16	-
NOOTKAROSE	-	-	-	-	-	-	-	-	-	16	-
SNOWBERRY	-	-	-	-	-	-	8	-	-	23	-
EMERALD GREEN ARBORVITAE	-	-	-	-	-	4	-	-	-	-	-
Low Shrubs											
SALAL	62	112	85	55	58	-	-	22	-	115	59
MAHONIA REPENS	78	112	85	55	78	-	-	37	45	115	98
SWORD FERN	78	112	85	55	58	-	-	29	-	119	98
KELSEY DWARF DOGWOOD	31	56	42	27	78	3	-	22	36	-	39
DAYLILY	31	84	21	41	39	8	-	7	36	-	39
AVENDER 'HIDCOTE'	-	-	42	-	19	-	-	7	18	-	-
LIME MOUND SPIREA	-	-	21	-	19	-	-	7	18	-	-
DAVIDS VIBURNUM	31	84	42	41	39	-	-	15	27	-	59
Other Items							ĺ			İ	
MITIGATION CLEAR & GRUB - ACRE	-	-	-	-	-	-	-	-	-	0.153	-
SOIL AMENDMENT - ACRES	0.039	0.070	0.053	0.034	0.048	0.007	0.015	0.018	0.022	0.153	0.049
TOPSOIL TYPE A - 6" DEPTH - CY	31	56	43	28	39	5	12	15	18	-	39
WOOD CHIP MULCH - CY	16	28	21	14	20	3	6	7	9	62	20
HABIT AT BRUSH PILE	-	-	-	-	-	-	-	-		3	-
HABIT AT LOG	-	-	-	-	-	-	-	-	-	4	-
HABITAT ROCK PILE	-	-	-	-	-	-	-	-	-	1	-

DATE E		ONE INCH AT FULL SCALE.
	DRAWN	IF NOT, SCALE ACCORDINGLY
	B. PURGANAN CHECKED	FILE NAME BL1521075P19T03LA-03
	Y. HO	JOB No. 554-1521-075 P19 T03
	APPROVED J. BAILEY	DATE JUNE 2021

LAVENDER 'HIDCOTE' LIME MOUND SPIREA

DAVIDS VIBURNUM

SEEDED LAWN - SY

WOOD CHIP MULCH - CY

HABIT AT BRUSH PILE

HABITAT ROCK PILE

HABIT AT LOG

SOIL AMENDMENT - ACRES

TOPSOIL TYPE A - 6" DEPTH - CY WET NATIVE SEEDING - SY

HABITAT BOULDER FOUR MAN

 Other Items

 MIT IGAT ION CLEAR & GRUB - ACRE
 0.151



62 11

0.038 0.007

15

6 31

0.151 0.007

-

61

2

4

1

2 4 5

0.082

0.082

0.024

406 118

2,434

CONFORMED DRAWINGS



EAST LAKE SAMMAMISH MASTER PLAN TRAIL SOUTH SAMMAMISH SEGMENT B - PHASE 2 SAMMAMISH, WA

QUANTITY TAB -FOR SHEET LA4-					QUA	NTITYBY	'AREA				
Planting Areas →	LS11	S4	LS12		WBE25B		S5	LS13	S6	WET SEED	LAW
Trees Area SF →	1819	4107	2782	1951	1048	5967	1451	2756	305	2791	841
BIG LEAF MAPLE	-	-	-	2	1	-	-	-	-	-	-
OREGON ASH	-	-	-	-	-	8	-	-	-	-	-
SITKASPRUCE	-	-	-	3	1	8	-	-	-	-	-
SHORE PINE	-	4	-	-	1	-	-	-	-	-	-
BITTER CHERRY	-	-	-	2	1	-	-	-	-	-	-
DOUGLAS FIR	-	7	-	1	1	-	-	-	-	-	-
PACIFIC WILLOW	-	-	-	-	-	8	-	-	-	-	-
SCOULERS WILLOW	-	-	-	-	1	8	-	-	-	-	-
WESTERN RED CEDAR	-	6	-	-	1	8	-	-	-	-	-
WESTERN HEMLOCK	-	-	-	2		-	-	-	-	-	-
WHITE WONDER DOGWOOD	-	6	-				-	-		-	-
EXCELSA CEDAR		6									-
Shrubs											
VINE MAPLE	-	21		8	4	18	7	-	-	-	
WESTERN SERVICEBERRY	-	21	-	8	4	10	-	-	-	-	
RED-T WIG DOGWOOD		7		-	- 4	- 36		-	-	-	
WESTERN HAZEL		-		- 4	- 2	- 30		-	-	-	
OCEAN SPRAY				4	4						
	-	-	-			- 18	-	-	-	-	-
BLACK TWINBERRY	-	-	-	-	•	18	-	-	-	-	-
TALL OREGON GRAPE	-	21	-	-	-	-	4	-	4	-	-
PACIFIC CRAB APPLE	-	-		-	-	18	-	-	-	-	-
PACIFIC WAX MYRTLE	-	-	-	-	-	-	8	-	-	-	-
OSO BERRY	-	-	-	8	4	-	-	-	-	-	-
MOCKORANGE	-	-	-	8	4	-	-	-	-	-	-
PACIFIC NINEBARK	-	21	-	8	4	18	4	-	-	-	-
RED FLOWERING CURRANT	-	21	-	8	4	-	4	-	3	-	-
NOOTKAROSE	-	-	-	8	4	-	-	-	-	-	-
CLUST ERED ROSE	-	-	-	-	-	18	-	-	-	-	-
SITKAWILLOW	-	-	-	-	-	36	-	-	-	-	-
SNOWBERRY	-	28	-	12	6	18	-	-	2	-	-
WINGED EUONYMUS	-	-	-	-	-	-	-	-	2	-	-
Low Shrubs											
SALAL	50	-	51	-	-	-	-	51	-	-	-
MAHONIA REPENS	84	23	128	-	-	-	32	102	-	-	-
SWORD FERN	67	8	128	-	-	-	32	51	-	-	-
KELSEY DWARF DOGWOOD	34	23	103	-	-	-	24	51	6	-	-
DAYLILY	34	23	103	-	-	-	24	102	-	-	-
LAVENDER 'HIDCOTE'	17	-	-	-	-	-	16	51	-	-	-
LIME MOUND SPIREA	17	-	-	-	•	-	16	51	-	-	-
DAVIDS VIBURNUM	34	-	-	-	-	-	16	51	6	-	-
Other Items											
MITIGATION CLEAR & GRUB - ACRE	-	-		0.045	0.024	0.110	-			-	-
HERBICIDE TREATMENT - SY	-	-	-	-	-	530	-	-	-	-	-
SOIL AMENDMENT - ACRES	0.042	0.094	0.064	0.045	0.024	-	0.033	0.063	0.007	0.064	0.01
TOPSOIL TYPE A - 6" DEPTH - CY	34	76	52	-	-	-	27	51	6	-	1
WET NATIVE SEEDING - SY	-	-		-	-	-	-	-	-	310	-
SEEDED LAWN - SY	-	-		-	-	-				-	ç
WOOD CHIP MULCH - CY	17	38	26	18	10	44	13	26	3	-	-
HABITAT BRUSH PILE	-	-	-	1	1	2	-	-	-	-	
HABITAT LOG				1	1	2				-	
HABIT AT ROCK PILE	-	-	-	-	-	1	-	-	-	-	-

CITY OF SAMMAMISH	APPROVAL
City Engineer	Date

Community Development	Date

SHEET NO. 151 OF 213

LANDSCAPE SCHEDULE

QUANTITY TAB -FOR SHEET LA6-	QUANT IT Y BY AREA						
Planting Areas -	÷	WBE26A	WE26A	WBE26C	WE26C	WET SEED	S7
Trees Area SF -	>	1940	7583	109	1026	1694	7743
BIG LEAF MAPLE		4	-	-	-	-	8
OREGON ASH		-	14	-	2	-	-
SITKASPRUCE		2	14	-	2	-	-
SHORE PINE		4	-	-	-	-	8
BITTER CHERRY		4	-	-	-	-	-
DOUGLAS FIR		2	-	-	-	-	-
PACIFIC WILLOW		-	14	-	2	-	-
SCOULERS WILLOW		2	14	-	2	-	-
WESTERN RED CEDAR		2	14	1	2	-	-
WHITE WONDER DOGWOOD	-	-	-	-	-	-	8
EXCELSA CEDAR	-		_				16
Shrubs	-	-		-	-	-	10
	_	_					
VINEMAPLE	_	7	28	-	4	-	24
WESTERN SERVICEBERRY		7	-	-	-	-	24
RED-T WIG DOGWOOD		-	42	-	6	-	-
WESTERN HAZEL		4	-	-	-	-	-
OCEAN SPRAY		7	-	-	-	-	24
BLACK TWINBERRY		-	28	-	4	-	-
TALL OREGON GRAPE		-	-	4	-	-	36
PACIFIC CRAB APPLE		-	28	-	4	-	-
MYRICA CALIFORNICA		-	-	-		-	12
OSO BERRY		7	-	-	-	-	-
MOCKORANGE		7	-	-	-	-	24
PACIFIC NINEBARK		7	-	-	-	-	24
RED FLOWERING CURRANT		7	28	-	4	-	24
NOOTKAROSE		7	-	-	-	-	12
CLUST ERED ROSE		-	42	-	6	-	-
SITKAWILLOW		-	42	-	6	-	-
SNOWBERRY		11	42	-	6	-	36
WINGED EUONYMUS		-	-	-	-	-	-
Low Shrubs						1	
SALAL		-	-	-	-	-	47
MAHONIA REPENS		-	-	-	-	-	79
SWORD FERN		-	-	-	-	-	79
KELSEY DWARF DOGWOOD		-	-	-	-	-	31
DAYLILY		-	-	-	-	-	47
LAVENDER 'HIDCOT E'		-	-	-	-	-	31
LIME MOUND SPIREA		-	-	-	-	-	-
DAVIDS VIBURNUM		-	-	-	-	-	-
Other Items							
MITIGATION CLEAR & GRUB - ACRE		0.036	0.139	0.003	0.024	-	-
HERBICIDE TREATMENT - SY		-	674	-	114	-	
SOIL AMENDMENT - ACRES		0.036	-	0.003	-	0.039	0.178
TOPSOIL TYPE A - 6" DEPTH - CY		-		-		-	143
WET NATIVE SEEDING - SY		-	-	-		188	-
WOOD CHIP MULCH - CY		14	56	1	10	-	72
HABITAT BRUSH PILE	-	1	1	-	10	-	-
HABITAT LOG		1	2	-	1	-	-
			2				

-	ITITY TAB HEET LA7-	QUANT IT Y BY AREA								
	Planting Areas 🔶	S8	S9	S10	LS17	WBA 28B	WBE28B	WE28B	WET SEED	LS18
Trees	Area SF 🔶	3758	2704	1885	1188	12666	4051	629	2006	137
BIG LEAF MAPLE		4	-	-	-	12	5	-	-	-
OREGON ASH		-	-	-	-	-	-	-	-	-
SITKASPRUCE		-	-	-	-	6	2	1	-	-
SHORE PINE		4	-	5	-	12	5	-	-	-
BITTER CHERR	Y	-	-	-	-	12	5	-	-	-
DOUGLAS FIR		-	-	-	-	6	2	-	-	-
PACIFIC WILLOV	V	-	-	-	-	-	-	2	-	-
SCOULERS WIL	LOW	-		-		6	2	-	-	
WESTERN RED	CEDAR			-		6	2	2		
WHITE WONDER		4	-	5	-	-	-	-	-	
	VERING CHERRY			-						
EXCELSA CEDA		- 9							-	
	۲	A	-	-	-	-	-	-	-	-
Shrubs		10	_				10			
	1050500)/	12	7	-	-	23	16	2	-	-
WESTERN SERV		12	7	-	-	23	16	-	-	-
RED-T WIG DOG		-	-	-	-	-	-	4	-	-
WESTERN HAZE	EL.	-	-	-	-	12	8	-	-	-
OCEAN SPRAY		12	7	5	-	23	16	-	-	-
BLACK TWINBE		-	-	-	-	-	-	2	-	-
TALL OREGON		18	10	8	-	-	-	-	-	-
PACIFIC CRAB A		-	-	-		-	-	2	-	-
PACIFIC WAX MY	/RTLE	6	3	-	-	-	-	-	-	-
OSO BERRY		-	-	5	-	23	16	-	-	-
MOCK ORANGE		12	7	8	-	23	16	-	-	-
PACIFIC NINEBA		12	7	8	-	23	16	2	-	-
RED FLOWERIN	G CURRANT	12	7	8	-	23	16	-	-	-
NOOTKAROSE		6	3	-	-	23	16	-	-	-
CLUST ERED RC	DSE	-	-	-		-	-	4	-	-
SITKAWILLOW		-	-	-	-	-	-	4	-	-
SNOWBERRY		18	10	11	-	35	25	4	-	-
WINGED EUONY	MUS	-	-	-	-	-	-	-	-	-
Low Shrubs										
SALAL		21	-	14	-	-	-	-	-	-
MAHONIA REPE	NS	35	45	23	55	-	-	-	-	6
SWORD FERN		28	-	18	22	-	-	-	-	3
KELSEY DWARF	DOGWOOD	28	45	18	33	-	-	-	-	4
DAYLILY		28	22	18	33	-	-	-	-	4
LAVENDER 'HIDO	COTE'	-	22	-	22	-	-	-	-	6
LIME MOUND SE	PIREA		45	-	44	-	-	-	-	Ę
DAVIDS VIBURNI	JM	-	45	-	11	-	-	-	-	-
Other Items										
	EAR & GRUB - ACRE		-	-	-	0.291	0.093	0.014	-	-
HERBICIDE TRE	ATMENT - SY		-	-	-	-	-	70	-	-
SOIL AMENDME	NT - ACRES	0.086	0.062	0.043	0.027	0.291	0.093	-	0.046	0.003
	A-6" DEPTH - CY	70	50	35	22	-	-		-	
WET NATIVE SE		-	-	-	-	-	-	-	223	-
WOOD CHIP MU		35	25	17	11	117	38	6	-	
HABITAT BRUSH		-	-	-	-	3	1	-	-	
HABITAT LOG		-		-	-	5	2	1	-	

QUANTITY TAB -FOR SHEET LA8-	QUANTITYBYAREA					
Planting Areas 🔶	LS19	LS20	S11	S12	LAWN	WET SEED
Shrubs Area SF →	348	1707	823	904	803	2053
VINE MAPLE	-	-	-	4	-	-
WESTERN SERVICEBERRY	-	-	-	4	-	-
TALL OREGON GRAPE	-	-	2	4	-	-
RED FLOWERING CURRANT	-	-	2	5	-	-
CLUST ERED ROSE	-	-	2	-	-	-
SNOWBERRY	-	-	2	-	-	-
WINGED EUONYMUS	-	-	-	3	-	-
Low Shrubs						
SALAL	19	32	-	8	-	-
MAHONIA REPENS	19	79	30	-	-	-
SWORD FERN	26	32	18	8	-	-
KELSEY DWARF DOGWOOD	-	47	-	25	-	-
DAYLILY	-	63	24	-	-	-
LAVENDER 'HIDCOTE'	-	-	12	13	-	-
LIME MOUND SPIREA	-	32	12	13	-	-
DAVIDS VIBURNUM	-	32	24	17	-	-
Other Items						
SOIL AMENDMENT - ACRES	0.008	0.039	0.019	0.021	-	0.047
TOPSOIL TYPE A - 6" DEPTH - CY	6	32	15	17	15	-
WET NATIVE SEEDING - SY	-	-	-	-	-	228
SEEDED LAWN - SY	-	-	-	-	89	-
WOOD CHIP MULCH - CY	3	16	8	8	-	-

	Planting Areas
Trees	Area SF
BIG LEAF M	APLE
DOUGLAS F	IR
WESTERN	RED CEDAR
WHITE WO	VDER DOGWOOD
JAPANESE R	LOWERING CHERF
EXCELSA C	EDAR
Shrubs	
VINE MAPLE	
WESTERN	SERVICEBERRY
TALL OREG	SON GRAPE
PACIFIC WA	XMYRTLE
MOCK ORA	NGE
PACIFIC NIN	IEBARK
RED FLOW	ERING CURRANT
NOOTKAR	OSE
SNOWBERF	RY
WINGED EL	JONYMUS
Low Shrubs	
SALAL	
MAHONIAR	EPENS
SWORD FE	RN
KELSEYDW	IARF DOGWOOD
DAYLILY	
LIME MOUN	
DAVIDS VIBI	JRNUM
Other Items	
	DMENT - ACRES
	YPE A - 6" DEPT H - C
	E SEEDING - SY
SEEDED LA	
WOOD CHI	PMULCH - CY

QUANTITY TAB -FOR SHEET LA10-	QUANTITYBYAREA								
Planting Areas 🔶	LS22	S17	S18	Shore	S19	LS23	WBA 29D	LAWN	WET SEED
Trees Area SF →	765	42	3334	500	3468	701	9518	475	3134
BIG LEAF MAPLE	-	-	4	2	4	-	13	-	-
SITKASPRUCE	-	-	-	-	-	-	7	-	-
SHORE PINE	-	-	-	-	-	-	13	-	-
BITTER CHERRY	-	-	4	-	4	-	13	-	-
DOUGLAS FIR	-	-	4	2	4	-	7	-	-
SCOULERS WILLOW	-	-	-	-	-	-	7	-	-
WESTERN RED CEDAR	-	-	4	2	4	-	7	-	-
WESTERN HEMLOCK	-		4		4		-	-	-
Shrubs									
VINE MAPLE	-	-	20	2	21	-	37	-	-
WEST ERN SERVICEBERRY	-	-	20	2	21		37	-	-
WESTERN HAZEL	-	-	-	-	-		19	-	-
OCEAN SPRAY	-		13	3	14		37		-
TALL OREGON GRAPE	-	-	20		21		-		-
OSO BERRY	-	-	20	2	21	-	37	-	-
MOCK ORANGE	-	-	-	3	-	-	37		-
PACIFIC NINEBARK	-	-	-	-	-	-	37	-	-
RED FLOWERING CURRANT	-	-	20	-	21		37	-	-
NOOTKAROSE	-	-	-	3	-	-	37	-	-
SNOWBERRY	-	-	20	3	21	-	56	-	-
Low Shrubs									
SALAL	14	-	-	-	-	52	-	-	-
MAHONIA REPENS	35	-	-	-	-	26	-	-	-
SWORD FERN	14	-	-	-	-	52	-	-	-
KELSEY DWARF DOGWOOD	14	8	-	-	-	-	-	-	-
DAYLILY	28	-	-	-	-	-	-	-	-
LIME MOUND SPIREA	28	-	-	-	-	-	-	-	-
DAVIDS VIBURNUM	7	-	-	-	-	-	-	-	-
Other Items									
MITIGATION CLEAR & GRUB - ACRE	-	-	-	0.011	-	-	0.219	-	-
SOIL AMENDMENT - ACRES	0.018	0.001	0.077	0.011	0.080	0.016	0.219	0.011	0.072
TOPSOIL TYPE A - 6" DEPTH - CY	14	1	62	-	64	13	-	9	-
WET NATIVE SEEDING - SY	-	-	-	-	-	-	-	-	348
SEEDED LAWN - SY	-	-	-	-	-	-	-	53	-
WOOD CHIP MULCH - CY	7	1	31	5	32	6	88	-	-
HABIT AT BRUSH PILE	-	-	-	-	-	-	2	-	-
HABITAT LOG	-	-		-	-	-	3	-	-
HABITAT ROCK PILE	-	-	-	-	-	-	1	-	-

CONFORMED DRAWINGS

18

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A G		Ng ¹ Y	
			hm
UV	10, 50 T	1200	¥
	CAPE	ARCH	
		- 6/14	·/21

Parametrix	PROJECT NAME
NGINEERING . PLANNING . ENVIRONMENTAL SCIENCES	EAST LAKE SAMMAMISH
	MASTER PLAN TRAIL
719 2ND AVENUE, SUITE 200 SEATTLE, WA 98104	SOUTH SAMMAMISH SEGMENT B - P
2 206.394.3700 WWW.PARAMETRIX.COM	SAMMAMISH, WA


Σ.	$ \land $	REVISIONS	DATE	BY	DESIGNED J. SWENSON	
v					DRAWN B. PURGANAN	ONE INCH AT FULL SCALE. IF NOT, SCALE ACCORDINGLY
ŝ					CHECKED	FILE NAME BL1521075P19T03LA-03
-					Y. HO	JOB No. 554-1521-075 P19 T03
Ś					APPROVED J. BAILEY	JUNE 2021


QUANTITYBYAREA								
313	S14	S15	LS21	S16	LAWN	WET SEED		
879	853	4909	308	244	468	1150		
-	-	8	-	-	-	-		
-	-	8	-	-	-	-		
-	-	8	-	-	-	-		
3	2	8	-	-	-	-		
1	-	-	-	2	-	-		
3	2	8	-	-	-	-		
6	-	16	-	-	-			
6	-	-	-	-	-	-		
9	2	25	-	-	-	-		
9	2	16	-	-	-	-		
-	-	16	-	-	-	-		
9	2	16	-	-	-	-		
9	2	16	-	-	-	-		
-	-	16	-	-	-	-		
13	2	25	-	4	-	-		
-	-	16	-	-	-	-		
10	17	14	6	3	-	-		
17	28	23	14	6	-	-		
14	22	18	14	5	-	-		
14	22	18	6	5	-	-		
-	22	18	-	5	-	-		
7	-	-	11	-	-	-		
7		-	6	-	-	-		
	0.000		0.00-	0.000	0.04	0.000		
).043 35	0.020	0.113 91	0.007	0.006	0.011	0.026		
					9	- 128		
-	-	-	-	-	- 52	- 128		
- 17	- 8	- 45	- 3	- 2	- 52	-		
17	0	40	3	2	-	-		

CITY OF SAMMAMISH	APPROVAL
City Engineer	Date
	SHEET NO. 152 OF 213

NL T B - PHASE 2

LANDSCAPE SCHEDULE

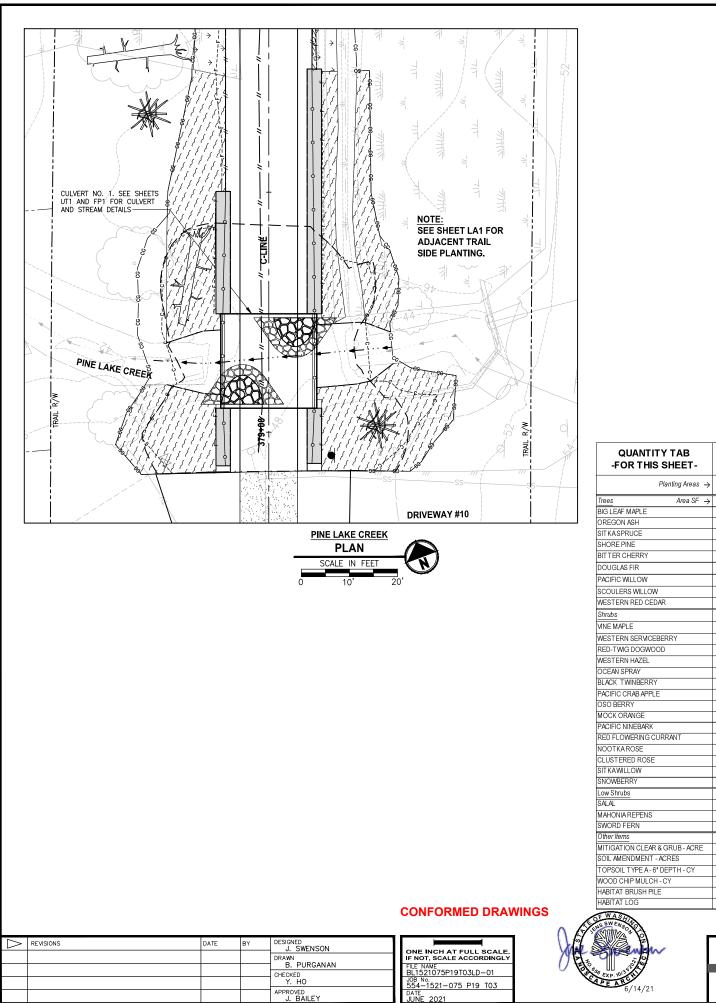

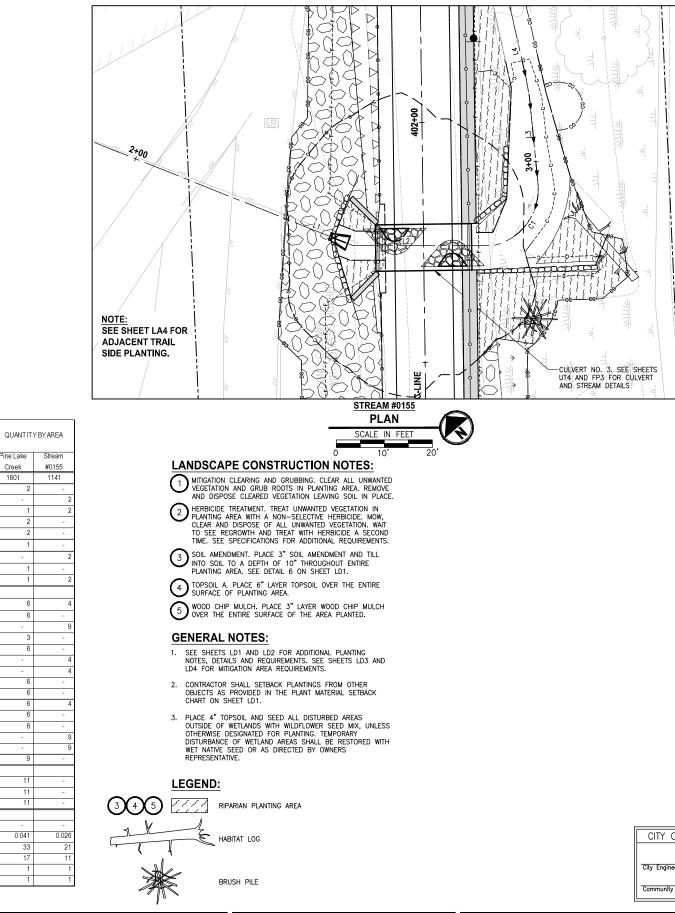

Stream

ne Lake

1801

Creek

1

0.041

33

Parametrix

719 2ND AVENUE, SUITE 200 | SEATTLE, WA 98104 P 206.394.3700 WWW.PARAMETRIX.COM

EAST LAKE SAMMAMISH MASTER PLAN TRAIL SOUTH SAMMAMISH SEGMENT B - PHASE 2


PROJECT NAM

SAMMAMISH, WA

CITY OF SAMMAMISH	APPROVAL
City Engineer Community Development	Date
	SHEET NO.
	153 OF 213

PLANTING DETAILS

LD1

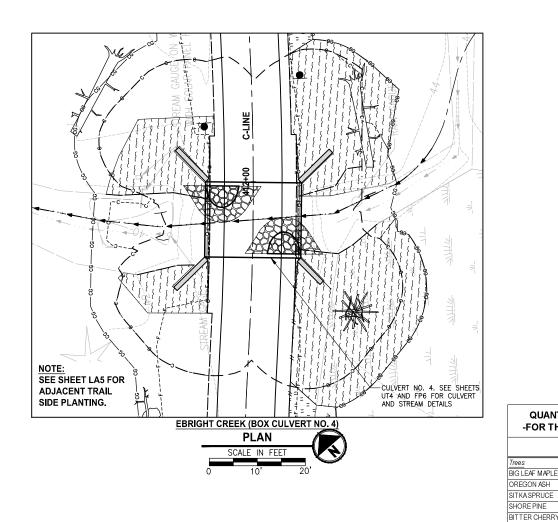

		CULVERT NO. 8. SEE SH UI4 AND FP9 FOR CULV AND STREAM DETAILS
		NOTE: SEE SHEE: ADJACENT SIDE PLAN
QUANTIT	YBYAREA	STREAM #0143L (BOX CULVERT NO. 8)
Ebright	Stream	PLAN
Creek	#0143L	SCALE IN FEET
0	0	0 10' 20'
100	-	
100	-	
40		
100	-	
100	-	
40	-	
6	-	
100	-	
40	-	
10	-	

С	O	NF	-0	R	NED	DR	AW	'IN(GS

Ϊ						
PAT	$ \land $	REVISIONS	DATE	BY	DESIGNED J. SWENSON	
					DRAWN	ONE INCH AT FULL SCALE IF NOT, SCALE ACCORDINGL
LD2					B. PURGANAN CHECKED	FILE NAME BL1521075P19T03LD-01
Ë					Ү. НО	JOB No. 554-1521-075 P19 T03
LAYC					APPROVED J. BAILEY	DATE JUNE 2021



MITIGATION CLEAR & GRUB - ACRE 20,000.000

QUANTITY TAB

-FOR THIS SHEET-

DOUGLAS FIR PACIFIC WILLOW SCOULERS WILLOW WESTERN RED CEDAR

OCEAN SPRAY BLACK TWINBERRY PACIFIC CRAB APPLE

OSO BERRY MOCK ORANGE PACIFIC NINEBAR RED FLOWERING CURRANT NOOTKAROSE CLUSTERED ROSE

SITKAWILLOW SNOWBERRY

Low Shrubs SALAL MAHONIAREPENS

SWORD FERN Other Items

SOIL AMENDMENT - ACRES

WOOD CHIP MULCH - CY

HABIT AT BRUSH PILE

HABIT AT LOG

TOPSOIL TYPE A- 6" DEPTH - CY

Shrubs VINE MAPLE WESTERN SERVICEBERRY RED-TWIG DOGWOOD WESTERN HAZEL

Planting Areas \rightarrow

Area SF \rightarrow

10

10

10

10

10

55

50


500

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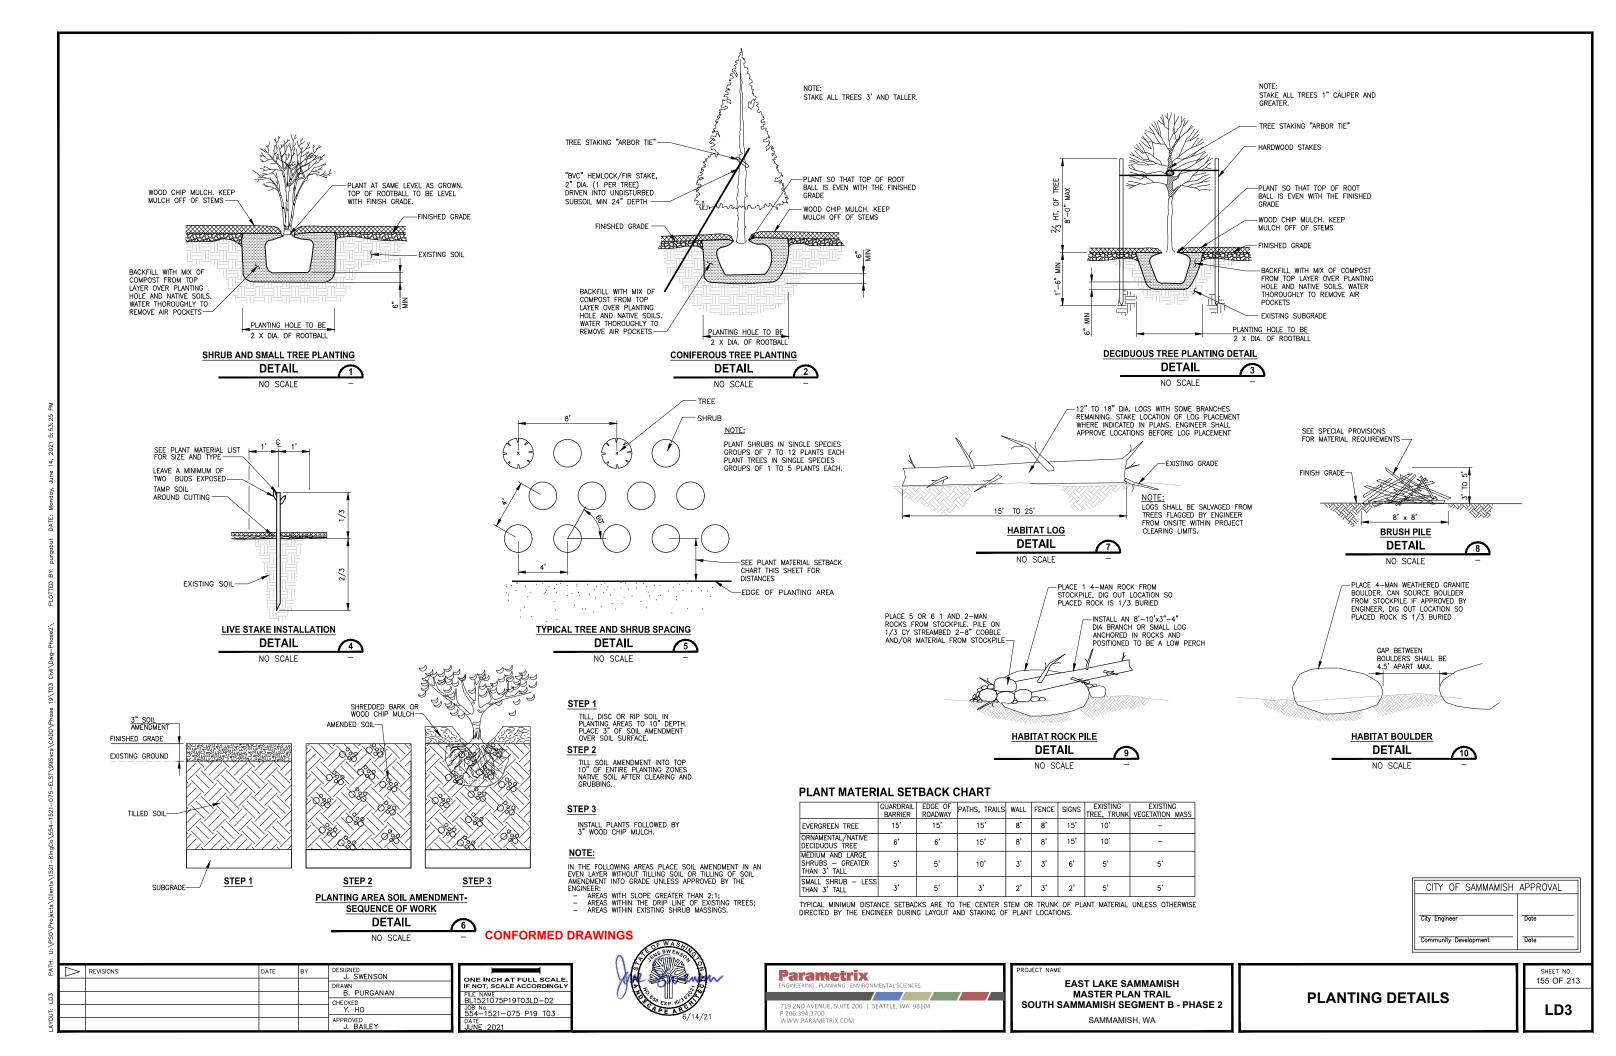
20,000.000



PROJECT NAM EAST LAKE SAMMAMISH MASTER PLAN TRAIL SOUTH SAMMAMISH SEGMENT B - PHASE 2 SAMMAMISH, WA

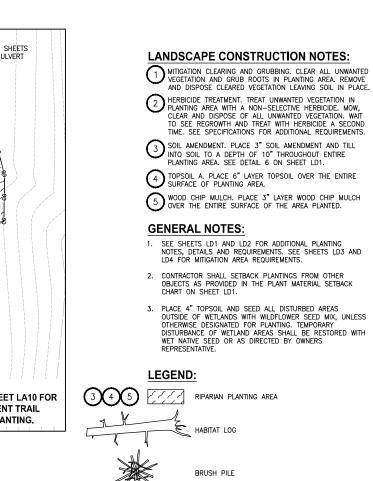

PLANTING SCH	EDULE	LD2
		SHEET NO. 154 OF 213
	Community Development	Date
	City Engineer	Date
	CITY OF SAMMAMISH	APPROVAL



PLANT MATERIAL LIST

QUANTITY	COMMON NAME	BOT ANICAL NAME	SIZE AND CONDITION	NOTES
	Trees			
121	ACER MACROPHYLLUM	BIG LEAF MAPLE	1" CALIPER, CONT. OR B&B	
39	CORNUS 'EDDIE'S WHITE WONDER'	WHITE WONDER DOGWOOD	1" CALIPER, CONT. OR B&B	1
36	FRAXINUS LAT IFOLIA	OREGON ASH	1" CALIPER, CONT. OR B&B	1
84	PICEA SIT CHENSIS	SITKASPRUCE	3'HT., CONT.	1
87	PINUS CONTORTA'CONTORTA'	SHORE PINE	3'HT., CONT.	1
97	PRUNUS EMARGINATA	BITTER CHERRY	1" CALIPER, CONT. OR B&B	
4	PRUNUS SERRULATA 'AMANOGAWA'	JAPANESE FLOWERING CHERRY	1 1/2 " CALIPER, CONT. OR B&B	SPACE TREES 8 TO 10-FEET MIN. ON
94	PSUEDOTUSGAMENZIESII	DOUGLAS FIR	3'HT., CONT.	CENTER
46	SALIX L. SSP. LASIANDRA	PACIFIC WILLOW	1/2"DIA. X 36" LIVESTAKE CUTTING	7
74	SALIX SCOULERIANA	SCOULERS WILLOW	1/2"DIA. X 36" LIVESTAKE CUTTING	1
125	T HUJA PLICAT A	WESTERN RED CEDAR	3'HT., CONT.	1
44	THUJA PLICATA 'EXCELSA'	EXCELSA CEDAR	6'HT., CONT.	1
25	T SUGA HET EROPHYLLA	WESTERN HEMLOCK	3'HT., CONT.	1
	Shrubs			
407	ACER CIRCINAT UM	VINE MAPLE	12" HT., #1 CONT.	
311	AMELANCHIER ALNIFOLIA	WESTERN SERVICEBERRY	12" HT ., #1 CONT.	1
130	CORNUS SERICEA	RED-TWIG DOGWOOD	1/2"DIA. X 36" LIVESTAKE CUTTING	1
95	CORYLUS CORNUTA	WESTERN HAZEL	12" HT ., #1 CONT.	1
21	EUONYMUS ALATUS 'COMPACTUS'	WINGED EUONYMUS	18" HT ., #2 CONT.	1
275	HOLODISCUS DISCOLOR	OCEAN SPRAY	12" HT ., #1 CONT.	1
73	LONICERA INVOLUCRATA	BLACK TWINBERRY	12" HT ., #1 CONT.	1
192	MAHONIA AQUIFOLIUM	TALL OREGON GRAPE	12" HT ., #1 CONT.	1
73	MALUS FUSCA	PACIFIC CRAB APPLE	12" HT ., #1 CONT.	
56	MYRICA CALIFORNICA	PACIFIC WAX MYRTLE	12" HT ., #1 CONT.	SPACE SHRUBS 4 TO 6-FEET ON CENTER
242	OEMLARIA CERASIFORMIS	OSO BERRY	12" HT ., #1 CONT.	
274	PHILADELPHUS LEWISII	MOCK ORANGE	12" HT ., #1 CONT.	1
333	PHYSOCARPUS CAPITATUS	PACIFIC NINEBARK	12" HT., #1 CONT.	1
403	RIBES SANGUINEUM	RED FLOWERING CURRANT	12" HT ., #1 CONT.	1
240	ROSANUTKANA	NOOTKAROSE	12" HT ., #1 CONT.	1
	ROSA PISOCARPA	CLUSTERED ROSE	12" HT.,#1 CONT.	1
	SALIX SIT CHENSIS	SITKAWILLOW	1/2"DIA. X 36" LIVESTAKE CUTTING	1
	SYMPHORICARPOS ALBUS	SNOWBERRY	12" HT., #1 CONT.	1
	THUJA OCCIDENT ALIS 'SMARAGD'	EMERALD GREEN ARBORVIT AE	6' HT ., CONT . OR B&B	
	Low shrubs			
1007	CORNUS SERICEA 'KELSEYI'	KELSEY DWARF DOGWOOD	#2 CONT.	
	GAULT HERIA SHALLON	SALAL	#1 CONT.	1
	HEMEROCALLIS 'ST ELLA DE ORO'	DAYLILY	#1 CONT.	1
	LAVANDULA ANGUSTIFOLIA 'HIDCOTE'	LAVENDER 'HIDCOTE'	#2 CONT.	SPACE PLANTS 3-FEET ON CENTER
	MAHONIA REPENS	CREEPING OREGON GRAPE	#1 CONT.	1
	POLYSTICHUM MUNITUM	SWORD FERN	#1 CONT.	1
2000	SPIRAEA BUMALDA 'LIMEMOUND'	LIME MOUND SPIREA	#2 CONT.	1
	MBURNUM DAVIDII	DAVIDS VIBURNUM	#2 CONT.	SPACE PLANTS 4-FEET ON CENTER

PLANTING NOTES:

- CONTRACTOR SHALL ARRANGE TO MEET ON SITE WITH PROJECT REPRESENTATIVE TO DISCUSS LIMITS OF WORK AND METHODS. CONSTRUCTION ACTIVITIES SHALL NOT COMMENCE UNTIL ACCESS, LIMITS OF WORK, AND METHODS ARE APPROVED.
- 2. MITIGATION WORK ELEMENTS INCLUDING MITIGATION CLEARING & GRUBBING, HERBICIDE TREATMENT, SOIL AMENDMENT, WOOD CHIP MULCH, HABITAT FEATURES AND PLANTING LOCATIONS SHALL BE LOCATED IN AREAS CLEARED OF UNWANTED VEGETATION AND OPEN AREAS WITHOUT NATIVE VEGETATIVE COVER WITHIN THE MITIGATION AREA.
- MITIGATION AREA BOUNDARY LIMITS SHALL BE STAKED FOR APPROVAL PROJECT REPRESENTATIVE. ELECTRONIC FILES FOR LIMITS SHALL BE PROVIDED UPON AWARD OF CONTRACT.
- 4. PLANTING PLANS REPRESENT A CONCEPTUAL PLANT LAYOUT, FINAL PLANT LOCATIONS SHALL BE APPROVED BY PROJECT REPRESENTATIVE PRIOR TO PLANTING.
- 5. USE ONLY HAND TOOLS TO CLEAR AND CULTIVATE SOIL UNDER THE CANOPY (WITHIN AND 5' OUTSIDE THE DRIPLINE) OF EXISTING TREES.
- ALL PLANTS SHALL BE NURSERY GROWN A MINIMUM OF ONE YEAR. PLANT MATERIAL IS TO BE SUPPLIED BY COMMERCIAL NURSERIES THAT SPECIALIZE IN PLANTS NATIVE TO THE PACIFIC NORTHWEST. PLANT SUBSTITUTIONS ARE SUBJECT TO APPROVAL BY PROJECT REPRESENTATIVE.
- 7. MITIGATION PLANTING SHALL TAKE PLACE DURING THE DORMANT SEASON (OCTOBER 1ST TO MARCH 15T). PLANTING MAY BE ALLOWED AT OTHER TIMES AFTER REVIEW AND WRITTEN APPROVAL BY PROJECT REPRESENTATIVE.
- 8. THE CONTRACTOR SHALL BE RESPONSIBLE FOR DISPOSING OF ALL DEBRIS AND EXCESS SOIL OCCASIONED BY THIS PROJECT.
- 9. CONTRACTOR SHALL VERIFY THE LOCATION OF ALL UTILITIES PRIOR TO EXCAVATION.
- 10. CONTRACTOR SHALL SETBACK PLANTINGS FROM OTHER OBJECTS AS PROVIDED IN THE PLANT MATERIAL SETBACK CHART THIS SHEET.
- 11. ALL DIMENSIONS FOR LISTED HEIGHT, LENGTH AND CONTAINER SIZE ARE MINIMUM REQUIREMENTS.
- 12. EXISTING AREAS DISTURBED BY CONSTRUCTION ACTIVITIES AND NOT SHOWN TO BE RE-VEGETATED ON THESE PLANS SHALL BE RESTORED AND SEEDED.
- 13. DISCREPANCIES BETWEEN THE PLANS AND SITE CONDITIONS SHALL BE BROUGHT TO THE ATTENTION OF THE PROJECT REPRESENTATIVE PRIOR TO PROCEEDING WIT EFFECTED WORK.
- 14. SEE TE SHEETS FOR TEMPORARY EROSION CONTROL MEASURES.
- 15. AFTER COMPLETION OF INITIAL PLANTING SPRAY MITIGATION AREA TREES AND SHRUBS ONLY WITH AN HERBIVORE REPELLENT TREATMENT.
- 16. CONTRACTOR SHALL BE RESPONSIBLE FOR WATERING PLANTS FOR THE FIRST YEAR AFTER ACCEPTANCE OF COMPLETION OF PLANTING FOR THE PROJECT. COUNTY WILL MAKE PROVISIONS FOR WATERING AS NEEDED FOR THE REMAINDER OF THE ESTABLISHMENT PERIOD AFTER THE FIRST YEAR.

CONFORMED DRAWINGS



/14/21



PROJECT NAM EAST LAKE SAMMAMISH MASTER PLAN TRAIL SOUTH SAMMAMISH SEGMENT B - PHASE 2 SAMMAMISH, WA

\bigtriangledown	REVISIONS	DATE	BY	DESIGNED J. SWENSON	
				DRAWN	ONE INCH AT FULL SCALE. IF NOT, SCALE ACCORDINGLY
				B. PURGANAN CHECKED	FILE NAME BL1521075P19T03LD-02
				Y. HO	JOB No. 554-1521-075 P19 T03
				APPROVED J. BAILEY	DATE JUNE 2021

PLANTING SCHEDULE

SHEET 156 OF 213

LD4

-		

Community Development

City Engineer

CITY OF SAMMAMISH APPROVAL

Date

Date

Mitigation Goals, Objectives, and Performance Standards

The overall goal of the mitigation effort is to replace the habitats and functions lost as a result of the project. The proposed mitigation will accomplish this by enhancing 0.65 acre of wetland, increasing the buffer of 8 wetlands by 1.53 acres, enhancing 0.75 acre of wetland buffer, enhancing 0.24 acre of stream buffer, replacing 8 fish barrier culverts on 6 Type F streams with pipes that are fish passable, and enhancing 0.09 acre of shoreline setback. In addition, mitigation for 0.22 acre of permanent wetland impacts will occur at an off-site approved mitigation bank, and thus, this mitigation will not be carried forward in the following sections. Specific goals and objectives formulated to achieve this result are presented below.

Mitigation Goals

The mitigation goals are:

- Enhance 0.65 acre of wetland.
- Increase and enhance the buffer of 8 wetlands by 1.53 acres.
- Enhance 0.75 acre of wetland buffer.
- Enhance 0.24 acre of stream buffer.
- Replace 8 fish barrier culverts on 6 Type F streams with fish passable culverts.
- Enhance 0.09 acre of shoreline setback.

Achievement of these goals is expected to provide the following improvements to wetland, stream, wetland buffer, stream buffer, and shoreline setback functions:

- Provide additional fish habitat by removing fish barriers, increasing open stream channel, and opening up available upstream habitat.
- Increase the production of organic matter by planting trees and shrubs in the created/restored wetland, enhanced wetland, increased wetland buffer, enhanced wetland buffer, enhanced stream buffer, and enhanced shoreline setback.
- Increase fish and wildlife habitat and improve biological diversity by planting with a variety of native wetland and buffer plant species and installing habitat features (habitat logs and brush piles).

Mitigation Objectives and Performance Standards

Wetlands

Objective 1: Enhance by planting native species a minimum of 0.65-acre forested and scrubshrub wetland at the enhanced wetland areas.

Performance Standards:

- Year 1 Survival of planted woody species in enhanced wetland areas will be at least 80 percent.
- Record percent cover of native woody species in enhanced wetland area to Year 2 establish a baseline for areal cover.

- Year 3 Native woody species will achieve a minimum of 25 percent areal cover, including desirable native volunteers, in the enhanced wetland areas.
- Native woody species will achieve a minimum of 50 percent areal cover, Year 5 including desirable native volunteers, in the enhanced wetland areas.
- Native woody species will achieve a minimum of 70 percent areal cover in Year 7 the enhanced wetland areas.
- Native woody species will achieve a minimum of 80 percent areal cover in Year 10 the enhanced wetland area.

Streams

Instream Habitat

Objective 2: Replace existing fish barrier culvert at the (six) trail crossings on Pine Lake Creek, Stream 0155, Ebright Creek, Zackuse Creek, George Davis Creek, Stream 0143L, and (two) downstream road crossings on Pine Lake Creek and Zackuse Creek with fish passage culvert to open up available upstream habitat.

Performance Standards:

Year 1, 2, 3, and 5 Constructed habitat elements including the new fish passable culverts, regraded channels, and streambed material will remain in place as constructed at all 8 culvert replacement sites.

Wetland and Stream Buffers Areas

Objective 3: Establish a minimum of 2.28-acre forested and scrub-shrub wetland buffer, and 0.24-acre forested stream buffer at the increased/enhanced wetland buffer and enhanced stream buffer areas.

Performance Standards:

- Year 1 Survival of planted woody species in increased/enhanced wetland buffer and enhanced stream buffer areas will be at least 80 percent.
- Year 2 Record percent cover of native woody species in increased/enhanced wetland buffer and enhanced stream buffer areas to establish a baseline for areal cover.
- Native woody species will achieve a minimum of 25 percent areal cover in Year 3 the increased/enhanced wetland buffer and enhanced stream buffer areas.
- Year 5 Native woody species will achieve a minimum of 50 percent areal cover in the increased/enhanced wetland buffer and enhanced stream buffer setback areas.
- Native woody species will achieve a minimum of 70 percent areal cover in Year 7 the increased/enhanced wetland buffer and enhanced stream buffer areas.
- Native woody species will achieve a minimum of 80 percent areal cover in Year 10 the increased/enhanced wetland buffer and enhanced stream buffer areas.

CONFORMED DRAWINGS





ROJECT NAMI EAST LAKE SAMMAMISH MASTER PLAN TRAIL SOUTH SAMMAMISH SEGMENT B - PHASE 2 SAMMAMISH, WA

$ \land$	REVISIONS	DATE	BY	DESIGNED J. SWENSON		
				DRAWN	ONE INCH AT FULL SCALE. IF NOT, SCALE ACCORDINGLY	
				B. PURGANAN CHECKED	FILE NAME BL1521075P19T03LD-02	
				Ү. НО	JOB No. 554-1521-075 P19 T03	
				APPROVED J. BAILEY	DATE JUNE 2021	

Shoreline Setback Areas

Objective 3: Establish a minimum of 0.09-acre forested habitat at the shoreline setback areas.

Performance Standards:

Year 1	Survival of planted woody species in enhanced shoreline setback areas will be at least 80 percent.
Year 2	Record percent cover of native woody species in enhanced shoreline setback areas to establish a baseline for areal cover.
Year 3	Native woody species will achieve a minimum of 25 percent areal cover in enhanced shoreline setback areas.
Year 5	Native woody species will achieve a minimum of 50 percent areal cover in enhanced shoreline setback areas.
Year 7	Native woody species will achieve a minimum of 70 percent areal cover in enhanced shoreline setback areas.
Year 10	Native woody species will achieve a minimum of 80 percent areal cover in enhanced shoreline setback areas.

Invasive Species

Objective 4: Limit invasive non-native species throughout the mitigation site planting areas.
Performance Standards:

Y	'ear 1, 2, 3, 5, 7, and 10	Himalayan blackberry, cutleaf blackberry, Scotch broom, English ivy, reed canarygrass, and hedge false bindweed will not exceed
		20 percent areal cover in all planting areas.
Y	′ear 3	100 percent removal of Japanese knotweed by Year 3 in the Wetland 22CD buffer enhancement area.

Wildlife Habitat

Objective 5: Provide wildlife habitat.

Performance Standards:

Year 1, 2, 3, 5, 7, and 10	Increase in areal cover of native woody species in all mitigation areas, as measured in Objectives 1, 2, and 3, to be used as a surrogate to indicate increasing habitat functions.
Year 1, 3, 5, 7, and 10	Increase in species richness of native species over preexisting conditions in all mitigation areas, as measured in Objectives 1, 2, and 3, to be used as a surrogate to indicate increased habitat functions.
Year 1, 2, 3, 5, 7, and 10	Installed habitat features are present and functional.

Anthropogenic Disturbance

Objective 6: Protect the mitigation sites from anthropogenic disturbance.

MITIGATION NOTES		LD5
		SHEET NO. 157 OF 213
	City Engineer Community Development	Date
	CITY OF SAMMAMISH	APPROVAL

Performance Standards:

Conduct qualitative monitoring to assess the status of the sites Year 1 through 10 yearly during the 10-year monitoring period to monitor for human disturbance, including but not limited to filling, trash, and vandalism

Year 1 through 10 Install and maintain fences and appropriate signs along the trail adjacent to each site to identify their protected status.

Record Drawings

Record drawings and/or a report documenting the as-built or installed conditions will be prepared after construction and plantings are complete. The report will include the following components: (1) drawings that clearly identify the boundaries of the mitigation areas; (2) locations of the sampling and monitoring sites (including photo-point locations); (3) locations of hydrology monitoring stations; (4) photographs of the mitigation sites: and (5) an analysis of any changes to the mitigation plan that occurred during construction. A copy of the as-built report will be sent to the City and USACE within 60 days of completion of construction and planting.

Monitoring

The mitigation areas will be monitored during and after construction. During construction, monitoring will ensure that the BMPs are observed to minimize impacts, and the on-site construction work (including grading and planting) will be coordinated to ensure that the sites are constructed as designed.

After construction is completed, long-term monitoring will be performed annually to ensure that the goals and objectives of the mitigation are being met. Monitoring of the mitigation areas will be performed over a 10-year period by a qualified professional (SMC 21A.50.145; 21A.50.300). A combination of quantitative and qualitative monitoring activities will be used to assess the management objectives and associated performance standards described in the mitigation plan. Activities will include site visits to monitor unnatural site disturbance, photographs to document site development, and data collection for the quantitative evaluation of performance standards. The results of the monitoring will be submitted to the permitting agencies.

Appropriate contingency measures will be developed, as needed, by a qualified professional to ensure that the sites develop healthy vegetation that meets the obligations described in this mitigation plan and the associated permits.

Quantitative Monitoring

The following bulleted items describe the methods to be used for the quantitative monitoring, monitoring schedule, and report deadlines.

• The planting sites will be assessed by an appropriate quantitative vegetative field assessment methodology. The line intercept method will be used for determining percent areal cover for woody and invasive species. Plant richness will be determined by a count of native tree and shrub species.

J. SWENSON

B. PURGANAN

CHECKED Y. HO

J. BAILEY

• Quantitative vegetation assessments will follow the same method in each consecutive monitoring year

- Quantitative vegetation assessments will be performed between June 15 and September 15 of each monitoring year
- Monitoring reports will be sent to agencies requiring monitoring reports by February 15 of the following year.
- Permanent photographic stations will be established to monitor the development of the sites. Photographs will be taken along transect lines and from vantage points that capture the general mitigation area. All photographs will be labeled to identify locations.

Qualitative Monitoring

Qualitative monitoring will be conducted as follows:

- A qualified professional will qualitatively assess the constructed habitat elements including the new fish passable culverts, regraded channels, and streambed material for the first 3 years.
- Qualitative assessment will be performed yearly to visually assess the health of plants and identify areas that may need control of non-native invasive species or other maintenance activities.
- During all qualitative monitoring years, photographic documentation of the sites will occur from permanent photograph stations.

Maintenance

The proposed mitigation is intended to achieve the performance standards with minimal ongoing maintenance. However, King County will manage and maintain the site for 10 years, or until all performance standards are met and the site is closed with the approval of permitting agencies.

As mentioned previously, King County Parks has a formal maintenance program for its trail mitigation projects. The County understands that regular maintenance is necessary to achieve its mitigation commitments in public trail corridors.

Planted vegetation species are adapted to varying site conditions in the Puget Sound lowland, although supplemental irrigation may be needed during the first two growing seasons after installation to ensure the long-term survival of the plants. The need for irrigation will be evaluated based on the conditions observed during the establishment period.

To ensure rapid establishment of the plant community, trees and shrubs will be planted closer together than would generally occur in natural mature stands. Some natural mortality is expected to occur during the monitoring period. All dead and downed woody material will be left in place to provide microhabitats for wildlife. Plants will be replaced as needed to meet performance standards.

Maintenance to control nuisance species in the mitigation areas will likely be necessary. During the monitoring period, if it becomes evident that invasive species are impeding establishment of desirable native plants, measures will be implemented to control nuisance species. A progressively aggressive approach will be used to control nuisance species. Control measures will first include hand cutting and/or grubbing and removal; if this fails, an environmentally sensitive herbicide (e.g., Rodeo or equivalent) may be applied.

Contingency Measures

Performance Security/Financial Assurance

Site Protection

The County owns the property underlying the mitigation sites. They will protect the mitigation sites in perpetuity through a legal mechanism that permits maintenance and monitoring of the mitigation area. This mechanism shall be retained by the County and may be submitted to the USACE after permit issuance, if required. In addition, permanent fencing and/or signs indicating that the area is a natural or sensitive or critical area to be protected from disturbance will be posted along the boundaries of each mitigation area.

Less than 8 Year 1

> Percent co Years 3, 5,

Invasive sp Performan

Monitoring reports or technical memoranda will document annual management activities and identify key issues and actions needed for the following year. Reports are anticipated to be submitted every year to the USACE, by the end of the calendar year, for the first 10 years following attainment of performance standards.

CONFORMED DRAWINGS



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554-1521-075 P19 T03

FILE NAME



DRAWINGS		
Sultr-	Parametrix Engineering , planning , environmental sciences	PROJECT N
6/14/21	719 2ND AVENUE, SUITE 200 SEATTLE, WA 98104 P 206.394.3700	SOUTH

NNING . ENVIRONMENTAL SCIENCES	EAS
E, SUITE 200 SEATTLE, WA 98104	MA SOUTH SAMM
RIX.COM	

REVISIONS

Adaptive management is driven by the monitoring results and the performance standards. If the performance standards are not met, adaptive management activities will be implemented to achieve the desired condition. Management activities may include implementation of contingencies described in Table 5-5, or other appropriate measures. Site conditions will be evaluated to determine the cause of the problem and the most appropriate countermeasure.

Information from the annual monitoring program will be used to identify any maintenance and/or corrective actions. If problems are identified in monitoring, King County biologists will determine the cause of the problem and implement proper maintenance or corrective activities. These activities will be discussed in the annual monitoring report.

This mitigation project will be sponsored by King County. The County will implement a suitable mechanism to ensure that the project is implemented successfully and monitored for a minimum of 10 years, or until the project mitigation is deemed a success by achieving its performance standards.

Table 5-5. Contingency Measures for the Mitigation Sites

Problem	Contingency Measure		
80% of planted woody species survive in	King County biologists (or other qualified biologist) will assess the sites to determine what conditions are preventing the plants from thriving. Appropriate measures will be taken to correct any conditions that are limiting growth. Plants will be replaced with appropriate native species to achieve the Year 1 standard. Additional measures (such as providing additional protection) will be considered if necessary.		
over for woody species not met during or 7	King County biologists (or other qualified biologist) will assess the sites to determine what conditions are preventing the plants from thriving. Appropriate measures, such as increased weed control or extra plantings, will be taken to correct any conditions that are limiting growth.		
pecies exceed percent cover threshold	Implement/revise invasive species control plan.		
nce standards not met at Year 10	Continue the monitoring regime for 1 additional year. The sites will continue to be evaluated every year until each site has met the stated performance standards associated with management objectives. Other contingency measures may be implemented during this period.		

Long-term Management Plan


The mitigation sites are located on King County property. After attainment of performance standards and acceptance of the mitigation project by the USACE, the County will implement a long-term management plan for the sites as part of trail operations, if required.

Site management activities will include noxious weed control, damage repair from vandalism, trash removal, and signage maintenance.

The County will issue a letter of assurance to cover long-term management costs of the mitigation site to the USACE ensuring the County's compliance with the long-term management plan.

MITIGATION NOTE:	S LD6
	SHEET NO. 158 OF 213
City En Commu	gineer Date nity Development Date
CITY	OF SAMMAMISH APPROVAL

King County Parks and Recreation Schedule B: Inglewood Hill Road Parking Lot - Phase 1 Sammamish, Washington

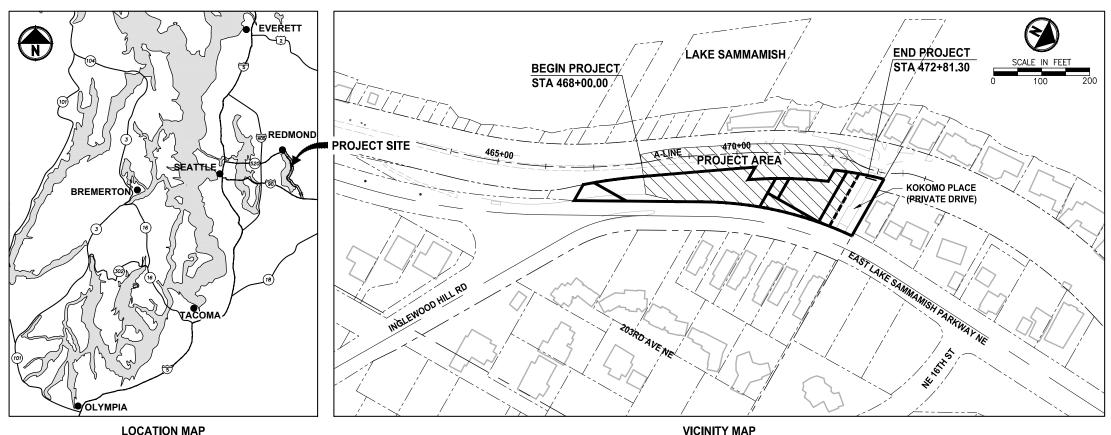

LOCATION MAP NOT TO SCALE

EXISTING ZONE CLASSIFICATION:

LOW DENSITY, URBAN RESIDENTIAL R-4

EXISTING SHORELINE ENVIRONMENT DESIGNATION:

CITY OF SAMMAMISH DESIGNATION: SHORELINE RESIDENTIAL

GENERAL PURPOSE OF THIS PROJECT:

TO CONSTRUCT PARKING AND ACCESS FOR THE EAST LAKE SAMMAMISH TRAIL

PROPERTY INFORMATION:

PARCEL NUMBERS (STAGING AND ACCESS ONLY): 357530-0260-08 (29,285 SQ. FT.) 357530-0340-02 (9,671 SQ. FT.) 357530-0365-02 (1,920 SQ. FT.) 357530-0370-05 (1,669 SQ. FT.)

357530-0460-06 (2,304 SQ. FT.) 292506-9007 (484,668 SQ. FT.)

PHASE 1 CONSTRUCTION IMPROVEMENTS WILL BE MADE ENTIRELY WITHIN THE KING COUNTY TRAIL CORR AND WILL NOT EXTEND BEYOND.

PROJECT & SITE INFORMATION:

KING COUNTY PROPOSES TO DEVELOP 481 FEET OF THE NULTI-USE TRAIL IN THE CITY OF SAMMANISH, LOCATED NORTH OF INGLEWOOD HILL ROAD. A GRAVEL PARKING LOT AND INTERIM TRAIL ARE CURRENTLY IN OPERATION.

PHASE 1 IMPACTS: DISTURBED AREA = 18,000 SF (0.42 AC) EXISTING IMPERVIOUS AREA = 16,236 SF (0.37 AC) PROPOSED NEW/REPLACED IMPERVIOUS AREA = 7,700 SF (0.18 AC) VOLUME OF ESTIMATED FILL = 1,400 CY VOLUME OF ESTIMATED EXCAVATION = 1.100 CY

WRITTEN DESCRIPTION OF PHASE 1:

480 FEFT OF THE EXISTING GRAVEL TRAIL WILL BE WIDENED TO 12 FEET PAVED SURFACE WITH 2-FOOT GRAVEL SHOULDERS ON BOTH SIDES.

THE PROPOSED IMPROVEMENTS INCLUDE A RETAINING WALL, PAVING, DRAINAGE IMPROVEMENTS, FENCE, AND SIGNAGE.

CONTACT INFORMATION:

APPLICANT: KING COUNTY PARKS AND RECREATION DIVISION 201 S. JACKSON, 7TH FLR SEATTLE, WA 98104 (206) 477-4552 CONTACT: GINA AULD

OWNER: KING COUNTY PARKS AND RECREATION DIVISION


UTILITY ONE-CALL 1 (800) 424-5555

SAMMAMISH PLATEAU WATER AND SEWER DISTRICT (425) 392-6256 CONTACT: KYLE WONG

COMCAST CABLE (425) 867-7433 CONTACT: DAVID BURROWS PUGET SOUND ENERGY: CONSTRUCTION SERVICES 1-888-321-7779

ENGINEER: PARAMETRIX 719 2ND AVENUE SUITE 200 SEATTLE. WA 98104 (206) 394–3700 CONTACT: DON PROCTOR, P.E.

SURVEYOR PARAMETRIX 700 NE MULTNOMAH SUITE 1000 PORTLAND, OR 97232 (503) 416-6069 CONTACT: SKYE THOMAS, PLS

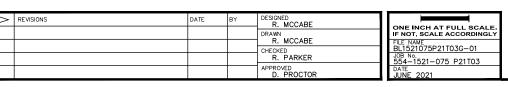



Parametrix 719 2ND AVENUE, SUITE 200 | SEATTLE, WA 98104 > 206.394.3700 //WW.PARAMETRIX.COM

ROJECT NAME KING COUNTY PARKS AND RECREATION INGLEWOOD HILL ROAD **PARKING LOT - PHASE 1** SAMMAMISH WA

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160	G2	ABBREVIATIONS AND LEGAL DESCRIPTIONS		
161	G3	GENERAL SYMBOL AND LINETYPE LEGEND		
162	G4	SURVEY CONTROL, ALIGNMENT AND ACCESS PLAN		
163	G5	CONSTRUCTION ACCESS		
164	SP1	EROSION CONTROL AND SITE PREPARATION PLAN		
165	TD1	EROSION CONTROL DETAILS		
166	TD2	EROSION CONTROL DETAILS		
167	CS1	TYPICAL TRAIL SECTIONS		
168	AL1	SITE IMPROVEMENTS PLAN		
169	GR1	GRADING PLAN & PROFILE		
170	XS1	GRADING SECTIONS		
171	WP1	WALL 1 PLAN & PROFILE		
172	WP2	WALL 2 PLAN & PROFILE		
173	DR1	DRAINAGE PLAN		
174	SD1	DRAINAGE PROFILES		
175	LA1	LANDSCAPE PLAN		
176	LD1	PLANTING SCHEDULE AND DETAILS		
177	GN1	CITY OF SAMMAMISH STANDARD NOTES		
178	GN2	CITY OF SAMMAMISH STANDARD NOTES		
179	MD1	DETAILS		
180	MD2	DETAILS		
181	MD3	DETAILS		
182	MD4	DETAILS		

CG2018-06067 SSDP 2016-00415

	CITY OF SAMMAMISH	APPROVAL
	City Engineer	Date
SAMMAMISH PUBLIC WORKS	Community Development	Date
EVELOPMENT REVIEW have been reviewed for compliance mamish Clearing and Grading and irements and also in accordance with is as established in the Settlement een King County vs. City of C17-0921 JCC and King County vs. ish No. 17-2-29922-7 SEA and have CCEPTABLE. The reviewer accepts no any errors and/or omissions made by hese drawings. 17 February 2022	CITY OF SAMMAMI	SH STAMPS

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City of Samman

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een deemed AC responsibility for the preparer of th

COVER SHEET

SHEET N 159 OF 213

G1

ABBREVIATIONS:

	VIATIONS.			LEGAL DESCRIPTIONS (NO IMPROVEMENTS WILL BE MADE TO THESE PARCELS).
AC	ACRE	PCC	POINT OF COMPOUND CURVATURE	PARCEL No. 357530-0260-08 PER STEWART TITLE GUARANTY COMPANY,
ACP	ASPHALT CONCRETE PAVEMENT	P/L	PROPERTY LINE	GUARANTEE No. G-6329-000007871, JANUARY 8, 2016
AP	ANGLE POINT	PP	POWER POLE	THOSE PORTIONS OF LOTS 1 THROUGH 10, 18 THROUGH 21 AND 23 THROUGH 27, BLOCK 6, INGLEWOOD, ACCORDING TO THE PLAT THEREOF RECORDED IN VOLUME 3 WESTERLY OF THE WESTERLY MARGIN OF EAST LAKE SAMMAMISH PARKWAY N. E. (ISSAQUAH-REDMOND ROAD REVISION NO. 2);
BC	BOTTOM OF CURB	PRC	POINT OF REVERSE CURVATURE	EXCEPT THAT PORTION LYING WESTERLY OF THE EASTERLY MARGIN OF THE NORTHERN PACIFIC RAILROAD RIGHT OF WAY AS CONVEYED BY DEED RECORDED UNDER RECO AND EXCEPT THOSE PORTIONS CONVEYED TO KING COUNTY FOR ROAD PURPOSES BY DEEDS RECORDED UNDER RECORDING NUMBERS 625790, 983353, 983354 AND 90
BIGD	BELOW INLET GRATE DEVICE	PROP	PROPOSED	AND EXCEPT THAT PORTION CONDEMNED FOR ROAD PURPOSES IN KING COUNTY SUPERIOR COURT CAUSE NO. 106364; AND EXCEPT THOSE PORTIONS RESERVED FOR ROAD BY KING COUNTY IN DEEDS RECORDED UNDER RECORDING NUMBERS 860989 AND 2957937;
BOC	BACK OF CURB	PT	POINT OF TANGENT	AND TOGETHER WITH THOSE PORTIONS OF VACATED DEPOT STREET ADJOINING, VACATED BY KING COUNTY SUPERIOR COURT CAUSE NUMBER 94-2-14451-1, AS WOULD
BOW, BW	BOTTOM OF WALL	PUD	PUBLIC UTILITY DISTRICT	<u>PARCEL No. 357530–0340–02</u> PER STEWART TITLE GUARANTY COMPANY,
BVCE	BEGIN VERTICAL CURVE ELEVATION	PVI	POINT OF VERTICAL INTERSECTION	GUARANTEE No. G-6329-000007868, JANUARY 8, 2016
BVCS	BEGIN VERTICAL CURVE STATION	R	RADIUS	THAT PORTION OF LOT 17, BLOCK 6, INGLEWOOD, ACCORDING TO THE PLAT THEREOF RECORDED IN VOLUME 3 OF PLATS, PAGE 169, RECORDS OF KING COUNTY, WASH PARKWAY N. E. (ISSAQUAH-REDMOND ROAD REVISION NO. 2);
СВ	CATCH BASIN	REINF	REINFORCED	EXCEPT THAT PORTION RESERVED FOR ROAD BY KING COUNTY IN DEED RECORDED UNDER RECORDING NUMBER 2957937; AND TOGETHER WITH THOSE PORTIONS OF VACATED ASH STREET (N. E. 16TH STREET) AND VACATED DEPOT STREET ADJOINING, VACATED BYKING COUNTY SUPERIOR COU
CG, C&G	CURB AND GUTTER	ROW, R/W	RIGHT-OF-WAY	
C/L, CL	CENTERLINE	RR	RAIL ROAD	PARCEL No. 357530-0365-02 PER STEWART TITLE GUARANTY COMPANY.
CLF	CHAIN LINK FENCE	RT	RIGHT	GUARANTEE No. G-6329-000007869, JANUARY 8, 2016
СМР	CORRUGATED METAL PIPE	SD	STORM DRAIN	THAT PORTION OF LOT 22, BLOCK 6, INGLEWOOD, ACCORDING TO THE PLAT THEREOF RECORDED IN VOLUME 3 OF PLATS, PAGE 169, RECORDS OF KING COUNTY, WASH RAILROAD COMPANY RIGHT OF WAY. AS CONVEYED BY DEED RECORDED UNDER RECORDING NUMBER 3051111.
CONC	CONCRETE	SDMH	STORMWATER MANHOLE	PARCEL No. 357530-0370-05
CONST	CONSTRUCTION	SE	SOUTHEAST	PER STEWART TITLE GUARANTY COMPANY, GUARANTEE №. G-6329-000007867, JANUARY 8, 2016
CP	CONCRETE PIPE	SEW	STRUCTURAL EARTH WALL	THAT PORTION OF LOTS 11 THROUGH 16, BLOCK 6, INGLEWOOD, ACCORDING TO THE PLAT THEREOF RECORDED IN VOLUME 3 OF PLATS, PAGE 169, RECORDS OF KING
CSTC	CRUSHED SURFACING TOP COURSE	SF	SOUARE FEET	LAKE SAMMANISH PARKWAY N. E. (ISSAQUAH-REDMOND ROAD REVISION NO. 2); EXCEPT HOSE PORTIONS CONVEYED TO KING COUNTY FOR ROAD PRUPPOSES BY DEEDS RECORDED UNDER RECORDING NUMBERS 983354 AND 983356;
CY	CUBIC YARDS			AND EXCEPT INDSE PORTIONS CONVECTED TO RING COUNTLY IN OPPORTOSES & DELEDAS RECORDED UNDER RECORDING NUMBER 395050, AND EXCEPT THAT PORTION RESERVED FOR ROAD BY KING COUNTLY IN DEED RECORDED UNDER RECORDING NUMBER 769006; AND TOGETHER WITH THAT PORTION, IF ANY, OF VACATED ASH STREET (N. E. 16TH STREET) ADJOINING, VACATED BY KING COUNTY SUPERIOR COURT CAUSE NUMBER 94
		SHLDR	SHOULDER	
DI, DIA		SIM	SIMILAR	PARCEL No. 292506-9007
DI, DIP	DUCTILE IRON PIPE	SPWSD	SAMMAMISH PLATEAU WATER AND SEWER DISTRICT	THAT PORTION OF THE BURLINGTON NORTHERN AND SANTA FE RAILWAY COMPANY'S (FORMERLY NORTHERNPACIFIC RAILWAY COMPANY) SNOQUALMIE BRANCH LINE RICHT LESS PORTION OF SAID GOVERNMENT LOT 2 AS DEEDED TO D.P. &: E.M. STAHL UNDER REC NO 9409280762; TOGETHER WITH LOTS 1 THRU 68, BLOCK 9, PLAT OF TO
E	EAST, EASTING	SS	SANITARY SEWER	FEET EASTERLY AS MEASURED AT A RIGHT ANGLE FROM MAIN TRACK CENTERLINE OF SAID BRANCH LINE RIGHT OF WAY & PORTION OF LOTS 19 THRU 24 IN BLOCK 6 EASTERLY AS MEASURED RADIALLY FROM SAID MAIN TRACK CENTERLINE & PORTIONS OF LOTS 1 THRU 22, BLOCK 4, LOTS 1 THRU 22, BLOCK 5 & LOTS 11 THRU 22,
EL, ELEV		SSFM	SANITARY SEWER FORCE MAIN	CONCENTRIC WITH & 50 FEET WESTERLY AS MEASURED AT A RIGHT ANGLE & RADIALLY FROM SAID MAIN TRACK CENTERLINE; & PORTIONS OF LOTS 1, 2 & 8, BLOCK 3 WITH & 50 FEET
EOA	EDGE OF ASPHALT	SSMH	SANITARY SEWER MANHOLE	WESTERLY AS MEASURED AT A RIGHT ANGLE & RADIALLY FROM SAID MAIN TRACK CENTERLINE; & PORTIONS OF LOTS 9, 10, 12, 13 & 16 THRU 22, BLOCK 2, OF SAIL 50 FEET WESTERLY AS MEASURED AT A RIGHT ANGLE &
EOG	EDGE OF GRAVEL	SSP	STORM SEWER PIPE	RADIALLY FROM SAID MAIN TRACK CENTERLINE; & LOTS 1 THRU 41, BLOCK 14 OF SAID PLAT LESS PORTIONS OF SAID LOTS 26 THRU 41 LYING EASTERLY OF LINE DR RIGHT ANGLE & RADIALLY FROM SAID MAIN TRACK CENTERLINE LESS PORTIONS OF SAID LOTS 9 THRU 11, LYING WESTERLY OF LINE DRAWN CONCENTRIC WITH & 25 FE
EOP	EDGE OF PAVEMENT	ST	STEEL	Less Portions said of Lots 18 thru 27 lying westerly of Line Drawn concentric with & 25 feet westerly as measured radially from said main track Hayden under Rec no 9212311137 less Portions Lots 24 & 25 lying easterly of Line Drawn concentric with & 25 feet easterly as measured radially
EVCE	END VERTICAL CURB ELEVATION	STA	STATION	11 THRU 16 BLOCK 1 OF SAID PLAT LYING EASTERLY OF A LINE DRAWN PARALLEL & CONCENTRIC WITH & 50 FEET WESTERLY AS MEASURED AT A RIGHT ANGLE & RADIALLY FROM SAID MAIN TRACK CENTERLINE; & PORTION IF ANY SAID RAILWAY CO'S BRANCH LINE RIGHT OF
EVCS	END VERTICAL CURB STATION	STM	STORM	BLOCK 6, LOTS 1 THRU 41 BLOCK 14; & LYING EASTERLY OF LOTS 1 THRU 22, BLOCK 4, LOTS 1 THRU 22, BLOCK 5, LOTS 1 THRU 22, BLOCK 3, LOTS 1 THRU 22
EX, EXIST	EXISTING	SW	SOUTHWEST	
FL	FLANGE, FLOWLINE	TC	TOP OF CURB	
FM	FORCE MAIN	TEL	TELEPHONE	
FOC	FACE OF CURB	TESC	TEMPORARY EROSION AND SEDIMENT CONTROL	
FT	FOOT, FEET	TOW, TW	TOP OF WALL	DETAIL AND SECTION DESIGNATION
G	GAS	TYP	TYPICAL	
GB	GRADE BREAK	UD	UNDERDRAIN	INDICATES DETAIL INDICATES SECTION
HMA	HOT MIX ASPHALT	UDP	UNDER DRAIN PIPE	(1) NUMBER (2) LETTER
IE	INVERT ELEVATION	w	WATER	INDICATES DRAWING/SHEET WHERE DETAIL IS SHOWN WHERE SECTION IS SHOWN
LF	LINEAR FEET	WQ	WATER QUALITY	
LP	LOW POINT	WS	WATER SERVICE	$(\frac{2}{-})_{x}$
LT	LEFT	WSDOT	WASHINGTON STATE DEPARTMENT OF TRANSPORTATION	12345 STANDARD DETAIL DETAIL OR SECTION APPEARS ON THE SAME DRAWING/SHEET
МАХ	MAXIMUM	WWM	WELDED WIRE MESH	
ме	MATCH EXISTING			
MIN	мілімим			
MON	MONUMENT			
N	NORTH, NORTHING			NO SCALE M4 NO SCALE C5
NE	NORTHEAST			
N.I.C.	NOT IN CONTRACT			INDICATES DRAWING/SHEET INDICATES DRAWING/SHEET WHERE DETAIL IS REFERRED TO - WHERE SECTION IS REFERRED TO -
NPDES	NATIONAL POLLUTANT DISCHARGE ELIMINATION SYSTEM			
NST	NOT STEEPER THAN			The
NW	NORTHWEST			with Sto
0.C.	ON CENTER			the Agr
				Sar
OP	OVERHEAD POWER		201505-55	City
PC	POINT OF CURVE		CONFORMED	DRAWINGS
			915 A	the Prove
	DATE BY	DESIGNED R. MCCABE	ONE INCH AT FULL SCALE.	PROJECT NAME
		R. MCCABE	IF NOT, SCALE ACCORDINGLY	ENGINEERING. PLANNING. ENVIRONMENTAL SCIENCES KING COUNTY PARKS AND RECREAT
		CHECKED R. PARKER	BL1521075P21T03G-02 JOB No. 554-1521-075 P21T03	719 2ND AVENUE, SUITE 200 SEATTLE, WA 98104 PARKING LOT - PHASE 1
f		APPROVED D. PROCTOR	<u>554-1521-075 P21T03</u> DATE JUNE 2021	P 206.394.3700 WWW.PARAMETRIX.COM SAMMAMISH, WA

ED IN VOLUME 3 OF PLATS, PAGE 169, RECORDS OF KING COUNTY, WASHINGTON, LYING RDED UNDER RECORDING NUMBER 3051111; 3, 983354 AND 983355;

1-1, AS WOULD ATTACH BY OPERATION OF LAW.

LEGAL DESCRIPTIONS (NO IMPROVEMENTS WILL BE MADE TO THESE PARCELS):

COUNTY, WASHINGTON, LYING WESTERLY OF THE WESTERLY MARGIN OF EAST LAKE SAMMAMISH

Y SUPERIOR COURT CAUSE NUMBER 94-2-14451-1, AS WOULD ATTACH BY OPERATION OF LAW.

COUNTY, WASHINGTON, LYING EASTERLY OF THE EASTERLY MARGIN OF THE NORTHERN PACIFIC

CORDS OF KING COUNTY, WASHINGTON, LYING WESTERLY OF THE WESTERLY MARGIN OF EAST

AUSE NUMBER 94-2-14451-1, AS WOULD ATTACH BY OPERATION OF LAW.

NCH LINE RIGHT-OF-WAY 100 FEET IN WIDTH OVER AND ACROSS GOVERNMENT LOTS 1 & 2 ICK 9, PLAT OF TOWN OF INGLEWOOD LYING WESTERLY OF LINE DRAWN PARALLEL WITH & 50 I 24 IN BLOCK 6 OF SAID PLAT LYING WESTERLY OF LINE DRAWN CONCENTRIC WITH & 50 FEET IOTS 11 THRU 22, BLOCK 3 OF SAID PLAT LYING EASTERLY OF A LINE DRAWN PARALLEL & , 2 & 8, BLOCK 3 OF SAID PLAT LYING EASTERLY OF A LINE DRAWN PARALLEL & CONCENTRIC

BLOCK 2, OF SAID PLAT LYING EASTERLY OF A LINE DRAWN CONCENTRIC & PARALLEL WITH &

TERLY OF LINE DRAWN PARALLEL & CONCENTRIC WITH & 50 FEET EASTERLY AS MEASURED AT A RIC WITH & 25 FEET WESTERLY AS MEASURED RADULLY FROM SAID MAIN TRACK CENTERLINE SAID MAIN TRACK CENTERLINE (AS 28 & 29 DEEDED TO J & E EASURED RADULLY FROM SAID MAIN TRACK CENTERLINE; & PORTIONS LOTS 0 THRU 7 & LOTS

LINE RIGHT OF WAY LYING WESTERLY OF LOTS 1 THRU 68, BLOCK 9, LOTS 19 THRU 24 LOTS 1 THRU 22, BLOCK 2 & LOTS 0 THRU 20, BLOCK 1 OF SAID PLAT.

These drawin with City of Si Stormwater re the requirement Agreement be Sammamish I City of Samm been deemec responsibility	DF SAMMAMISH PUBLIC WORKS DEVELOPMENT REVIEW gs have been reviewed for compliance ammamish Clearing and Grading and equirements and also in accordance with ants as established in the Settlement etween King County vs. City of No. C17-0921 JCC and King County vs. iamish No. 17-2-29922-7 SEA and have ACCEPTABLE. The reviewer accepts no for any errors and/or omissions made by of these drawings. 17 February 2022	City Engineer	Date Date SH STAMPS
ATION	ABBREVIATIONS DESCRIPT	-	SHEET NO. 160 OF 213 G2

CITY OF SAMMAMISH APPROVAL

LEGEND

			APPROVED D. PROCTOR	DATE JUNE 2021
			R. PARKER	JOB No. 554-1521-075 P21T03
			R. MCCABE	FILE NAME BL1521075P21T03G-03
REVISIONS	DATE	BY	DESIGNED R. MCCABE	ONE INCH AT FULL SCAL
	1		1	T (
EDGE OF PATCH				
CURB AND GUTTER				
CONCRETE LINE				
ASPHALT EDGE				///
SAWCUT			//_	
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FILL LINE	FF	F	F-	
CLEARING LIMITS				
CLEARING AND GRUBBING LIMITS	e 	- cg — - c	<u>; </u>	
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HIGH VISIBILITY SILT FENCE	_o_o_o			
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SANITARY SEWER MANHOLE	۲		\odot	
SANITARY SEWER LINE	0		SS	
INLET PROTECTION	0			
CATCH BASIN, TYPE 2				
CATCH BASIN, TYPE 1				
INFILTRATION TRENCH	AND TO THE AND	u an		
QUARRY SPALL	(C)	\$		
CULVERT/STORM DRAIN PIPE				
STORM DRAIN			SD	
TEMPORARY DRAIN PIPE	DD-			
Centerline & Edges Underdrain Pipe				
JURISDICTIONAL DITCH				
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RIGHT OF WAY				
DESCRIPTION	PROPO	<u>SED</u>	EXISTING	

LEGEND			LEGEND
DESCRIPTION	PROPOSED	EXISTING	DESCRIPTION
EDGE OF GRAVEL			IRRIGATION CONT
BARBWIRE FENCE		XXX	FLOW DIRECTION
SPLIT RAIL FENCE		// // //	TRAFFIC SIGNAL
BOARD FENCE	oo		TRAFFIC SIGNAL
CHAIN LINK FENCE			TRAFFIC CONTROL
TEMPORARY CHAIN LINK FENCE	øø		TRAFFIC CONTROL
HOG WIRE FENCE			PEDESTRIAN POL
WOOD GUARDRAIL			MONITORING WEL
METAL HANDRAIL			SURFACE POST
GUY ANCHOR		\rightarrow	SIGN
POWER POLE WITH LIGHT		\leftarrow	SKIP LANE LINE
FLOOD LIGHT		، مېرە بېر	SOLID LANE LINE
UTILITY POLE		-0-	FOG LINE
PP W/ UG DROP		-©-	LTO ARROW
PP W/ UG DROP & XMFR		-@-	STO ARROW
OVERHEAD POWER			RTO ARROW
POWER		P	MAILBOX
POWER VAULT		P	DECIDUOUS TREE
POWER TRANSFORMER			
POWER MANHOLE		®	CONIFEROUS TRE
POWER HANDHOLE		P	WETLAND SYMBOL
POWER CABINET		PWR CAB	WETLAND BOUND
POWER RISER		PR	VEGETATION
POWER METER		\otimes	STRUCTURAL EAR
SOLID LID J-BOX			
LUMINAIRE		·Ó- *	RIP RAP
TELEPHONE VAULT		T I	ROCKERY
TELEPHONE RISER		TR	HANDICAPPED SY
TELEPHONE MANHOLE		(T)	WHEELCHAIR RAM
TELEPHONE		T	BUILDING LINE
TV RISER		T	CONCRETE STAIR
TV			WOOD STAIRWAY
GAS VALVE		\square	REMOVE ASPHALT
GAS METER			PATTERNED CONC
GAS		G	RAMP DETECTABL
WATER LINE			RESTORATION PL
FIRE HYDRANT		Y	SANDBAG DAM
WATER METER		\blacksquare	CHECK DAM
WATER VALVE		\bowtie	WATTLE CHECK [
AREA DRAIN			FORMER RAILROA
ROOF DRAIN		8	FURMER RAILRUA
WATER BLOW OFF VALVE		Ŷ	CONSTRUCTION C
WATER POST INDICATOR			
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CONFORMED DRAWINGS


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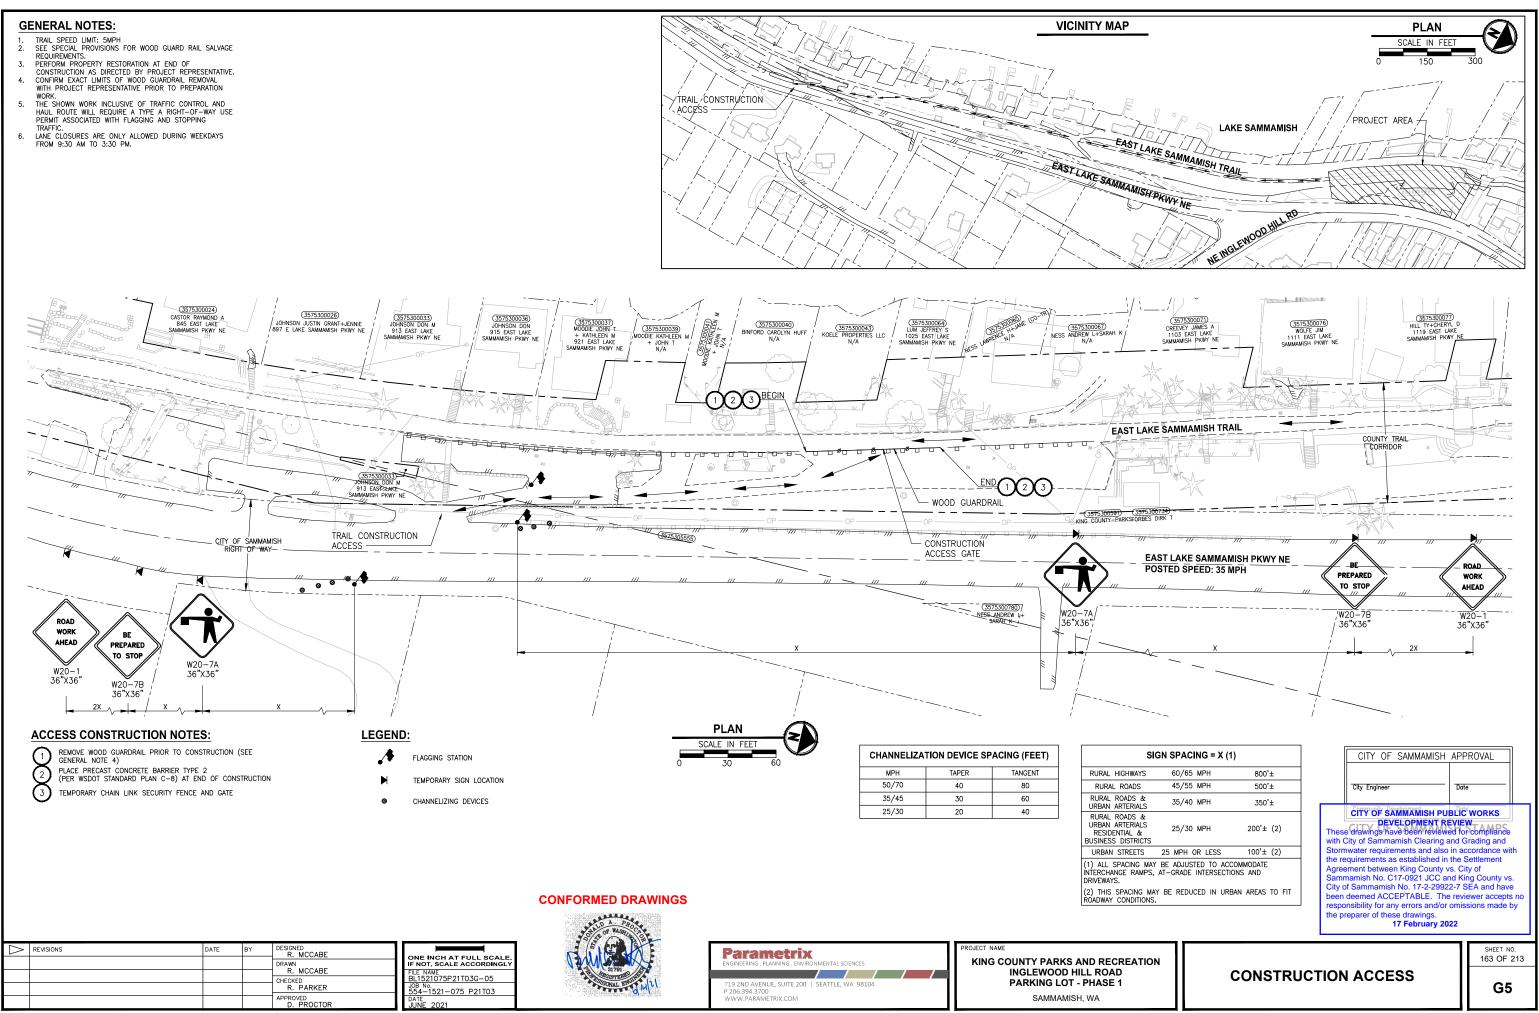
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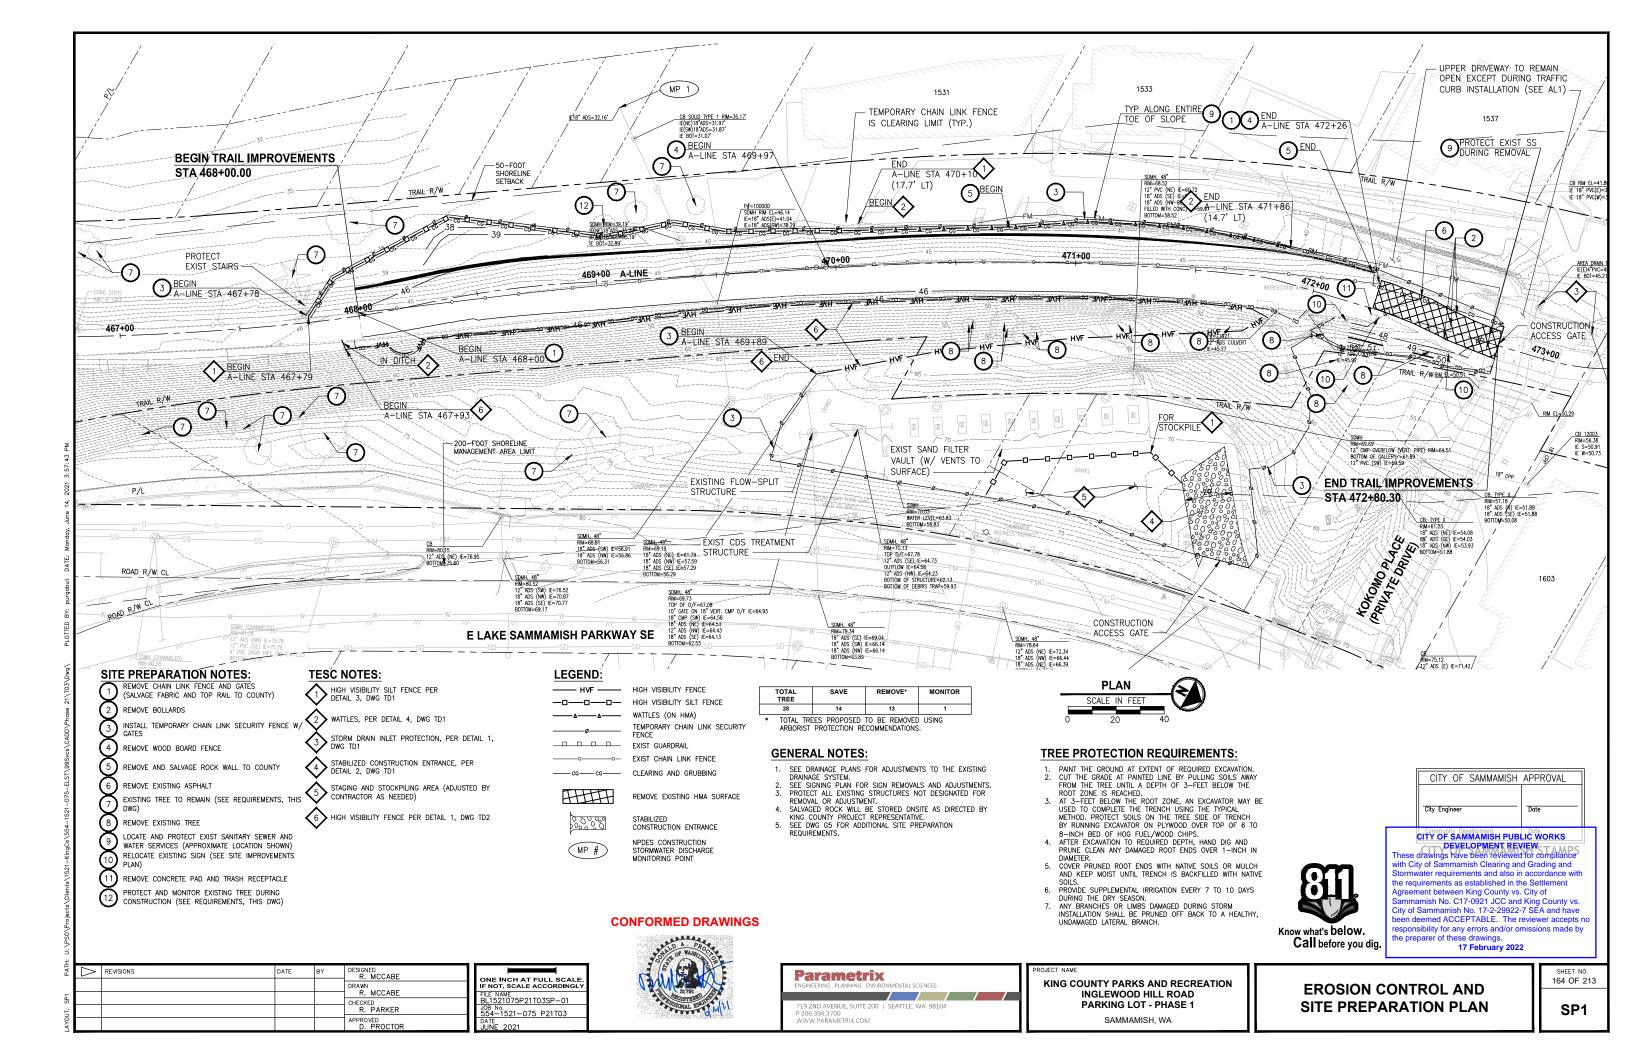
PROJECT NAME KING COUNTY PARKS AND RECRE INGLEWOOD HILL ROAD PARKING LOT - PHASE 1 SAMMAMISH, WA


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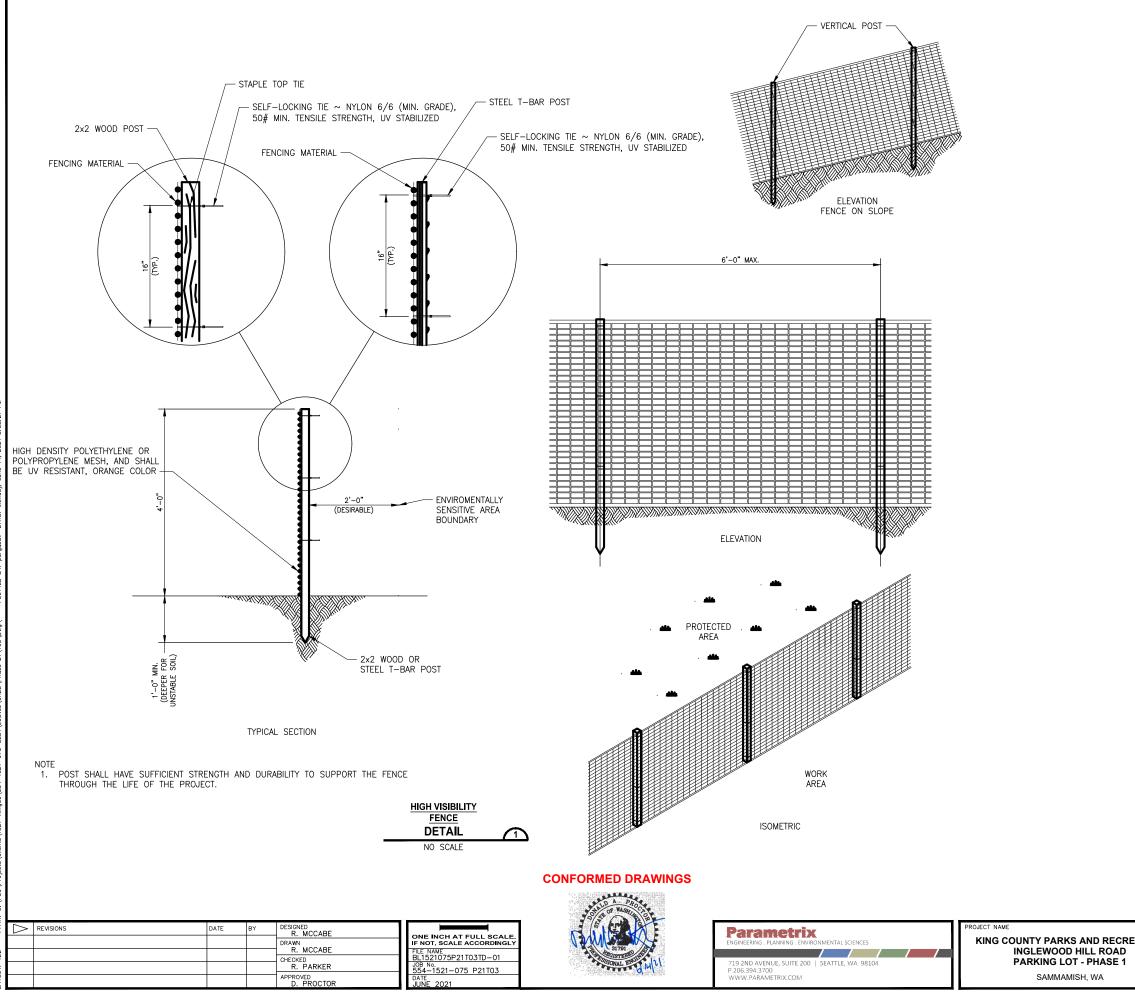
	LINETYPE		G3
EATION	GENERAL S		SHEET NO. 161 OF 213
AD CENTERLINE	<u>220RR_C/L</u> 220+00A-LINE 	OEVELOPMENT REVI These drawings have been reviewed with City of Sammamish Clearing and Stormwater requirements and also in the requirements as established in the Agreement between King County vs. Sammamish No. C17-0921 JUC and City of Sammamish No. 17-2-29922-7 been deemed ACCEPTABLE. The re responsibility for any errors and/or or the preparer of these drawings. 17 February 2022	Grading and accordance with a Settlement City of King County vs. 'SEA and have viewer accepts no iissions made by
DAM		Community Development Do CITY OF SAMMAMISH PUBL	
LANTING AREA		CITY OF SAMMAMISH AP	
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SAMMAMISH, WA

EROSION CONTROL DETAILS

SHEET NO. 166 OF 213

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Stormwater requirements and also in accordance with			
the requirements as established in the Settlement			
Agreement between King County vs. City of			
Sammamish No. C17-0921 JCC and King County vs.			
City of Sammamish No. 17-2-29922-7 SEA and have			
been deemed ACCEPTABLE. The reviewer accepts no			
responsibility for any errors and/or omissions made by			
the preparer of these drawings.			
17 February 2022			

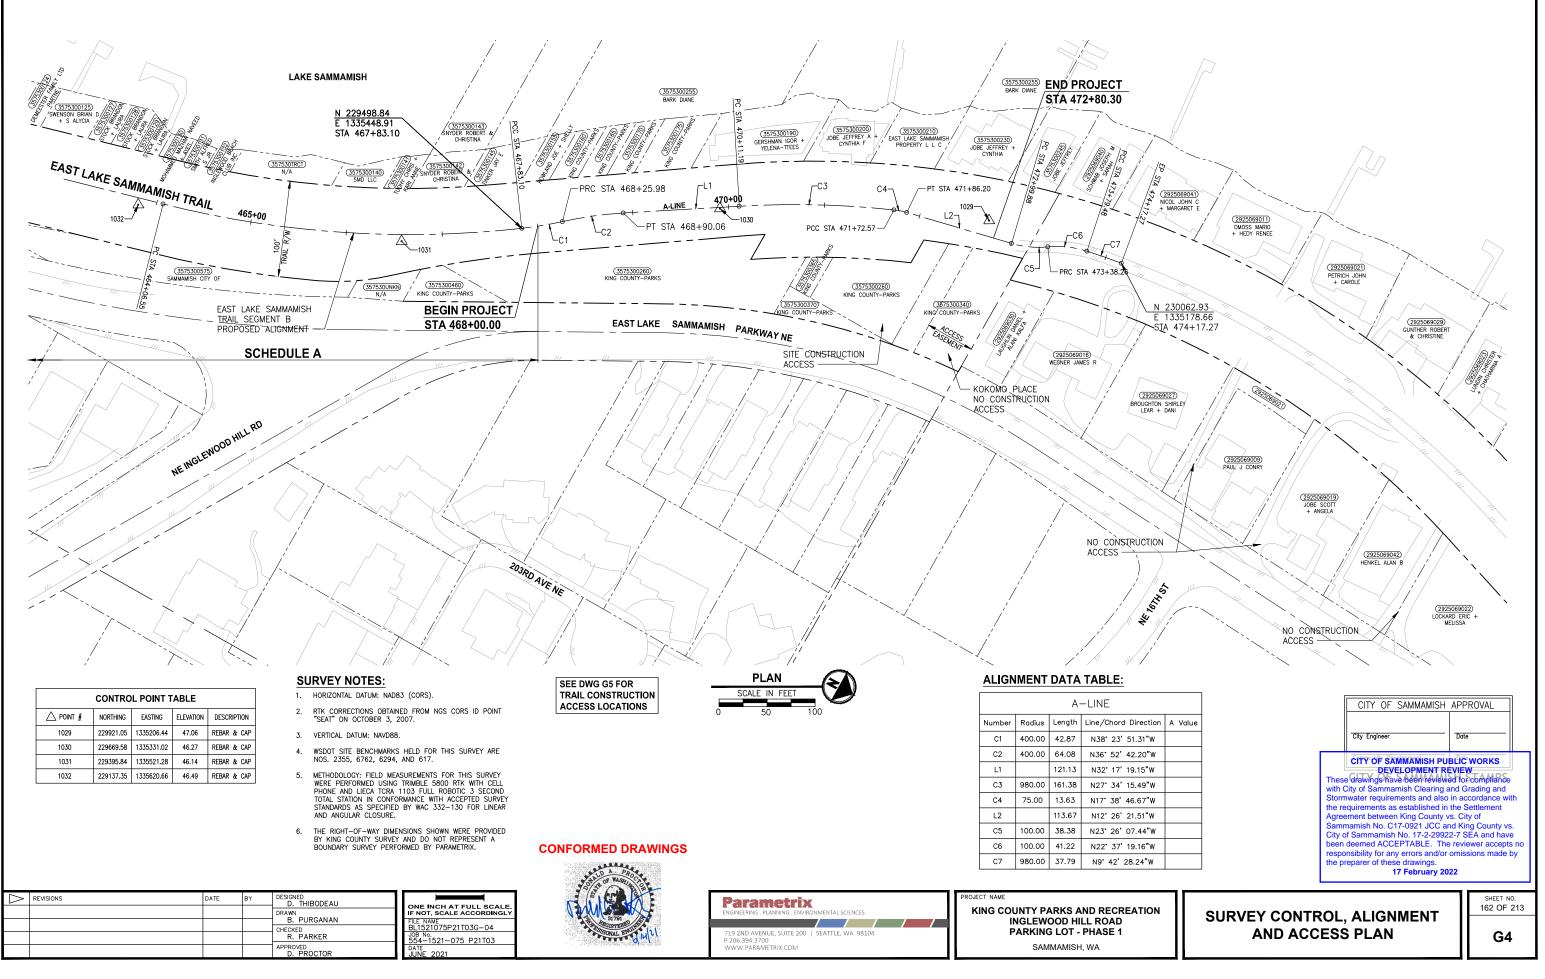CITY OF SAMMAMISH PUBLIC WORKS DEVELOPMENT REVIEW These drawings have been reviewed for compliance with City of Sammamish Clearing and Grading and Determine the and the increase with

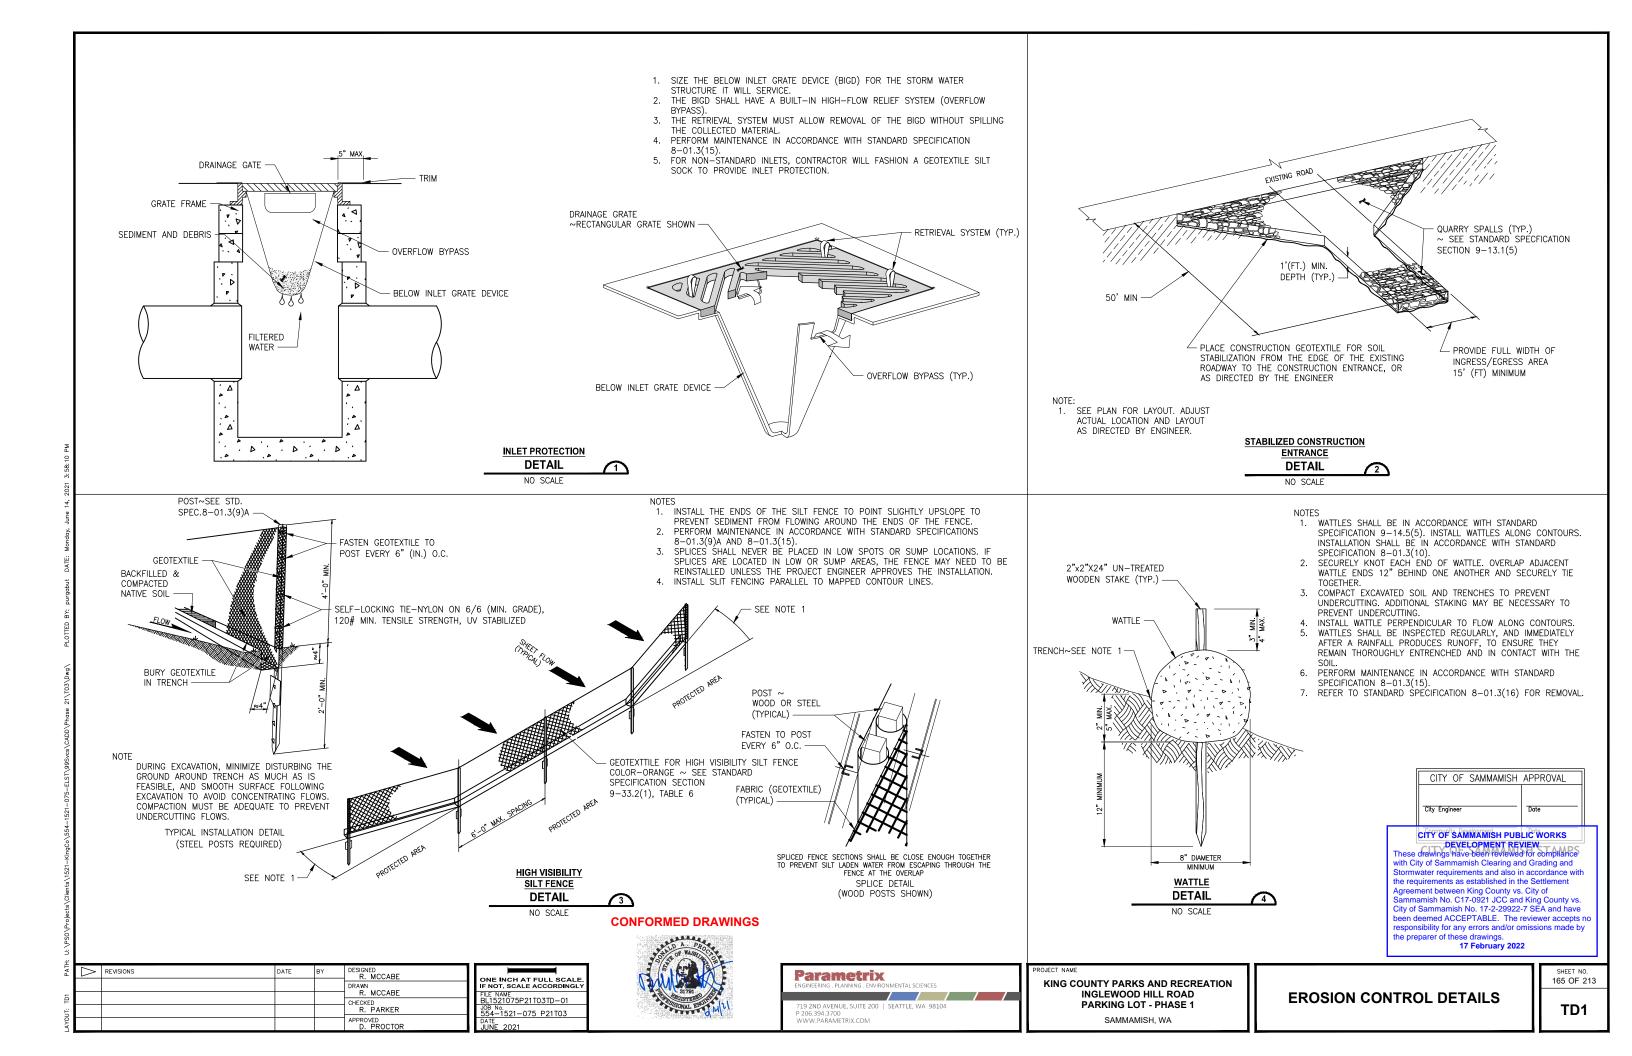CITY OF SAMMAMISH STAMPS

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City Engi		
Commun	ity De	velopment

Date Date

CITY OF SAMMAMISH APPROVAL