

NEVELLE SHORT PLAT

NW 1/4 OF SW 1/4 OF SECTION 3, T. 23 N., R. 8 E., W.M. KING COUNTY, STATE OF WASHINGTON

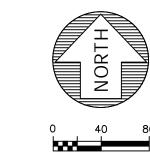

SCALE 1" = 80

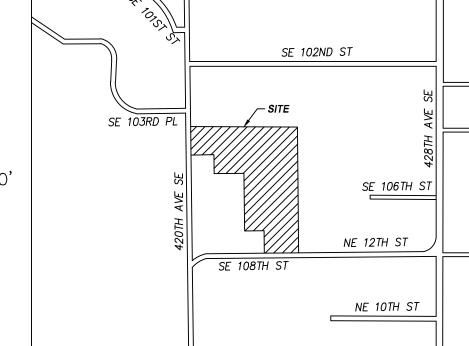

PROJECT TEAM:

DIRK NEVELLE PO BOX 1421 NORTH BEND, WA 98045 (206) 484-0777

ENGINEER/SURVEYOR/PLANNER: CHAD ALLEN, PE/STEVE MCCASKEY, PLS/AMY DONLAN ENCOMPASS ENGINEERING & SURVEYING 165 N.E. JUNIPER STREET, SUITE 201

ISSAQUAH, WA 98027 (425) 392-0250

GEOTECHNICAL ENGINEER:

ANDREW L. GLANDON, LEG, CPESC SOUTHFORK GEOSCIENCES, PLLC PO BOX 1275 NORTH BEND, WA 98045

(425) 831-2023

BIOLOGIST:

JOHN ALTMANN ALTMANN OLIVER ASSOCIATES PO BOX 578 CARNATION, WA 98014

SITE DATA:

TAX PARCEL:

MAX LOT WIDTH:

SITE ADDRESS: 10408 420 AVE SE NORTH BEND, WA 98045

425-333-4535

932,777 SF (21.41 ACRES) PER KING COUNTY ASSESSORS REPORT SITE AREA:

932,789 SF (21.41 ACRES) PER SURVEY

135 FEET

TOTAL PROPOSED LOTS:

ZONING: BASE DENSITY: 0.1 DU/ACRE MIN LOT AREA: 7.5 ACRES*

MAX IMPERVIOUS SURFACE: 15%

*PER KCC 21A.14, MINIMUM LOT AREA DOES NOT APPLY TO LOT CLUSTERING PROPOSALS.

NO. TITLE

SHEET INDEX

1 of 5 COVER SHEET 2 of 5 TESC & DEMOLITION PLAN 3 of 5 TESC DETAILS 4 of 5 GRADING & DRAINAGE PLAN

5 of 5 | CONSTRUCTION DETAILS

UTILITY INFORMATION:

SEWER:

CITY OF NORTH BEND WATER:

ELECTRIC/GAS: PUGET SOUND ENERGY (888) 225-5773

PRIVATE

TAX PARCEL:

032308-9160

HORIZONTAL DATUM:

NAD 83/2011 - ESTABLISHED PER OBSERVATION TO THE WASHINGTON STATE REFERENCE NETWORK

BASIS OF BEARINGS:

A BEARING OF NO1°33'23"W BETWEEN FOUND MONUMENT IN CASE ON CENTERLINE OF 420TH AVE SE AND FOUND WGS 4617

VERTICAL DATUM:

NAVD 88 — ESTABLISHED PER WSRN OBSERVATION ON BENCHMARK

BENCHMARK:

SET MAG & TAG ON EDGE OF ASPHALT ON SE 108TH ST ELEVATION=440.53

INSTRUMENTATION:

INSTRUMENT USED: 5 SECOND TOTAL STATION.

FIELD SURVEY WAS BY CLOSED TRAVERSE LOOPS, MINIMUM CLOSURE OF LOOPS WAS 1:22,000, IN ACCORDANCE WITH WAC 332-130-090.

LEGAL DESCRIPTION:

LOT A OF KING COUNTY BOUNDARY LINE ADJUSTMENT NO. L97L0067, RECORDED JUNE 11, 1997 UNDER RECORDING NO. 9706119003, IN KING COUNTY, WASHINGTON.

BSBL DISTANCES:

S STREET SETBACK: 30' NINTERIOR SETBACK: 10'

S STREAM BUFFER: 15'

APPROXIMATE IMPERVIOUS COVERAGE:

8,847 SF

57,288 SF

6,740 SF

10,000 SF

66,135 SF (7.09%)

-EXISTING ON-SITE-LOT 1 BUILDINGS: GRAVEL DRIVEWAY:

MAX IMPERVIOUS

TOTAL: -PROPOSED-ACCESS EASEMENT:

* AN ADDITIONAL 73 SF OF ASPHALT DRIVEWAY IS BEING PROPOSED IN THE PUBLIC ROW

EXISTING UTILITY NOTE:

ALL LOCATIONS OF EXISTING UTILITIES SHOWN HEREON HAVE BEEN ESTABLISHED BY FIELD SURVEY OR OBTAINED FROM AVAILABLE RECORDS AND SHOULD THEREFORE BE CONSIDERED APPROXIMATE ONLY AND NOT NECESSARILY COMPLETE. IT IS THE SOLE RESPONSIBILITY OF THE CONTRACTOR TO INDEPENDENTLY VERIFY THE ACCURACY OF ALL UTILITY LOCATIONS SHOWN AND TO FURTHER DISCOVER AND AVOID ANY OTHER UTILITIES NOT SHOWN HEREON WHICH MAY BE AFFECTED BY THE IMPLEMENTATION OF THIS PLAN.

CONTRACTOR RESPONSIBILITY:

CONTRACTOR AGREES THAT HE SHALL ASSUME SOLE AND COMPLETE RESPONSIBILITY FOR JOB SITE CONDITIONS, INCLUDING THE SAFETY OF ALL PERSONS AND PROPERTY, DURING THE COURSE OF CONSTRUCTION OF THIS PROJECT, AND THAT THIS REQUIREMENT SHALL APPLY CONTINUOUSLY AND NOT BE LIMITED TO NORMAL WORKING HOURS. THE CONTRACTOR SHALL DEFEND, INDEMNIFY AND HOLD THE OWNER AND THE ENGINEER HARMLESS FROM ANY AND ALL LIABILITY, REAL OR ALLEGED, IN CONNECTION WITH THE PERFORMANCE OF WORK ON THIS PROJECT, EXCEPTING FOR LIABILITY ARISING FROM THE SOLE NEGLIGENCE OF THE OWNER OR THE ENGINEER.

DISCREPANCIES:

IF THERE ARE ANY DISCREPANCIES BETWEEN DIMENSIONS IN DRAWINGS AND EXISTING CONDITIONS WHICH WILL AFFECT THE WORK, THE CONTRACTOR SHALL BRING SUCH DISCREPANCIES TO THE ATTENTION OF THE ENGINEER FOR ADJUSTMENT BEFORE PROCEEDING WITH THE WORK. THE CONTRACTOR SHALL BE RESPONSIBLE FOR THE PROPER FITTING OF ALL WORK AND FOR THE COORDINATION OF ALL TRADES, SUBCONTRACTORS, AND PERSONS ENGAGED UPON THIS CONTRACT.

GIS DISCLAIMER:

PORTIONS OF THE INFORMATION ON THIS DRAWING HAVE BEEN CREATED USING A SUBSET OF DATA OBTAINED FROM THE KING COUNTY GIS DATABASE, AND HAS NOT BEEN INDEPENDENTLY VERIFIED BY ENCOMPASS ENGINEERING & SURVEYING (EES). THIS DATA IS PROVIDED FOR YOUR INFORMATION ONLY. EES DOES NOT ASSUME ANY LIÁBILITY FOR ANY ERRORS, OMISSIONS OR INACCURACIES IN THE GIS INFORMATION SHOWN.

CONTRACTOR NOTES:


THE CONTRACTOR SHALL HAVE APPROVED PLANS, STANDARD NOTES, STANDARD DETAILS AND SPECIFICATIONS AVAILABLE ON JOBSITE.

2. CONTRACTOR TO COORDINATE CONNECTIONS TO DRY UTILITIES. CALL 811 FOR UTILITY


| PARCEL AREA | A TABLE |
|------------------|------------|
| PARCEL | AREA |
| BUFFER IMPACT | 1,233 SF |
| CRITICAL AREA | 203,175 SF |
| LOT 1 | 633,489 SF |
| LOT 2 | 57,181 SF |
| OPEN SPACE TRACT | 37,708 SF |



SCALE DESIGNED DRAWN CHECKED *APPROVED* AMDCall before you dig. SHEET

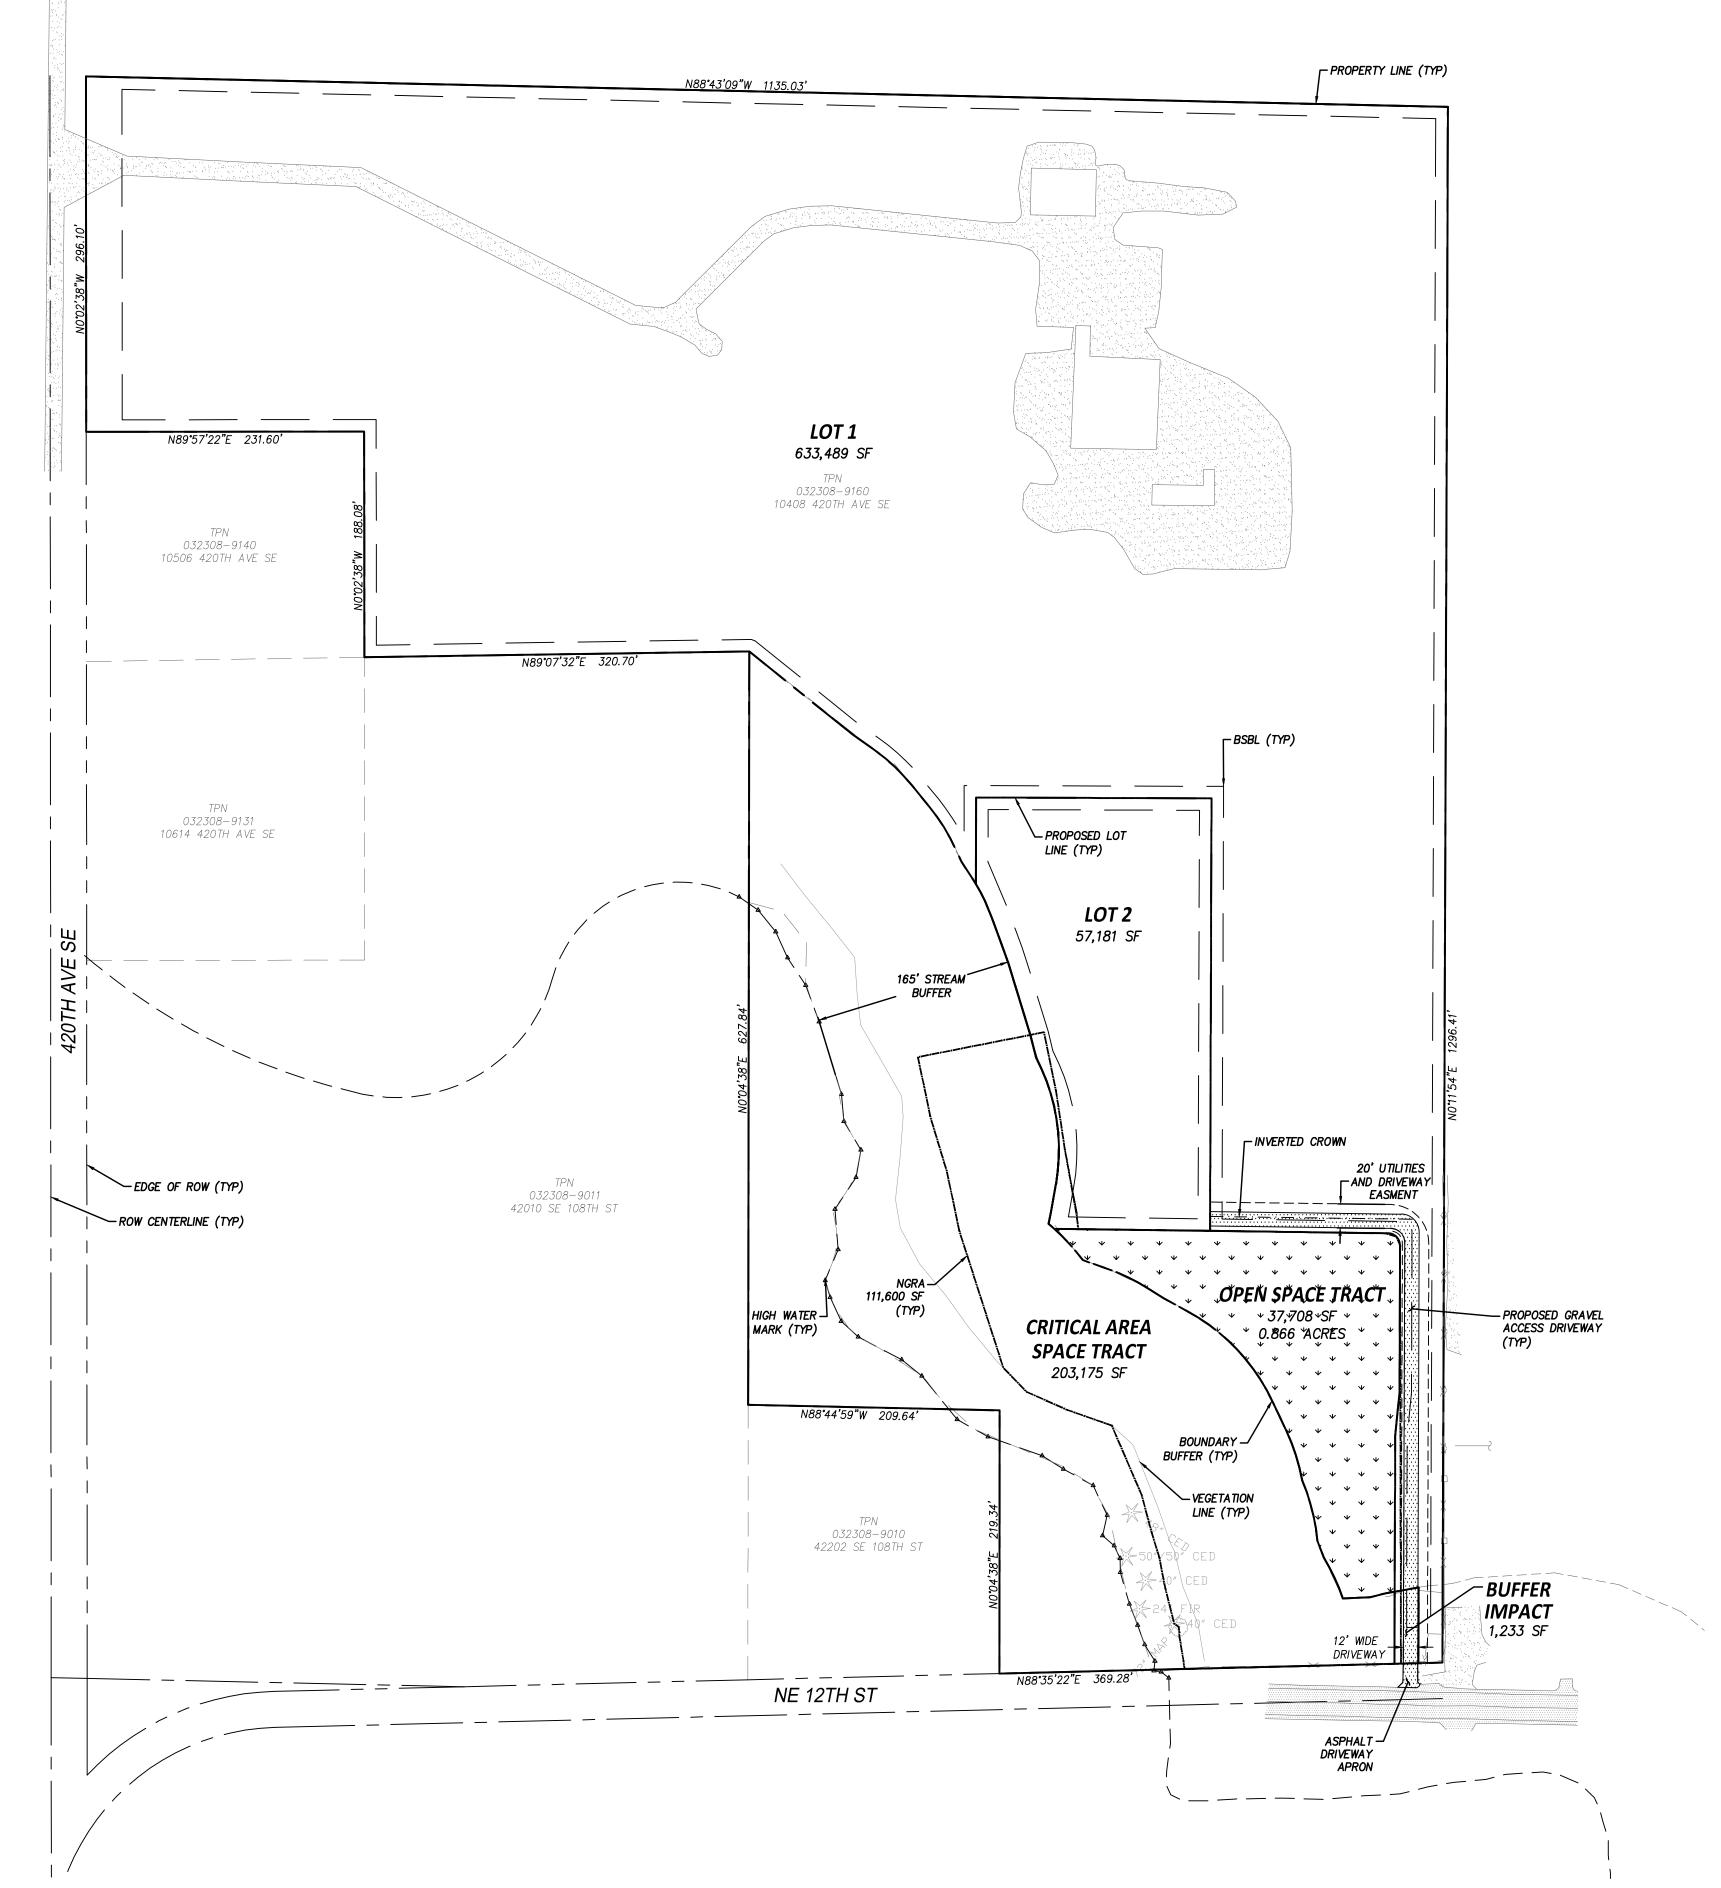



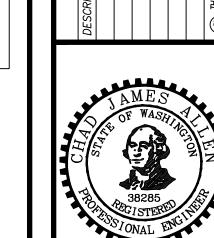


11/18/2024

19655 11/18/2024 SCALE AMDPMS

NEVELLE SHORT PLAT

NW 1/4 OF SW 1/4 OF SECTION 3, T. 23 N., R. 8 E., W.M. KING COUNTY, STATE OF WASHINGTON

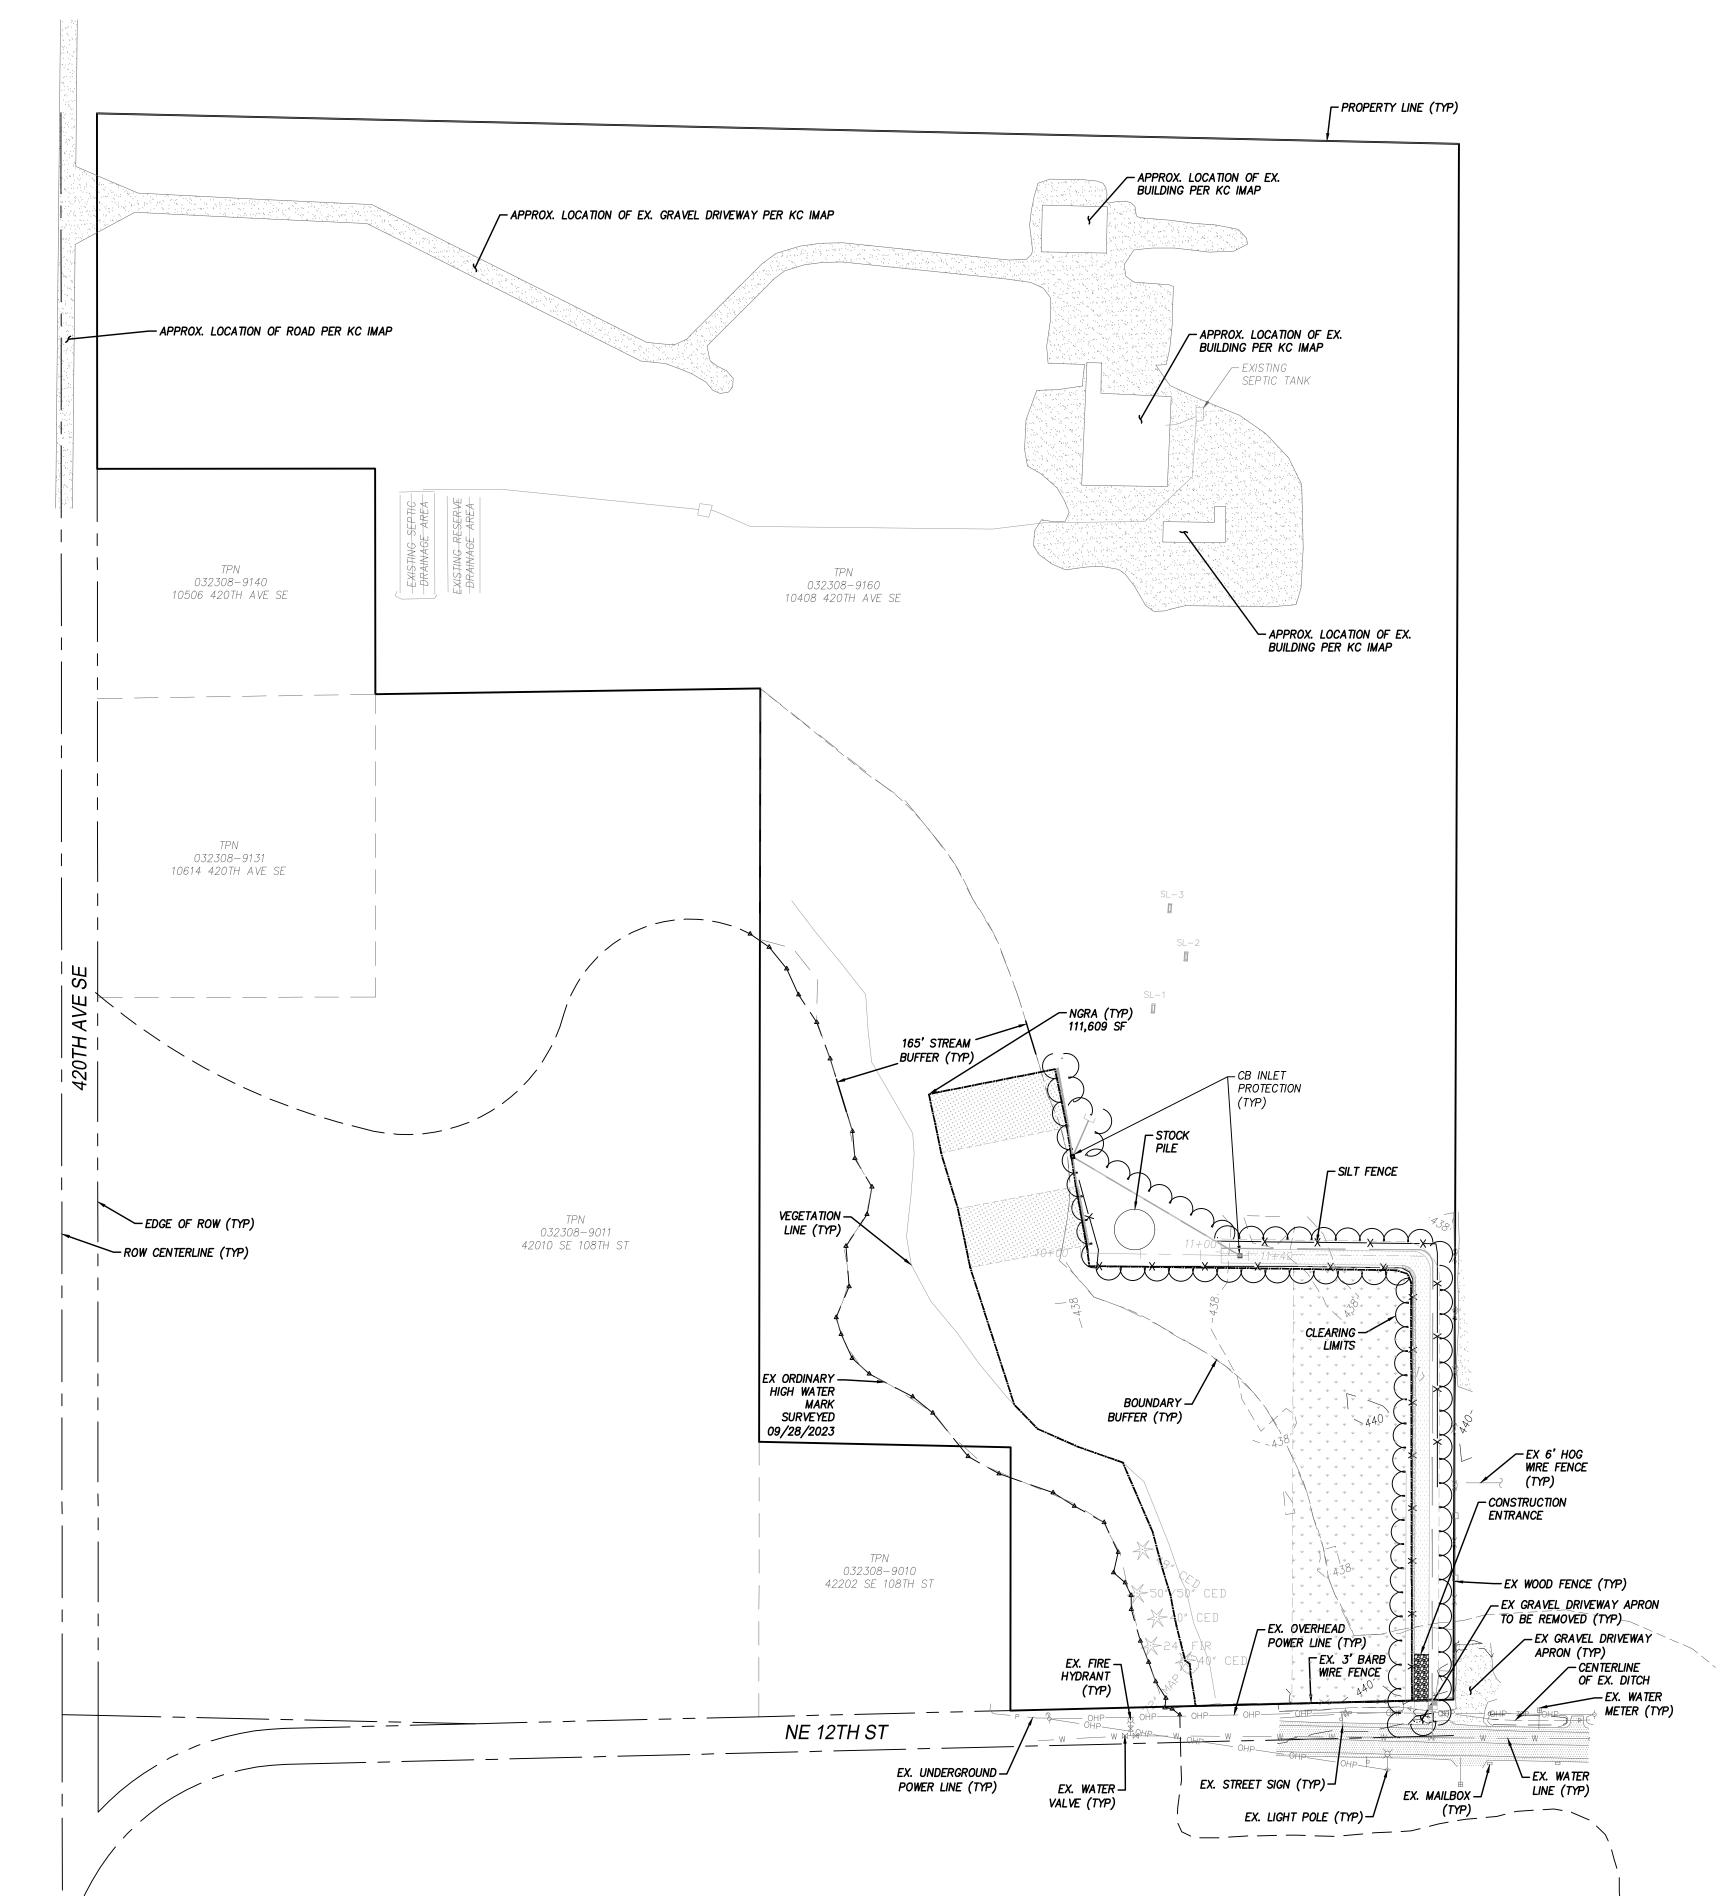

TESC LEGEND:

CONSTRUCTION LIMITS

X SILT FENCE PER DETAIL SHEET 3

CB INLET PROTECTION PER DETAIL SHEET .

TEMPORARY CONSTRUCTION ENTRANCE PER DETAIL SHEET 3

LEGEND

WATER VALVE FIRE HYDRANT WATER METER BOLLARD MAILBOX LIGHT POLE SIGN POST UTILITY POLE GUY ANCHOR WETLAND FLAG UNDERGROUND POWER LINE OVERHEAD POWER LINE

WATER LINE STORM LINE **WOOD FENCE** CHAIN LINK FENCE EVERGREEN TREE

DECIDUOUS TREE **ASPHALT**

GRAVEL

EROSION AND SEDIMENTATION CONTROL NOTES:


- APPROVAL OF THIS EROSION AND SEDIMENTATION CONTROL (ESC) PLAN DOES NOT CONSTITUTE AN APPROVAL OF PERMANENT ROAD OR DRAINAGE DESIGN (E.G., SIZE AND LOCATION OF ROADS, PIPES, RESTRICTORS, CHANNELS, RETENTION FACILITIES, UTILITIES, ETC.).
- 2. THE IMPLEMENTATION OF THESE ESC PLANS AND THE CONSTRUCTION, MAINTENANCE, REPLACEMENT, AND UPGRADING OF THESE ESC FACILITIES IS THE RESPONSIBILITY OF THE APPLICANT/ESC SUPERVISOR UNTIL ALL CONSTRUCTION IS APPROVED.


THE BOUNDARIES OF THE CLEARING LIMITS SHOWN ON THIS PLAN SHALL BE CLEARLY FLAGGED BY A CONTINUOUS LENGTH OF

- ORANGE PROTECTION FENCING PRIOR TO CONSTRUCTION. DURING CONSTRUCTION, NO DISTURBANCE BEYOND THE CLEARING LIMITS SHALL BE PERMITTED. THE CLEARING LIMITS SHALL BE MAINTAINED BY THE APPLICANT/ESC SUPERVISOR UNTIL ALL CONSTRUCTION IS
- 4. THE ESC FACILITIES SHOWN ON THIS PLAN MUST BE CONSTRUCTED PRIOR TO OR IN CONJUNCTION WITH ALL CLEARING AND GRADING SO AS TO ENSURE THAT THE TRANSPORT OF SEDIMENT TO SURFACE WATERS, DRAINAGE SYSTEMS, AND ADJACENT PROPERTIES IS THE ESC FACILITIES SHOWN ON THIS PLAN ARE THE MINIMUM REQUIREMENTS FOR ANTICIPATED SITE CONDITIONS. DURING THE COURSE
- ACCOUNT FOR CHANGING SITE CONDITIONS. 6. THE ESC FACILITIES SHALL BE INSPECTED DAILY BY THE APPLICANT/ESC SUPERVISOR AND MAINTAINED TO ENSURE CONTINUED PROPER FUNCTIONING. WRITTEN RECORDS SHALL BE KEPT OF WEEKLY REVIEWS OF THE ESC FACILITIES DURING THE WET SEASON

OF CONSTRUCTION, THESE ESC FACILITIES SHALL BE UPGRADED AS NEEDED FOR UNEXPECTED STORM EVENTS AND MODIFIED TO

- (OCTOBER 1 TO APRIL 30) AND OF MONTHLY REVIEWS DURING THE DRY SEASON (MAY 1 TO SEPTEMBER 30). 7. ANY AREAS OF EXPOSED SOILS, INCLUDING ROADWAY EMBANKMENTS, THAT WILL NOT BE DISTURBED FOR TWO DAYS DURING THE WET SEASON OR SEVEN DAYS DURING THE DRY SEASON SHALL BE IMMEDIATELY STABILIZED WITH THE APPROVED ESC METHODS (E.G., SEEDING, MULCHING, PLASTIC COVERING, ETC.).
- ANY AREA NEEDING ESC MEASURES THAT DO NOT REQUIRE IMMEDIATE ATTENTION SHALL BE ADDRESSED WITHIN FIFTEEN (15) DAYS.
- THE ESC FACILITIES ON INACTIVE SITES SHALL BE INSPECTED AND MAINTAINED A MINIMUM OF ONCE A MONTH OR WITHIN 48 HOURS FOLLOWING A STORM EVENT.
- 10. AT NO TIME SHALL MORE THAN ONE (1) FOOT OF SEDIMENT BE ALLOWED TO ACCUMULATE WITHIN A CATCH BASIN. ALL CATCH BASINS AND CONVEYANCE LINES SHALL BE CLEANED PRIOR TO PAVING. THE CLEANING OPERATION SHALL NOT FLUSH SEDIMENT—LADEN WATER INTO THE DOWNSTREAM SYSTEM.
- 11. STABILIZED CONSTRUCTION ENTRANCES AND ROADS SHALL BE INSTALLED AT THE BEGINNING OF CONSTRUCTION AND MAINTAINED FOR THE DURATION OF THE PROJECT. ADDITIONAL MEASURES, SUCH AS WASH PADS, MAY BE REQUIRED TO ENSURE THAT ALL PAVED AREAS ARE KEPT CLEAN FOR THE DURATION OF THE PROJECT.
- 12. WHERE STRAW MULCH FOR TEMPORARY EROSION CONTROL IS REQUIRED, IT SHALL BE APPLIED AT A MINIMUM THICKNESS OF 2 TO 3
- PRIOR TO SEPTEMBER 15, ALL DISTURBED AREAS SHALL BE REVIEWED TO IDENTIFY WHICH ONES CAN BE SEEDED IN PREPARATION FOR THE WINTER RAINS. DISTURBED AREAS SHALL BE SEEDED PRIOR TO OCTOBER 1. A SKETCH MAP OF THOSE AREAS TO BE SEEDED AND THOSE AREAS TO REMAIN UNCOVERED SHALL BE SUBMITTED TO THE CITY INSPECTOR. THE CITY INSPECTOR CAN REQUIRE SEEDING OF ADDITIONAL AREAS IN ORDER TO PROTECT SURFACE WATERS, ADJACENT PROPERTIES, OR DRAINAGE FACILITIES.

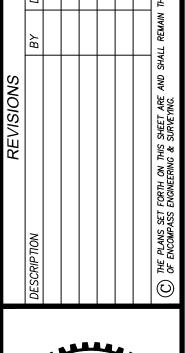

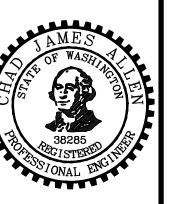


11/18/2024

DEMOLITION SHOR

| JOB NO. | 19655 |
|----------|------------|
| DATE | 11/18/2024 |
| SCALE | 1" = 80' |
| DESIGNED | AMD |
| DRAWN | CVP |
| CHECKED | PMS |
| APPROVED | AMD |
| | |

NEVELLE SHORT PLAT


NW 1/4 OF SW 1/4 OF SECTION 3, T. 23 N., R. 8 E., W.M. KING COUNTY, STATE OF WASHINGTON

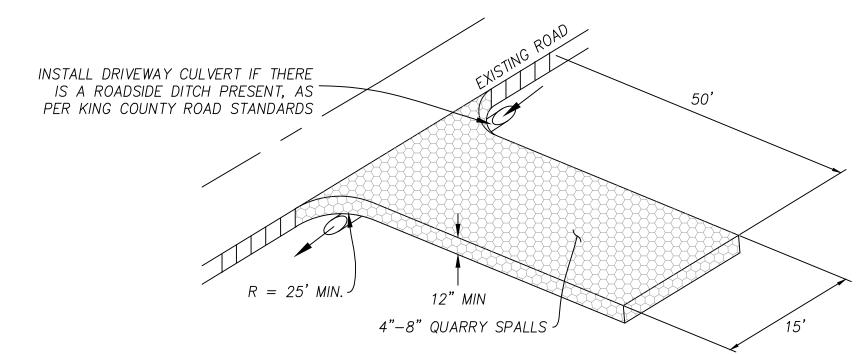

MAINTENANCE PER 2016 KCSWDM

- 1. QUARRY SPALLS (OR HOG FUEL) SHALL BE ADDED IF THE PAD IS NO LONGER IN ACCORDANCE WITH THE
- SPECIFICATION
- 2. IF THE ENTRANCE IS NOT PREVENTING SEDIMENT FROM BEING TRACKED ONTO PAVEMENT, THEN ALTERNATIVE MEASURES TO KEEP THE STREETS FREE OF SEDIMENT SHALL BE USED. THIS MAY INCLUDE STREET SWEEPING, AN INCREASE IN THE DIMENSIONS OF THE ENTRANCE, OR THE INSTALLATION OF A WHEEL WASH. IF WASHING IS USED, IT SHALL BE DONE ON AN AREA COVERED WITH CRUSHED ROCK, AND WASH WATER SHALL DRAIN TO A SEDIMENT TRAP OR POND
- 3. ANY SEDIMENT THAT IS TRACKED ONTO PAVEMENT SHALL BE REMOVED IMMEDIATELY BY SWEEPING. THE SEDIMENT COLLECTED BY SWEEPING SHALL BE REMOVED OR STABILIZED ON SITE. THE PAVEMENT SHALL NOT BE CLEANED BY WASHING DOWN THE STREE, EXCEPT WHEN SWEEPING IS INEFFECTIVE AND THERE IS A THREAT TO PUBLIC SAFETY. IF IT IS NECESSARY TO WASH THE STREETS, A SMALL SUMP MUST BE CONSTRUCTED. THE SEDIMENT WOULD THEN BE WASHED INTO THE SUMP WHERE IT CAN BE CONTROLLED. WASH WATER MUST BE PUMPED BACK ONTO THE SITE AND CAN NOT DISCHARGE TO SYSTEMS TRIBUTARY TO SURFACE WATERS.
- 4. ANY QUARRY SPALLS THAT ARE LOOSENED FROM THE PAD AND END UP ON THE ROADWAY SHALL BE REMOVED IMMEDIATELY.
- 5. IF VEHICLES ARE ENTERING OR EXITING THE SITE AT POINTS OTHER THAN THE CONSTRUCTION ENTRANCE(S), FENCING SHALL BE INSTALLED TO CONTROL TRAFFIC.

CONSTRUCTION ENTRANCE DETAIL

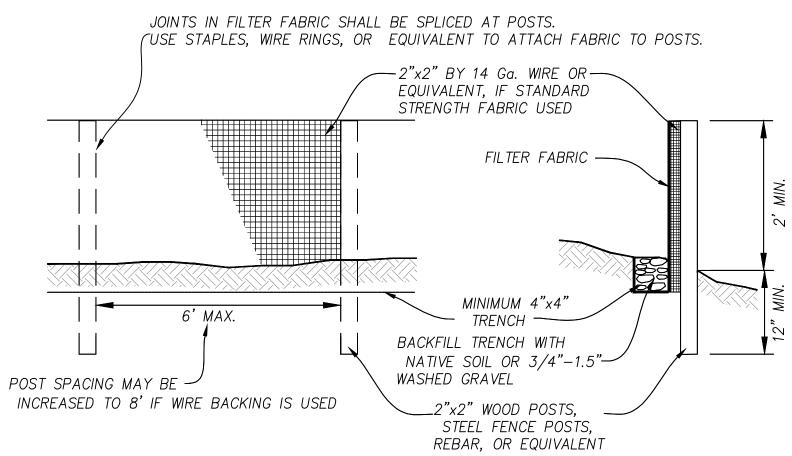


SILT FENCE MAINTENANCE PER 2016 KCSWDM

- 1. ANY DAMAGE SHALL BE REPAIRED IMMEDIATELY.
- 2. IF CONCENTRATED FLOWS ARE EVIDENT UPHILL OF THE FENCE, THEY MUST BE INTERCEPTED AND CONVEYED TO A SEDIMENT TRAP OR POND.
- 3. IT IS IMPORTANT TO CHECK THE UPHILL SIDE OF THE FENCE FOR SIGNS OF THE FENCE CLOGGING AND ACTING AS A BARRIER TO FLOW AND THEN CAUSING CHANNELIZATION OF FLOWS PARALLEL TO THE FENCE. IF THIS OCCURS, REPLACE THE FENCE OR REMOVE THE TRAPPED SEDIMENT.
- 4. SEDIMENT MUST BE REMOVED WHEN THE SEDIMENT IS 6 INCHES HIGH.
- 5. IF THE FILTER FABRIC (GEOTEXTILE) HAS DETERIORATED DUE TO ULTRAVIOLET BREAKDOWN, IT SHALL BE REPLACED

SILT FENCE DETAIL


NTS

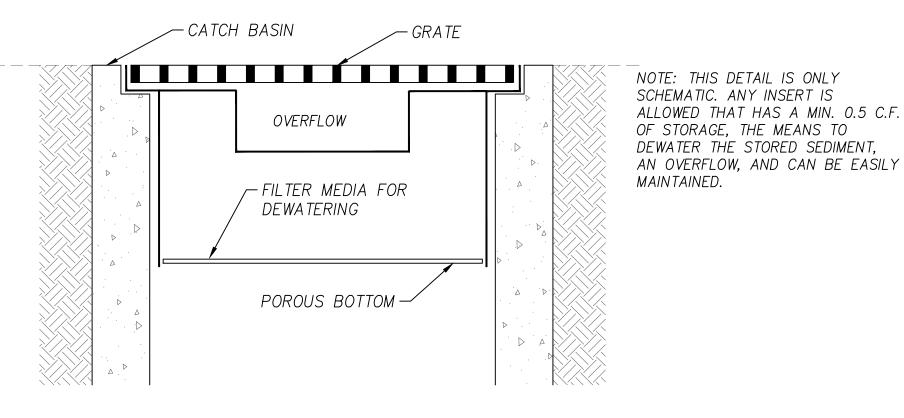

MAINTENANCE STANDARDS

- 1. ANY ACCUMULATED SEDIMENT ON OR AROUND THE FILTER FABRIC PROTECTION SHALL BE REMOVED IMMEDIATELY. SEDIMENT SHALL NOT BE REMOVED WITH WATER, AND ALL SEDIMENT MUST BE DISPOSED OF AS FILL ON—SITE OR HAULED OFF—SITE.
- 2. ANY SEDIMENT IN THE CATCH BASIN INSERT SHALL BE REMOVED WHEN THE INSERT HAS FILLED ONE—THIRD OF THE AVAILABLE STORAGE. THE FILTER MEDIA FOR THE INSERT SHALL BE CLEANED OR REPLACED AT LEAST MONTHLY.
- 3. REGULAR MAINTENANCE IS CRITICAL FOR BOTH FORMS OF CATCH BASIN PROTECTION. UNLIKE MANY FORMS OF PROTECTION THAT FAIL GRADUALLY, CATCH BASIN PROTECTION WILL FAIL SUDDENLY AND COMPLETELY IF NOT MAINTAINED PROPERLY.

CATCH BASIN INSERT DETAIL

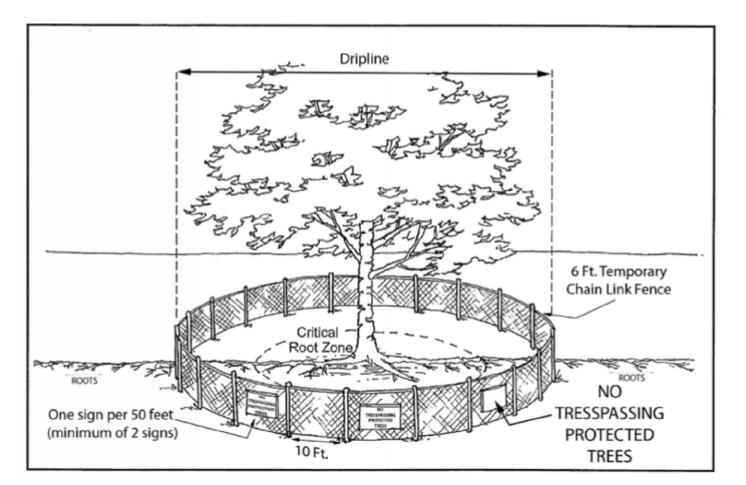

TREE PROTECTION DETAIL

| DESCRIPTION DESCRIPTION BY DATE DATE OF ENCOMPASS ENGINEERING & SURVEYING. | | DATE | | | | тне ркорект |
|---|-----------|--------------|--|--|--|---|
| DESCRIPTION DESCRIPTION (C) THE PLANS SET FORTH ON THIS SHEET ARE AND SHALE OF ENCOMPASS ENGINEERING & SURVEYING. | | ВУ | | | | L REMAIN |
| | REVISIONS | DESCRIP TION | | | | (C) THE PLANS SET FORTH ON THIS SHEET ARE AND SHALL OF ENCOMPASS ENGINEERING & SURVEYING. |



11/18/2024

ELIMINARY SHORT PLA'
10408 420 AVE SE
TESC DETAILS


ENGINEERING & SURVEYIN Western Washington Division uniper Street, Suite 201 Issaquah, WA 98027 Phone: Eastern Washington Division


| JOB NO. | 19655 |
|----------|------------|
| DATE | 11/18/2024 |
| SCALE | N/A |
| DESIGNED | AMD |
| DRAWN | CVP |
| CHECKED | PMS |
| APPROVED | AMD |
| | |

SCALE 1" = 80'


NEVELLE SHORT PLAT


NW 1/4 OF SW 1/4 OF SECTION 3, T. 23 N., R. 8 E., W.M. KING COUNTY, STATE OF WASHINGTON

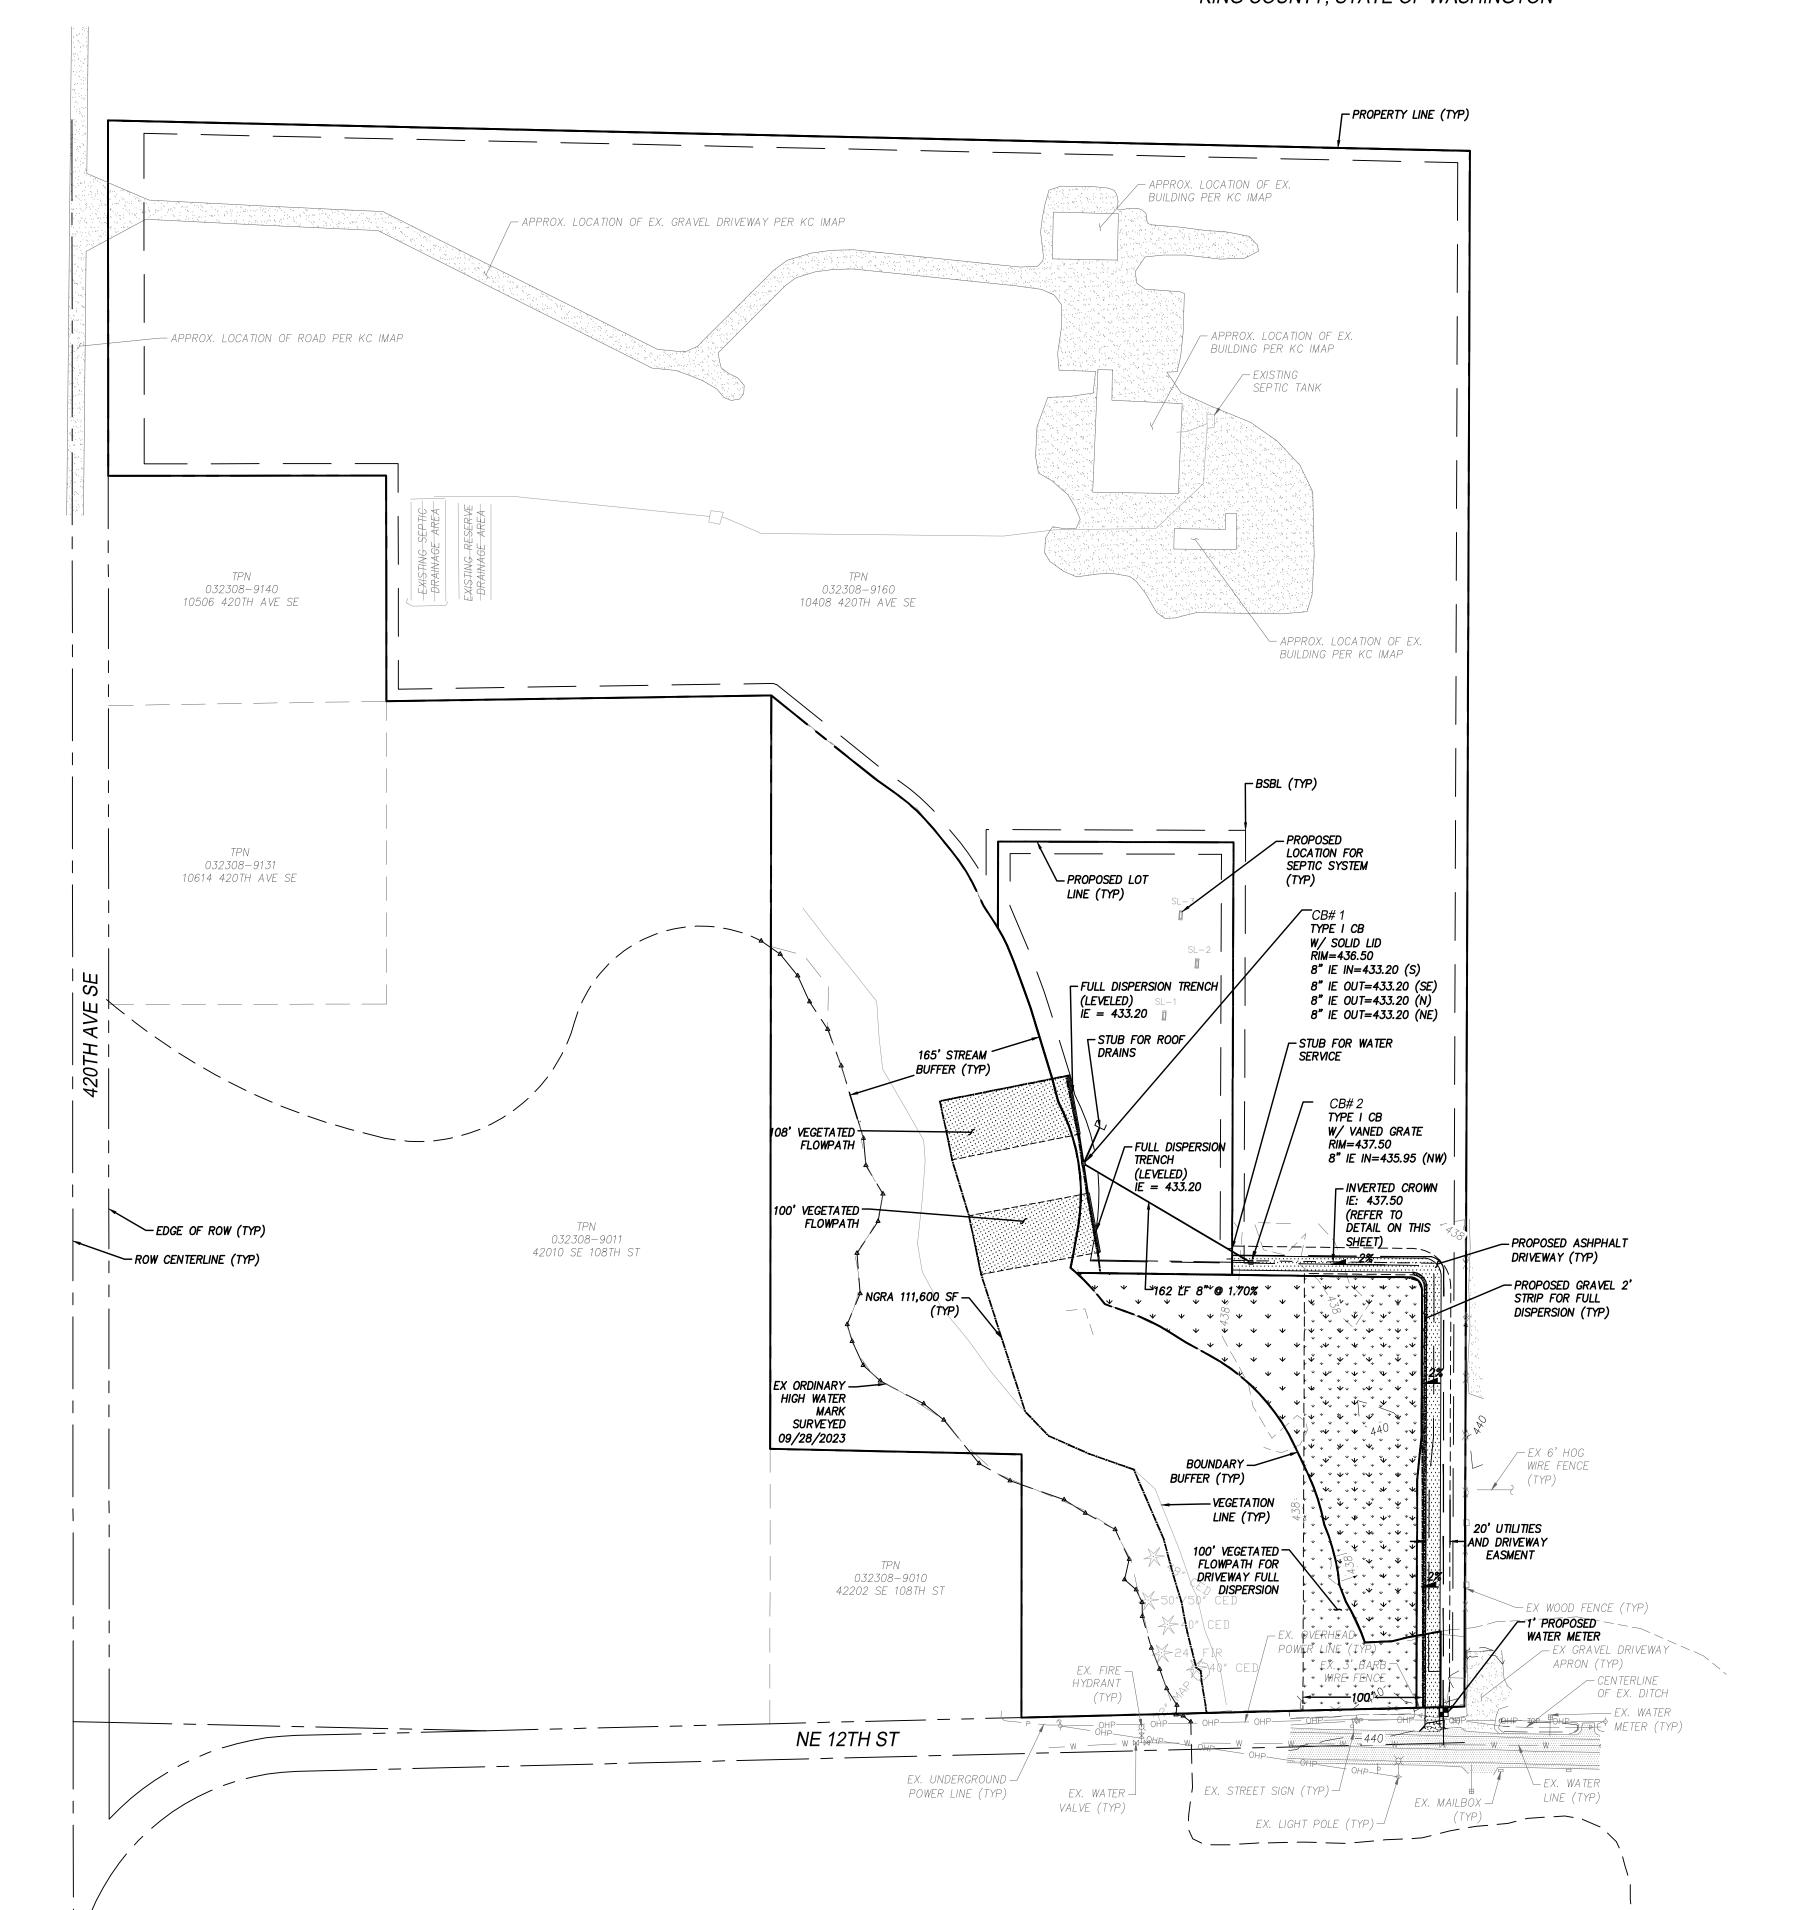

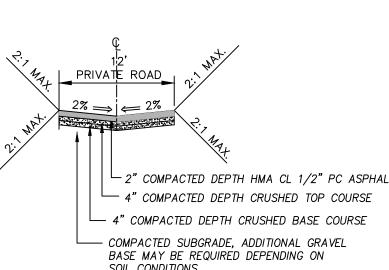

N.T.S.

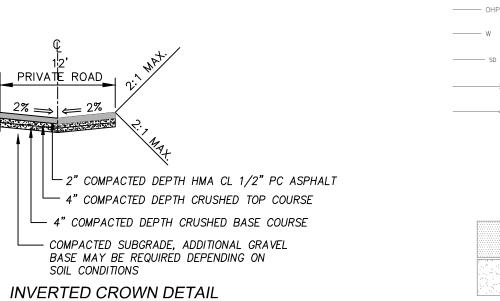

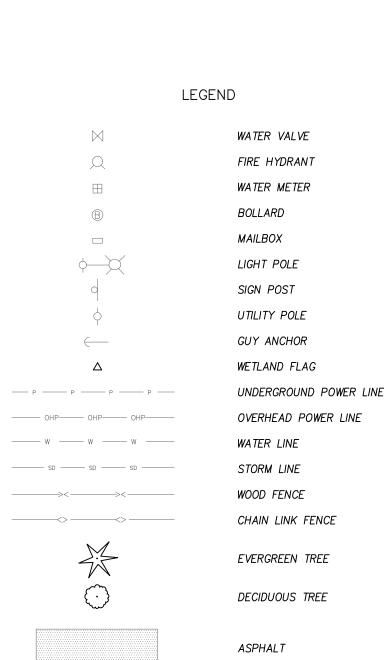





11/18/2024


SHORT

GRAVEL



| JOB NO. | 19655 |
|----------|------------|
| DATE | 11/18/2024 |
| SCALE | 1" = 80' |
| DESIGNED | AMD |
| DRAWN | CVP |
| CHECKED | PMS |
| APPROVED | AMD |
| | |

SHEET 4 of 5

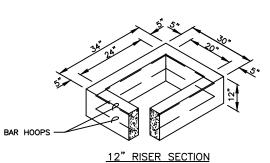

- CATCH BASINS SHALL BE CONSTRUCTED IN ACCORDANCE WITH AASHTO M 199 UNLESS OTHERWISE SHOWN ON PLANS OR NOTED IN
- 2. AS AN ACCEPTABLE ALTERNATIVE TO REBAR, WELDED WIRE FABRIC HAVING A MIN. AREA OF 0.12 SQ. IN. PER FT. MAY BE USED. WELDED WIRE FABRIC SHALL COMPLY TO ASTM A497 (ASHTO M 221). WIRE FABRIC SHALL AND TO BE DIAGREE MAY RE SHALL NOT BE PLACED IN KNOCKOUTS.
- 3. ALL REINFORCED CAST-IN-PLACE CONCRETE SHALL BE
- 4. PRECAST BASES SHALL BE FURNISHED WITH CUTOUTS OR KNOCKOUTS. KNOCKOUTS SHALL HAVE A WALL THICKNESS OF 2 IN. MIN. ALL PIPE SHALL BE INSTALLED IN FACTORY PROVIDED KNOCKOUTS. UNUSED KNOCKOUTS NEED NOT
- BE GROUTED IF WALL IS LEFT INTACT. 5. KNOCKOUT OR CUTOUT HOLE SIZE IS EQUAL TO PIPE
- OUTER DIAM. PLUS CATCH BASIN WALL THICKNESS. 6. ROUND KNOCKOUTS MAY BE ON ALL 4 SIDES, WITH MAX.

DIAM. OF 20 IN. KNOCKOUTS MAY BE EITHER ROUND OR

- 7. THE MAX. DEPTH FROM THE FINISHED GRADE TO THE
- 8. THE TAPER ON THE SIDES OF THE PRECAST BASE SECTION AND RISER SECTION SHALL NOT EXCEED 1/2" PER FT.
- 9. CATCH BASIN FRAME AND GRATE SHALL BE IN ACCORDANCE WITH STANDARD SPECIFICATIONS AND MEET THE STRENGTH REQUIREMENTS OF FEDERAL SPECIFICATION RR-F-62IE. MATING SURFACES SHALL BE FINISHED TO ASSURE NON-ROCKING FIT WITH ANY COVER POSITION.
- 10. FRAME AND GRATE MAY BE INSTALLED WITH FLANGE DOWN OR CAST INTO RISER.
- 11. FOR CATCH BASINS IN PARKING LOTS REFER TO WSDOT/APWA STANDARD DWG. B-5.60-01.
- 12. EDGE OF RISER OR BRICK SHALL NOT BE MORE THAN 2 IN. FROM VERTICAL EDGE OF CATCH BASIN WALL.
- 13. SEE THE WSDOT/APWA STANDARD SPECIFICATIONS SECTION 9-05.15 FOR METAL CASTINGS REQUIREMENTS.

CATCH BASIN TYPE 1

7-8


FIG. 7-003

Department of Transportation Road Services Division

7-20

FIG. 7-015 SOLID COVER


23 3/4" RECESSED TO BE FLUSH 5 - LEVELING PAD 8 - 1/8" X 3/4" X 1 3/4"

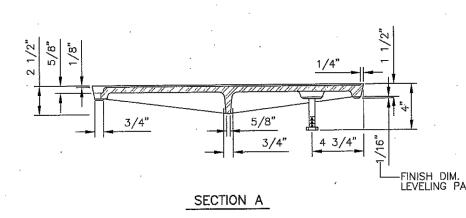

PLAN COVER

- 1. USE WITH FRAME (FIG. 7-014) DRILLED AND TAPPED FOR LOCKING BOLTS.
- 2. USE WITH TWO LOCKING BOLTS 5/8 IN.-11 NC STAINLESS STEEL TYPE 304 STEEL SOCKET HEAD (ALLEN HEAD) CAP SCREWS, MIN. 2 IN. LONG.
- 3. MATERIAL IS CAST IRON PER ASTM A48 CLASS 30.
- 4. SEE SEC. 7.05.
- (5) THE WORDS "PROPERTY OF KING COUNTY" SHALL BE OMITTED IF COVER IS ON A PRIVATE SYSTEM.
- 6. SEE WSDOT/APWA STANDARD SPECIFICATIONS SECTION 9-05.15 FOR METAL CASTINGS REQUIREMENTS.

2021 Surface Water Design Manual – Appendix C

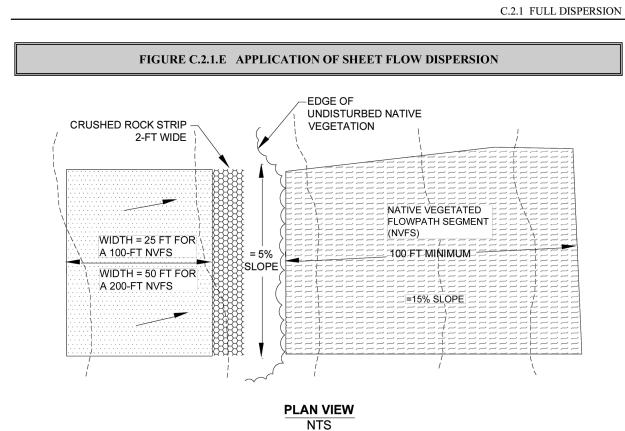

C-43

30' MAX. EDGE OF SHOULDER — COMM./INDUSTR. 25' MIN. 35' MAX. EDGE OF PAVEMENT-SHOULDER PAVING AREA -0.02 FT./FT. 0.02-FT./FT. EXISTING GRADE SECTION A

(1) WITHIN THE RIGHT-OF-WAY DRIVEWAYS SHALL BE PAVED FROM THE RIGHT-OF-WAY LINE TO THE EDGE OF PAVEMENT WITH HOT MIX ASPHALT. NO CONCRETE IS ALLOWED WITHIN THE RIGHT-OF-WAY UNLESS AS SPECIFIED IN SEC.4.02.

RIGHT-OF-WAY

LINE -

- 2. COMMERCIAL/INDUSTRIAL DRIVEWAYS WIDER THAN 35 FT. MAY BE APPROVED BY THE COUNTY ROAD ENGINEER CONSIDERING BOTH TRAFFIC SAFETY AND THE ACTIVITY BEING SERVED. ALL COMMERCIAL/INDUSTRIAL DRIVEWAYS SHALL HAVE AN EXPANSION JOINT LOCATED MID-WIDTH. (SEE SEC. 3.04.) 8.
- 3. PIPE SHALL BE: A. SIZED TO CONVEY COMPUTED STORM WATER RUNOFF,
- B. MIN. 12" DIAM., AND C. EQUAL TO OR LARGER THAN EXISTING PIPES WITHIN
- 500 FT. UPSTREAM. 4. EXPOSED PIPE ENDS SHALL BE BEVELED TO MATCH THE SLOPE FACE AND PROJECT NO MORE THAN 2" BEYOND SLOPE SURFACE. PROJECTING HEADWALLS ARE NOT ACCEPTABLE.
- 5. ALL TYPES OF PIPE SHALL HAVE MIN. 12" COVER TO FINISH GRADE.
- 6. PIPE SHALL BE INSTALLED IN A STRAIGHT UNIFORM ALIGNMENT AT A MIN. 0.5% SLOPE (0.5 FT. PER 100 FT.) WITH THE DOWNSTREAM END LOWER THAN THE UPSTREAM END.
- PIPE MAY BE OMITTED IF ROADSIDE DITCH DOES NOT EXIST AND DRIVEWAY DOES NOT BLOCK NATURAL FLOW.
- DRIVEWAY SLOPE SHALL MATCH TO BACK EDGE OF SHOULDER, BUT SHOULDER SLOPE AND EDGE OF SHOULDER SHALL NOT BE ALTERED AS A RESULT OF DRIVEWAY CONSTRUCTION.
- 9. SEE SEC. 3.01 AND 4.01 FOR DRIVEWAY AND SURFACING STANDARDS. 10. PIPING OF DITCHES SHALL BE ALLOWED ONLY WHERE DRIVEWAY ACCESS IS NECESSARY.

Department of Transportation Road Services Division 2016 Design and 2016 Design and King County Construction Standards

SHOULDER AND DITCH SECTION DRIVEWAY FIG. 3-003

11/18/2024

DE

TION

TRUC

S

19655

11/18/2024

N/A

AMDCVP

PMS

AMD

DATE

SCALE

DESIGNED

APPROVED

DRAWN CHECKED

SHEET

SHOR

ELIMINAR

DRIVEWAY WIDTH

RESIDENTIAL

7/23/2021


3-14

Department of Transportation

Road Services Division

2016 Design and y Construction Standards

SECTION C.2 FLOW CONTROL BMPs

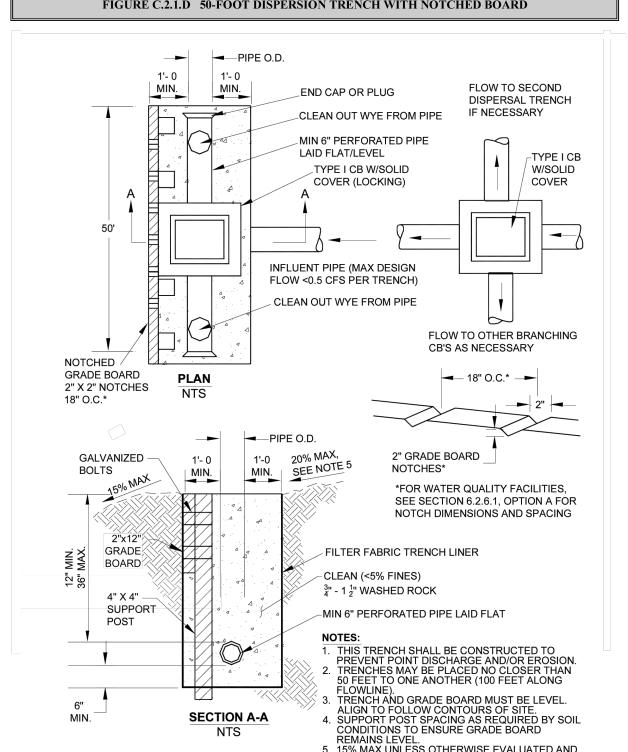



Know what's **below.** Call before you dig.

5. 15% MAX UNLESS OTHERWISE EVALUATED AND APPROVED, SEE SECTION C.2.1.1